

HORRY COUNTY BUYOUT DEMOLITION

FOR

SOUTH CAROLINA OFFICE OF RESILIENCE

SC OSE PROJECT NUMBER: D30-N027-MJ

DRAWING INDEX	
CIVIL	
C0.0	COVER SHEET
C1.0	OVERALL DEMOLITION LAYOUT PHASE 1
C2.1-C2.9	DEMOLITION PLANS - PHASE 1
C3.0	OVERALL DEMOLITION LAYOUT PHASE 2
C3.1-C3.9	DEMOLITION PLANS - PHASE 2
C4.1-C4.2	DETAILS AND NOTES

LEGEND AND ABBREVIATIONS

SF

—

SILT FENCE

X

ITEMS TO BE DEMOLISHED

GENERAL DEMOLITION AREA

IRF

IRON ROD FOUND, SIZE AS NOTED

IPF

IRON PIPE FOUND, SIZE AS NOTED

IRS

IRON ROD SET, SIZE AS NOTED

EXST.

EXISTING

CABLE BOX

X

FENCE

MH

MANHOLE

WM

WATER METER

PP


POWER POLE

CLEANOUT

HOUSE STRUCTURE

E.O.W.

EDGE OF WATER / WETLAND

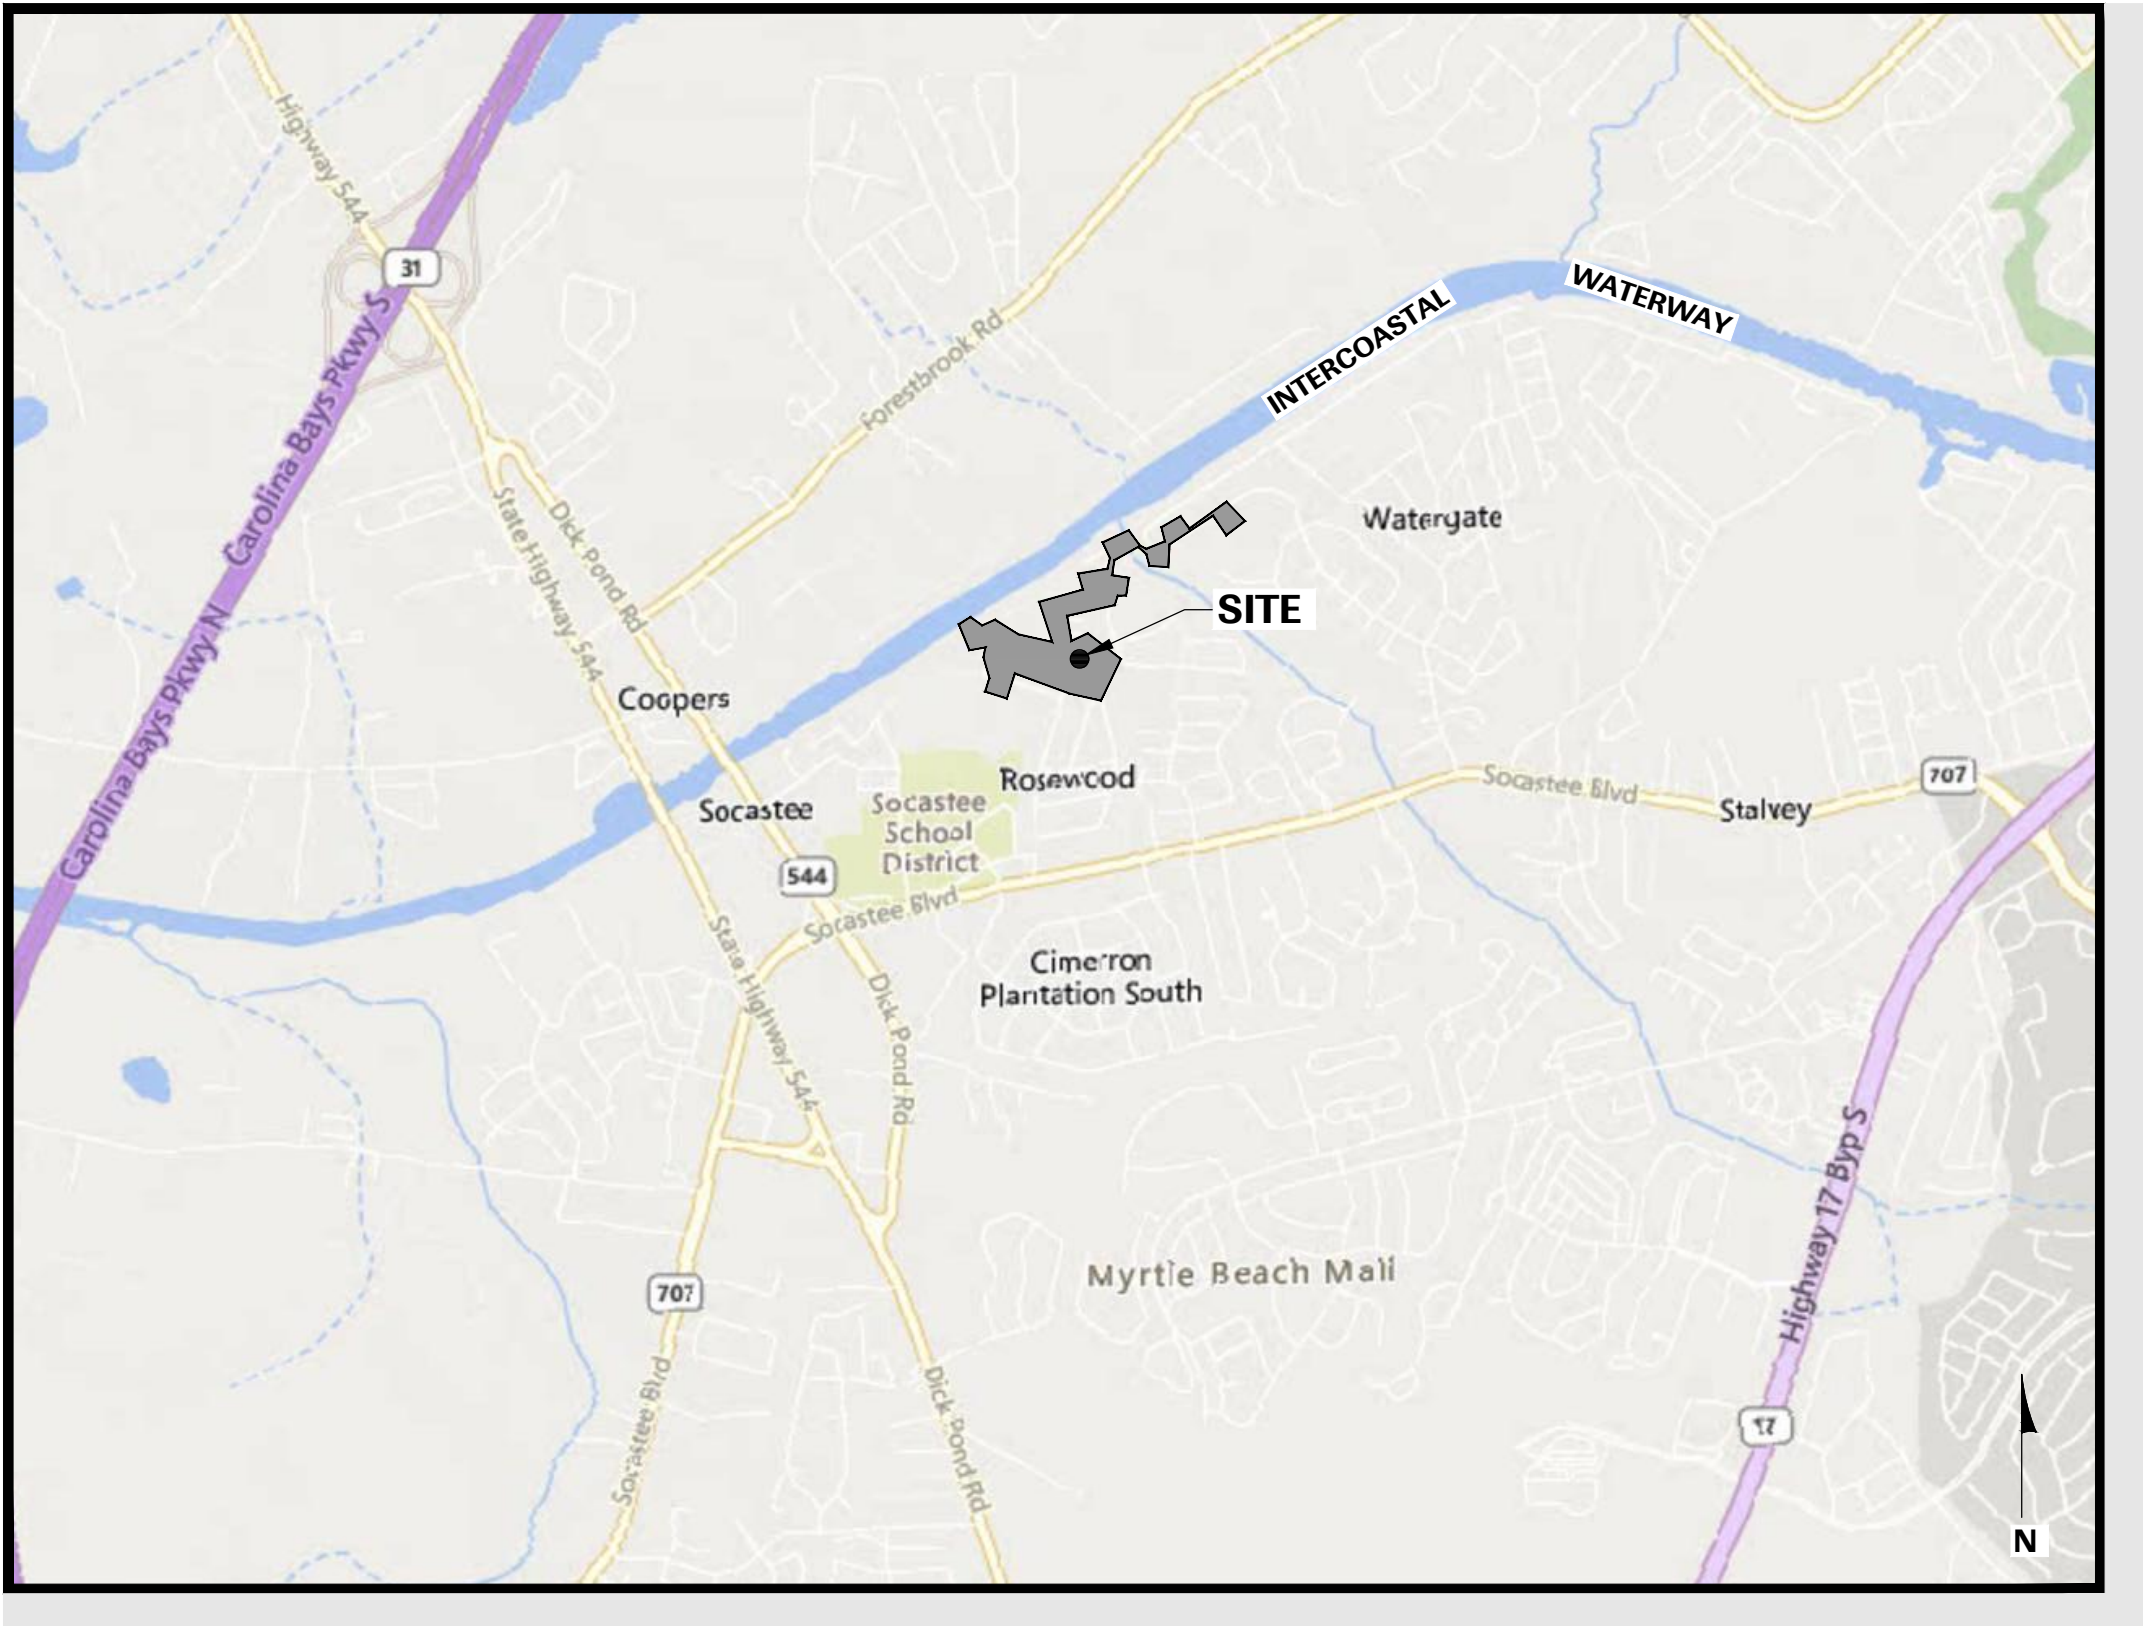

SITE MAP
SCALE: 1"=2,000'



DHEC Permit # SCR10ZESU
Date Issued 3/7/24
Reviewer _____


Approved for Construction

Thomas B. Roth CSPP #110
Horry County Stormwater

APPROVED
By Brandon Wagner at 9:14 am, Mar 04, 2024

SOUTH CAROLINA OFFICE OF RESILIENCE
ATTN: NANCY MIRAMONTI
632 ROSEWOOD DRIVE
COLUMBIA, SC 29201
NANCY.MIRAMONTI@SCOR.SC.GOV
Phone: (803) 667-7360

ELR PROJECT NUMBER: 1823005
JANUARY 2024

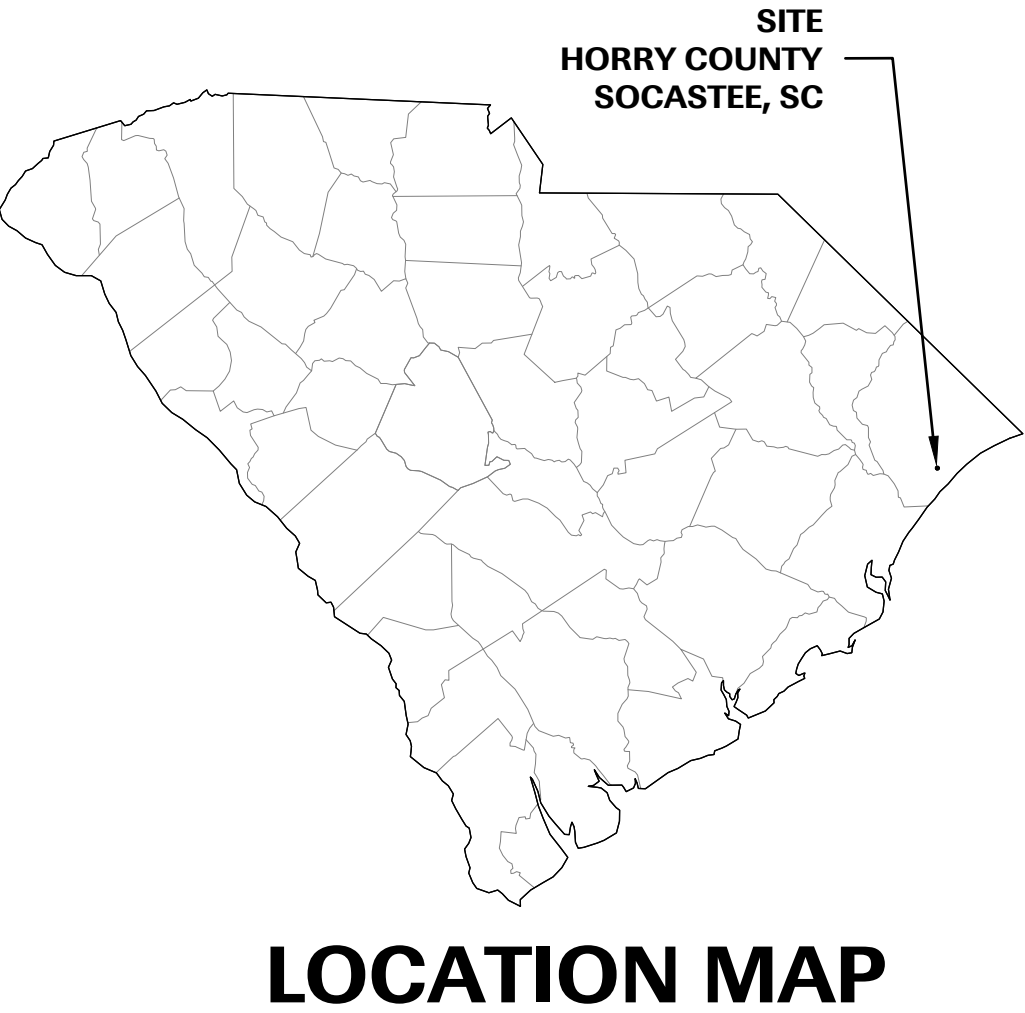

LOCATION MAP

The Palmetto Utility Protection Service, Inc.
810 Dutch Square Boulevard, Suite 320 Columbia, South Carolina 29210 Voice (803) 939-1117 Fax (803) 939-0704

3 DAYS BEFORE DIGGING IN
SOUTH CAROLINA
CALL 1-888-721-7877
UNDERGROUND LOCATORS.
CONTRACTOR SHALL CONTACT
THE UNDERGROUND LOCATORS
EVERY 10 DAYS FOR AN UPDATE
TO UTILITY LOCATIONS.
Call BEFORE you DIG!

ZONING CERTIFICATION

"I hereby certify that, to the best of my knowledge, these plans comply with applicable zoning ordinances, and that plans have been submitted to appropriate authority for their review and/or approval."

Signed: _____ Date: 01.29.2024
Engineer

EROSION AND SEDIMENT REDUCTION/STORMWATER MANAGEMENT

Designer's Certification:
"I hereby certify that the measures in this plan are designed to control erosion, retain sediment on the site, and manage stormwater in a manner that neither any on-site nor off-site damage or problem is caused or increased, that all structural measures are designed to the minimum standards for health and safety, and that all the provisions of the plan are in compliance with the Regulations contained in Chapter 72, Article 2, SC Code of Regulations (Erosion and Sediment Reduction and Stormwater Management Regulations)."

Signed: _____ Date: 01.29.2024
Engineer

PROJECT COORDINATES

LATITUDE: 33° 41' 00" N
LONGITUDE: 78° 59' 00" W

DRAWN:
CWS

CHECKED:
DKB

APPROVED:
DKB

SEAL:

COA:

SHEET NO.
C0.0

PROJECT NO.
D30-N027-MJ

**E.L. ROBINSON
ENGINEERING**

1301 Gervais St., Suite 450
Columbia, SC 29201
Phone: (803) 400-6031
www.elrobinsonengineering.com



CONSTRUCTION SEQUENCE

THE TOTAL PROJECT INCLUDES DEMOLITION OF 33 SINGLE FAMILY HOMES AND APPURTENANCES TOTALING 8.5 AC. CONTRACTOR IS LIMITED TO A MAXIMUM OF 0.8 AC. OF DISTURBANCE (APPROXIMATELY 3 HOMES) AT ONE TIME. THE HOMES SITES ARE TO BE DEMOLISHED, GRADED, GRASSED AND FINAL STABILIZATION STARTED BEFORE MOVING TO ANOTHER SET OF 3 HOMES TO LIMIT THE IMPACT TO THE COMMUNITY.



ITEMS MUST OCCUR IN THE ORDER LISTED; ITEMS CANNOT OCCUR CONCURRENTLY UNLESS SPECIFICALLY NOTED.

1. OBTAIN OCRM AND SCDHEC APPROVALS.
2. PRE-CONSTRUCTION MEETING WILL NEED TO BE HELD WITH COUNTY, OCRM/SCDHEC, AND SCOR STAFF PRIOR TO BEGINNING WORK (ON-SITE IF MORE THAN 10 DISTURBED AND NON-LINEAR).
3. NOTIFY COUNTY, OCRM/SCDHEC, AND SCOR OFFICES 48 HOURS PRIOR TO BEGINNING LAND DISTURBING ACTIVITIES.
4. INSTALLATION OF CONSTRUCTION ENTRANCE(S) AT EXISTING DRIVEWAYS LAYING STONE ON THE EXISTING ASPHALT AS A MEANS FOR REMOVING AND PREVENTING TRACKING OF SOIL FROM THE DEMOLITION SITE.
5. CLEARING & GRUBBING ONLY AS NECESSARY FOR INSTALLATION OF PERIMETER CONTROLS.
6. INSTALLATION OF PERIMETER CONTROLS (SILT FENCE).
7. INSTALLATION OF INLET PROTECTIONS IN THE VICINITY OF THE DEMOLITION.

GO TO PHASE 2

LEGEND

HOUSES TO BE DEMOLISHED

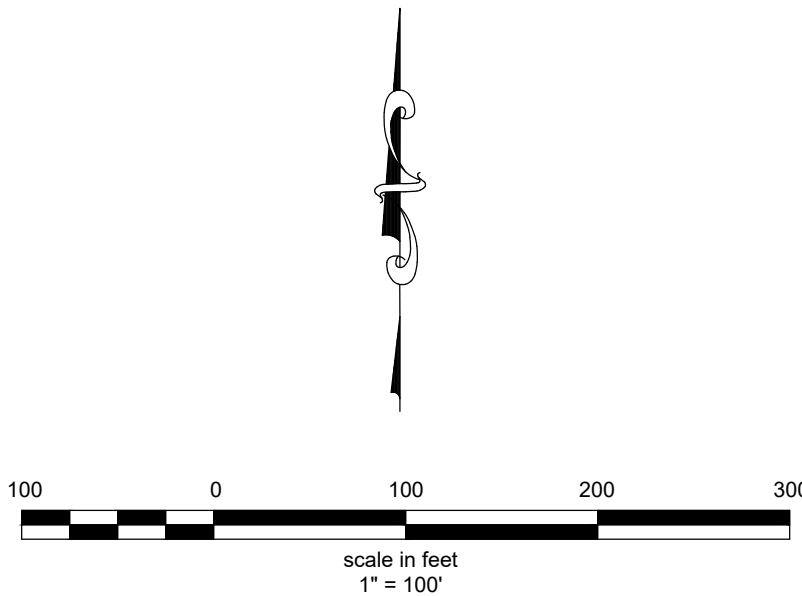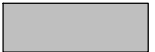

HORRY COUNTY BUYOUT DEMOLITION

SOUTH CAROLINA OFFICE OF RESILIENCE
HORRY COUNTY, SOUTH CAROLINA



Project Title / Client Information

Drawing Title	Drawing No.	Revisions	No.	Name	Date
OVERALL DEMOLITION LAYOUT PHASE 1	C1.0				

Drawing Information	Project No.	Drawn By	Date	Checked By	Date	Approved By
Project No. 030-N027-M			09.08.23	DKB	09.08.23	DKB





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C1.0



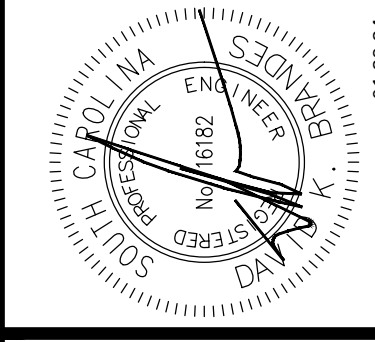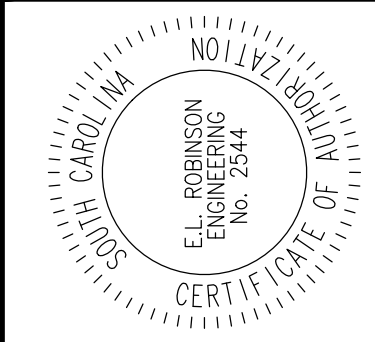



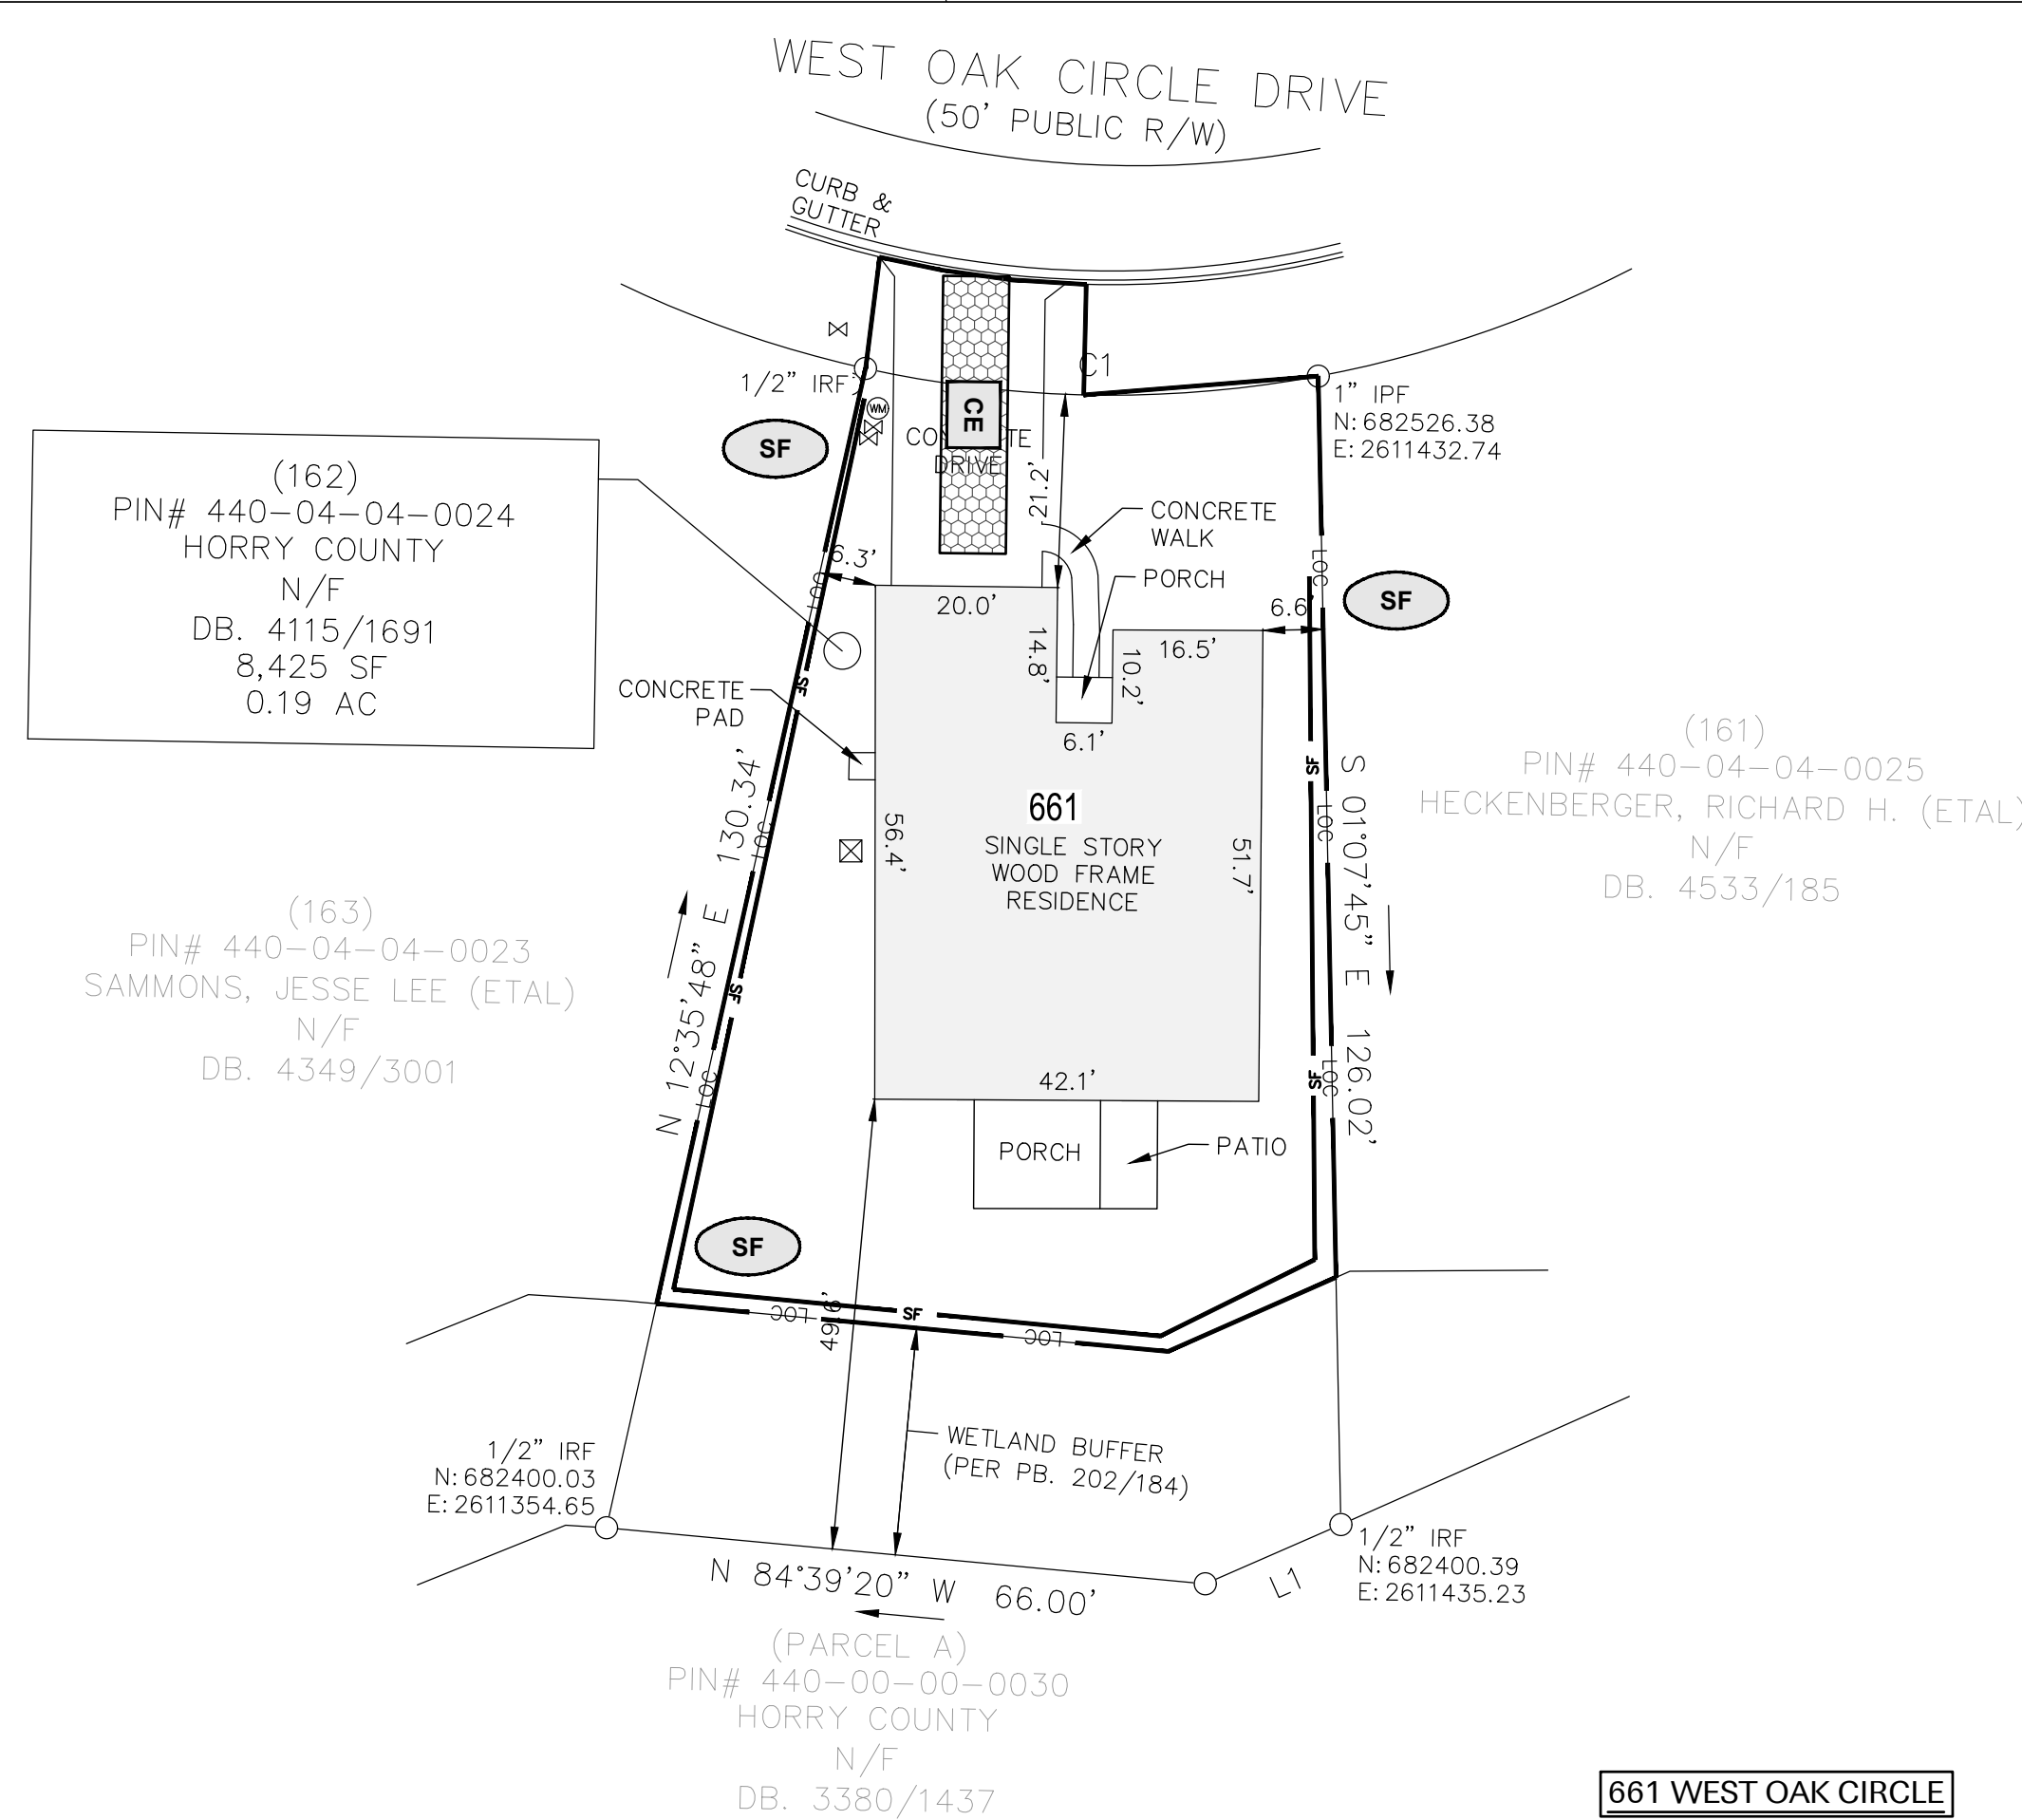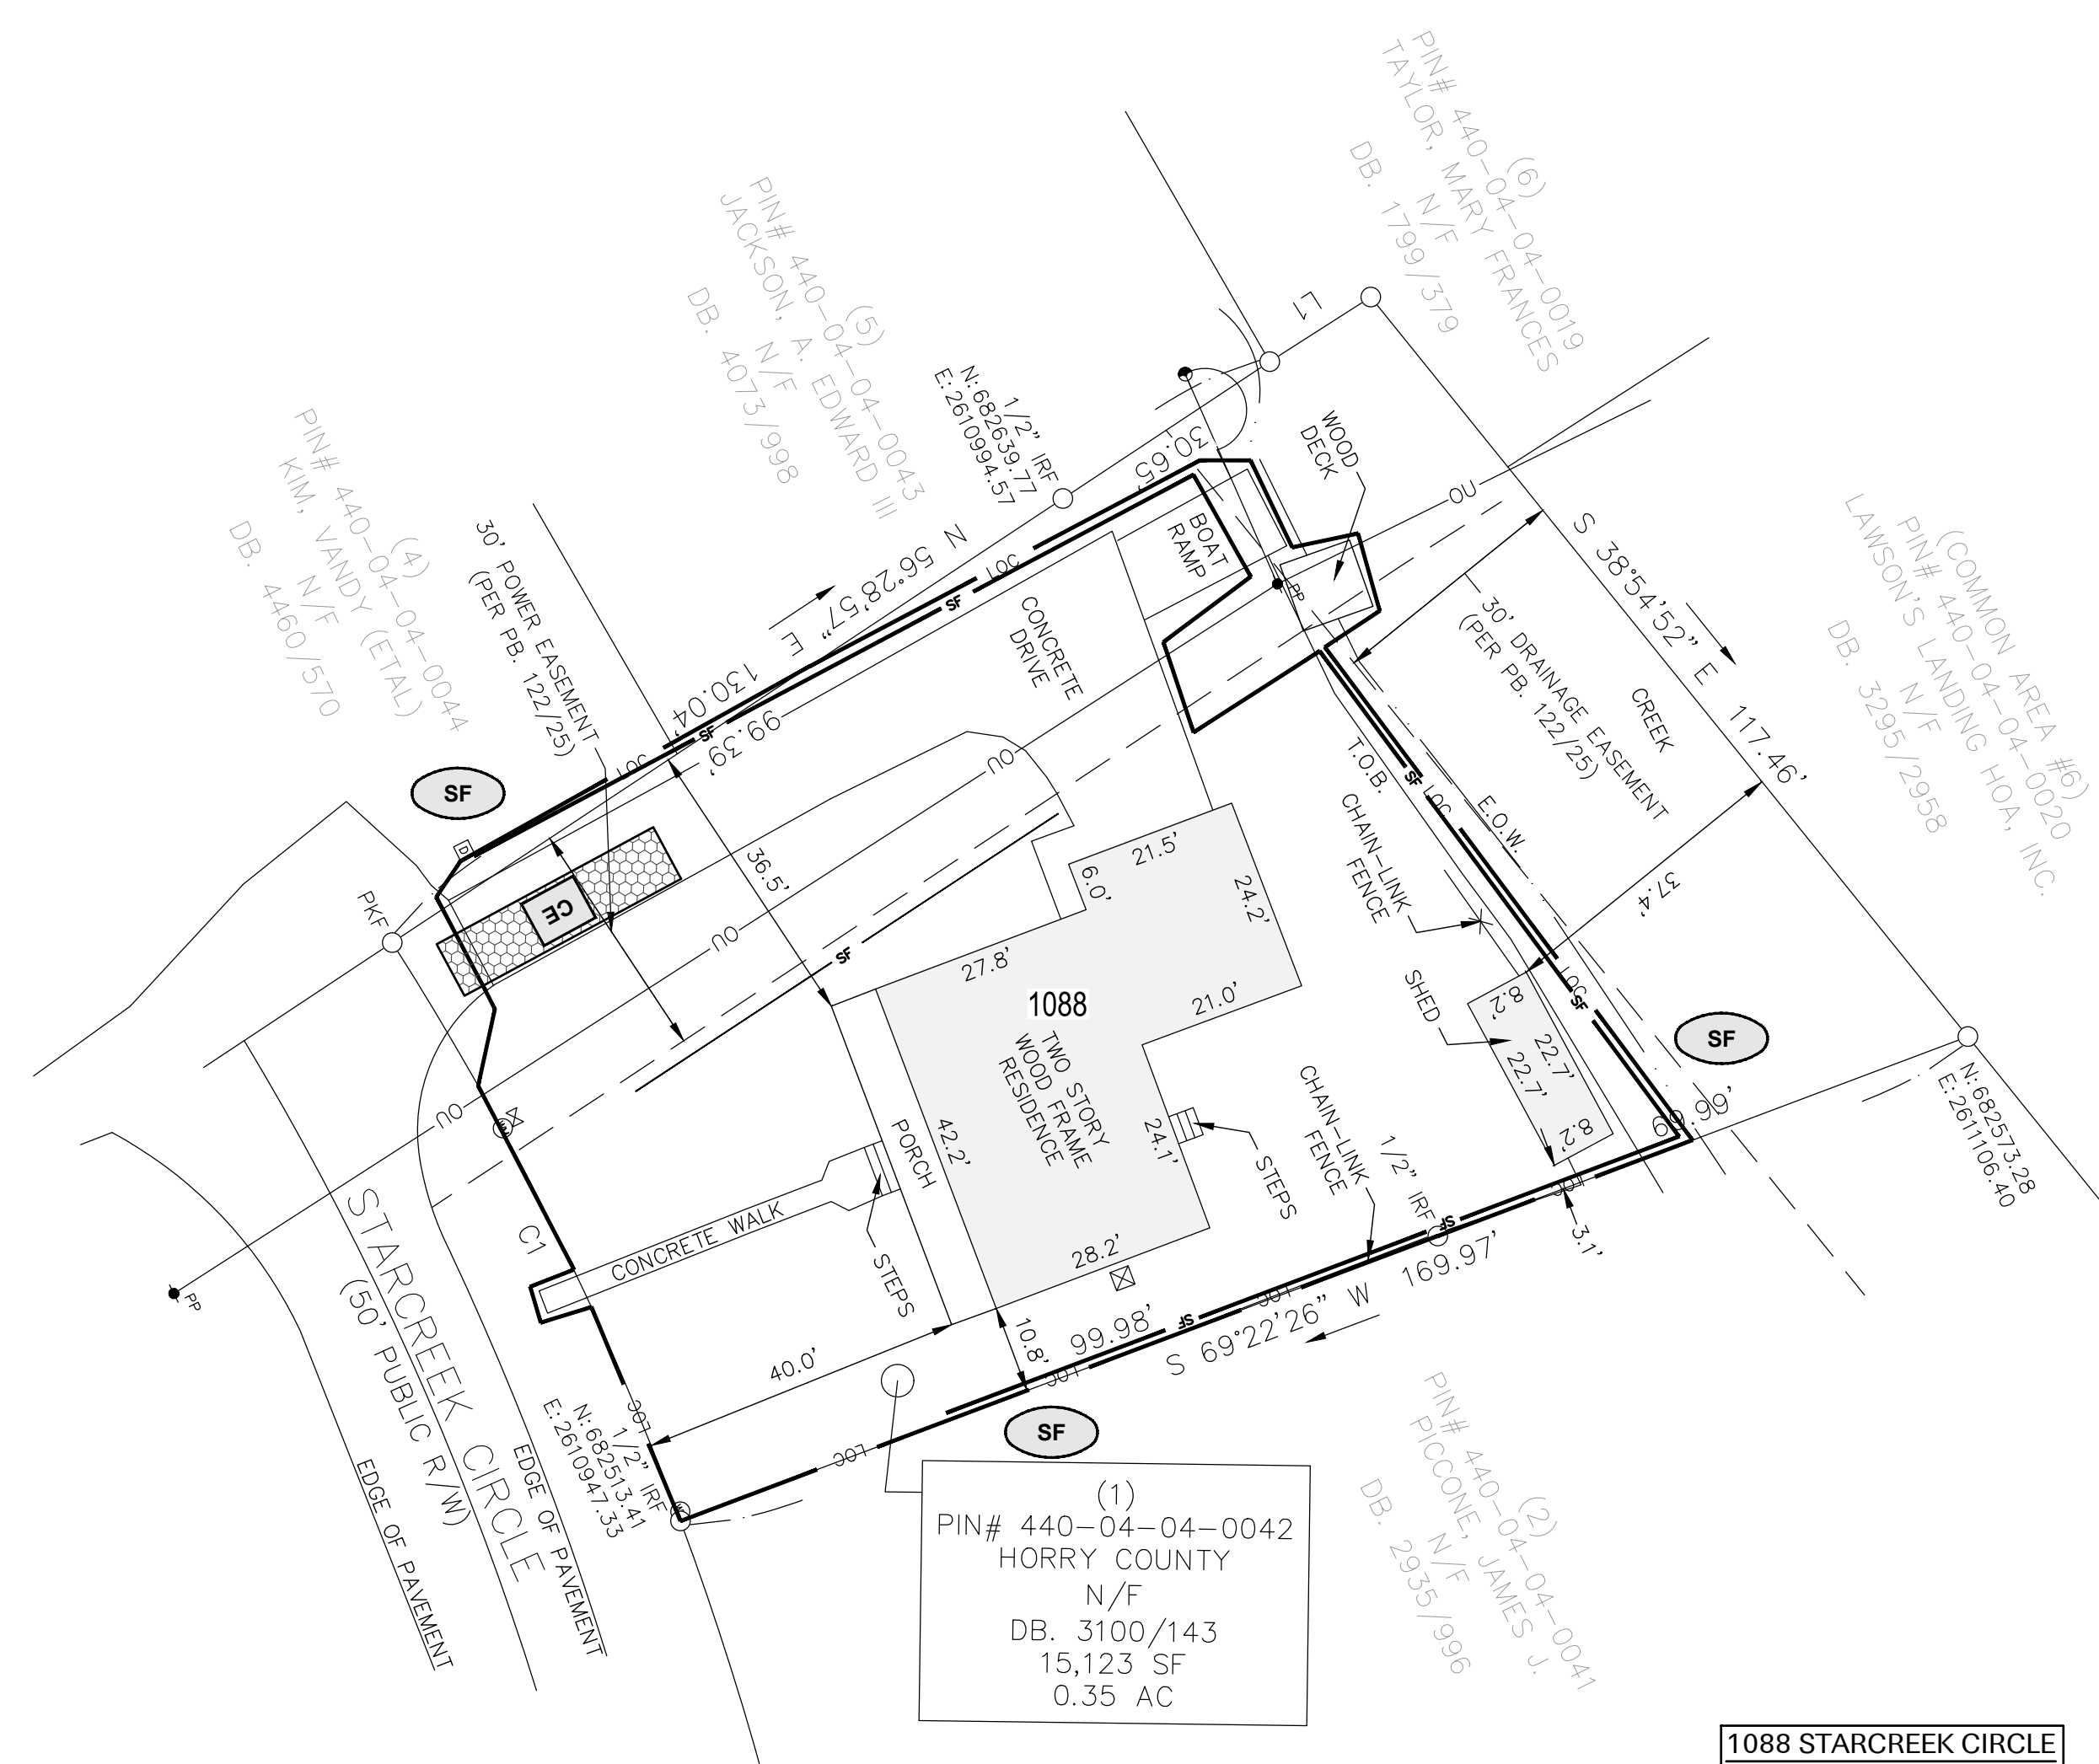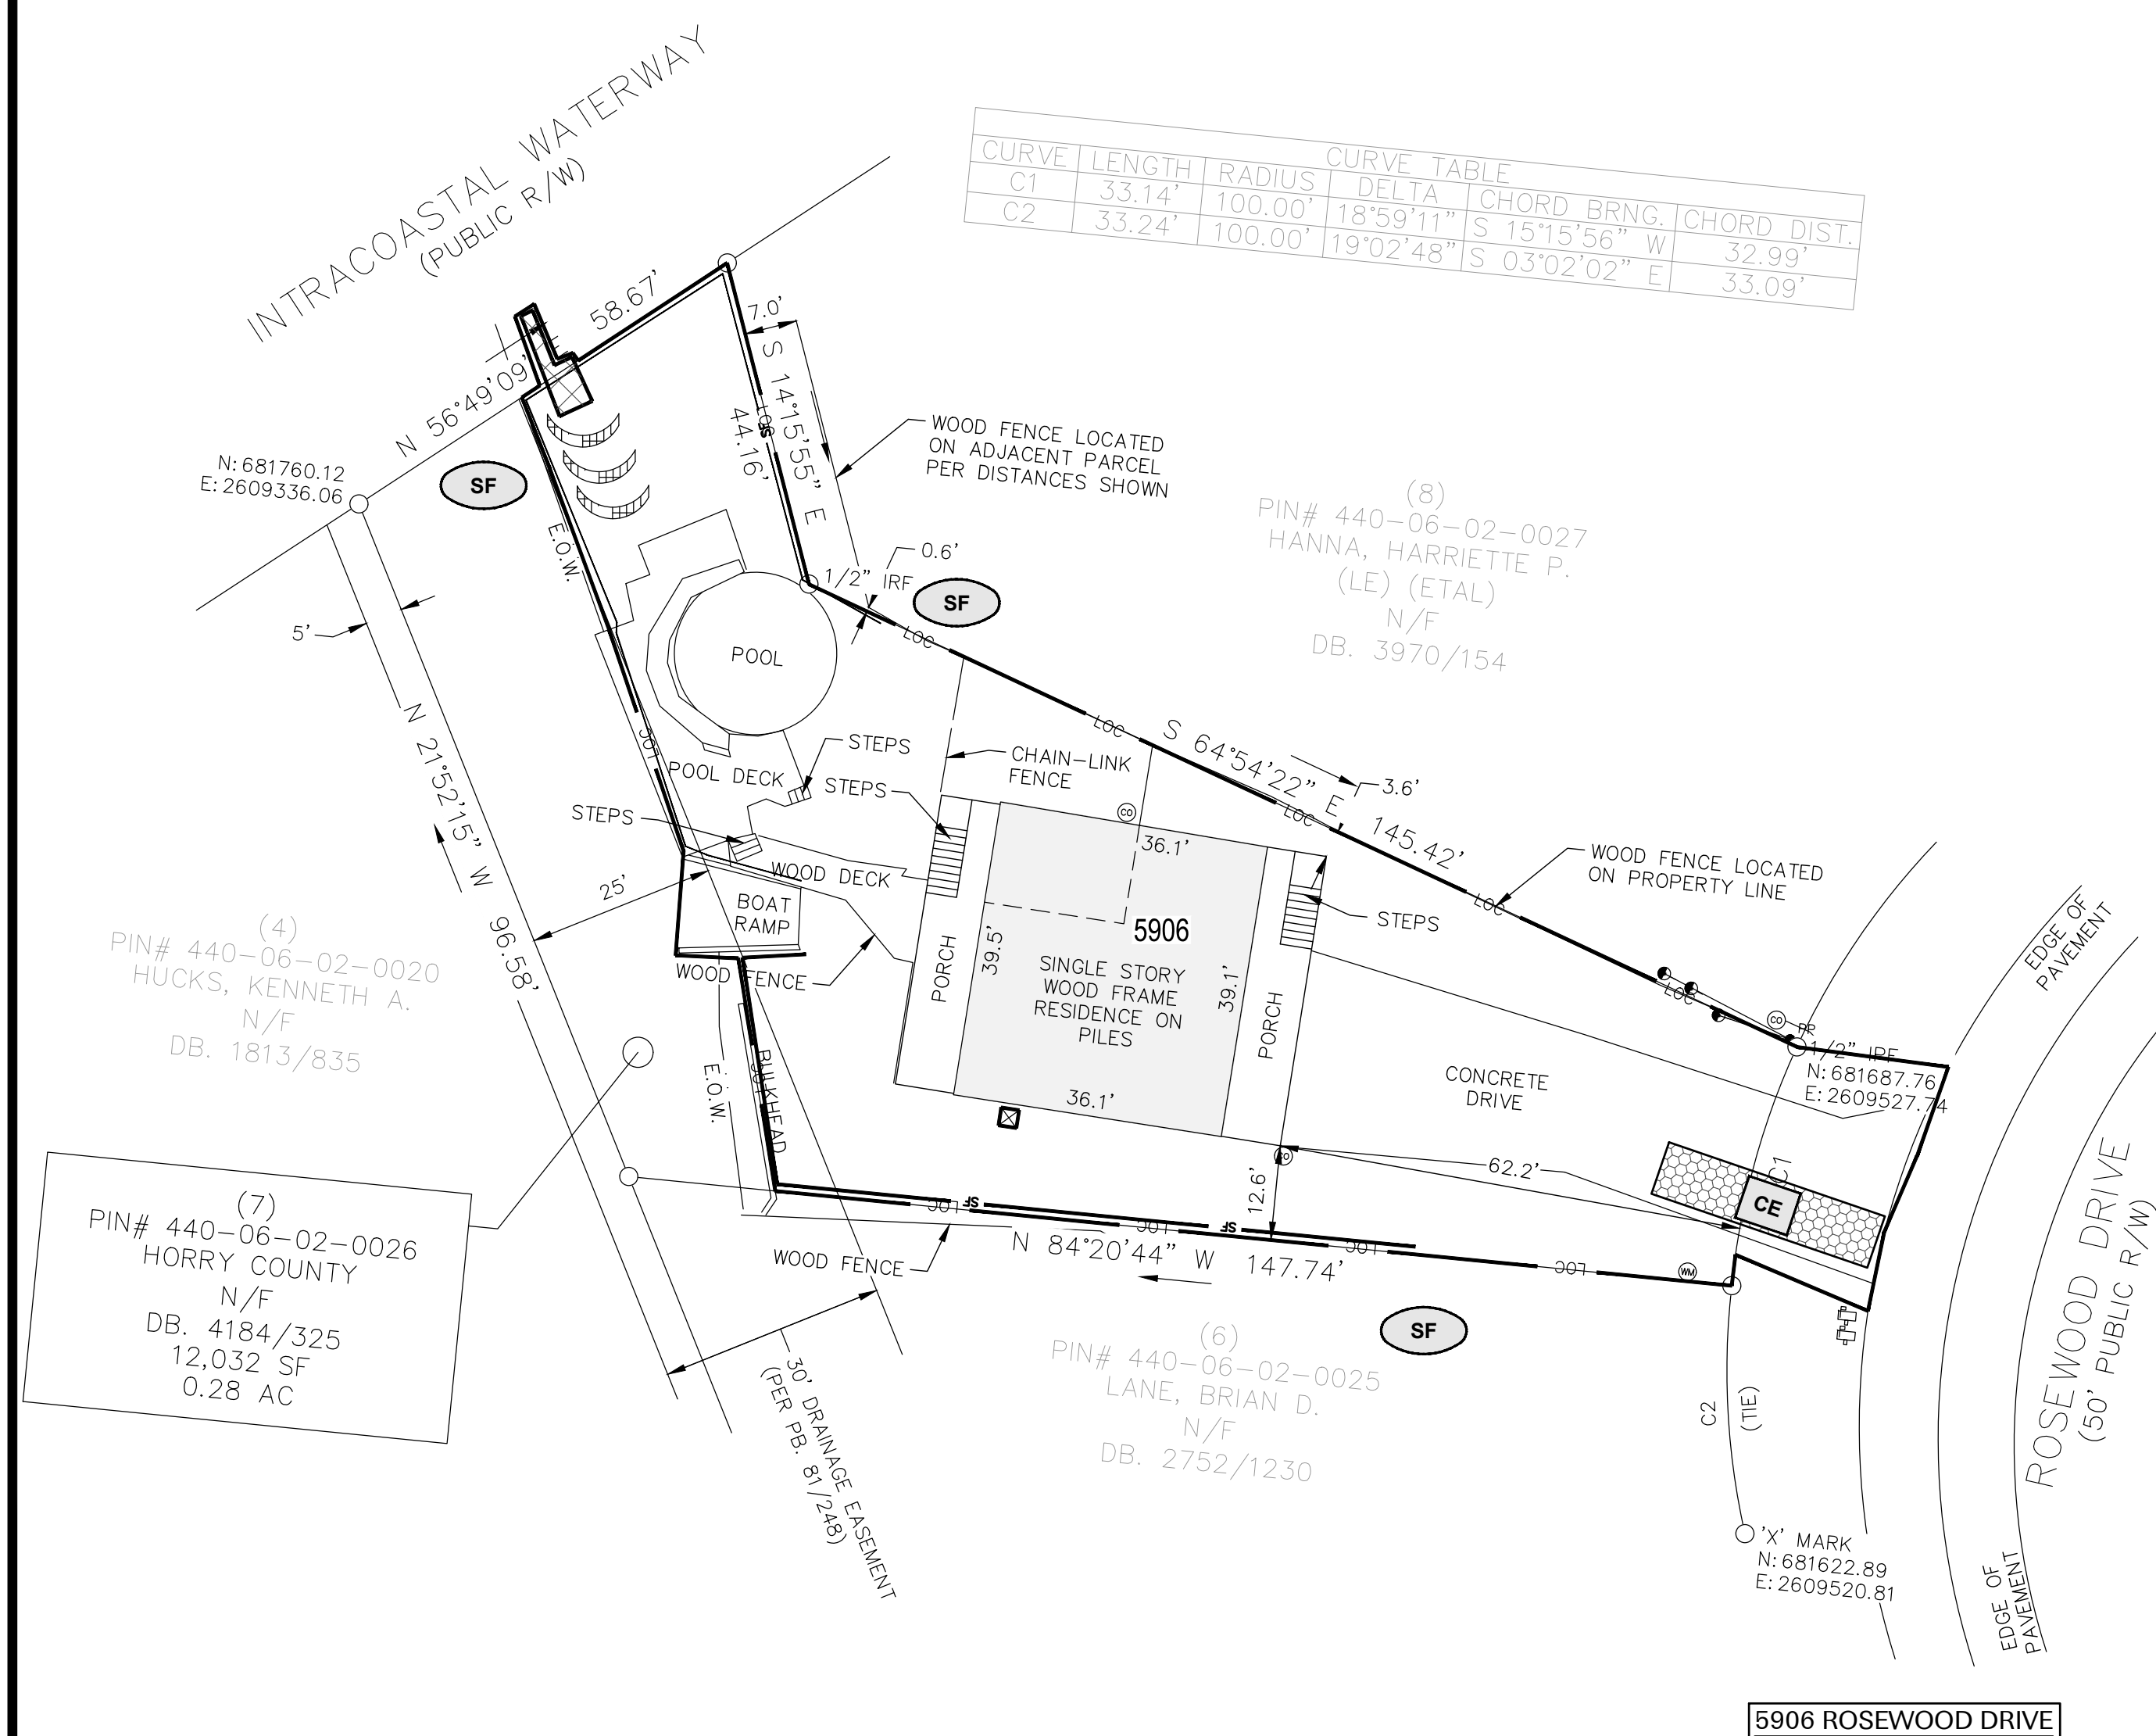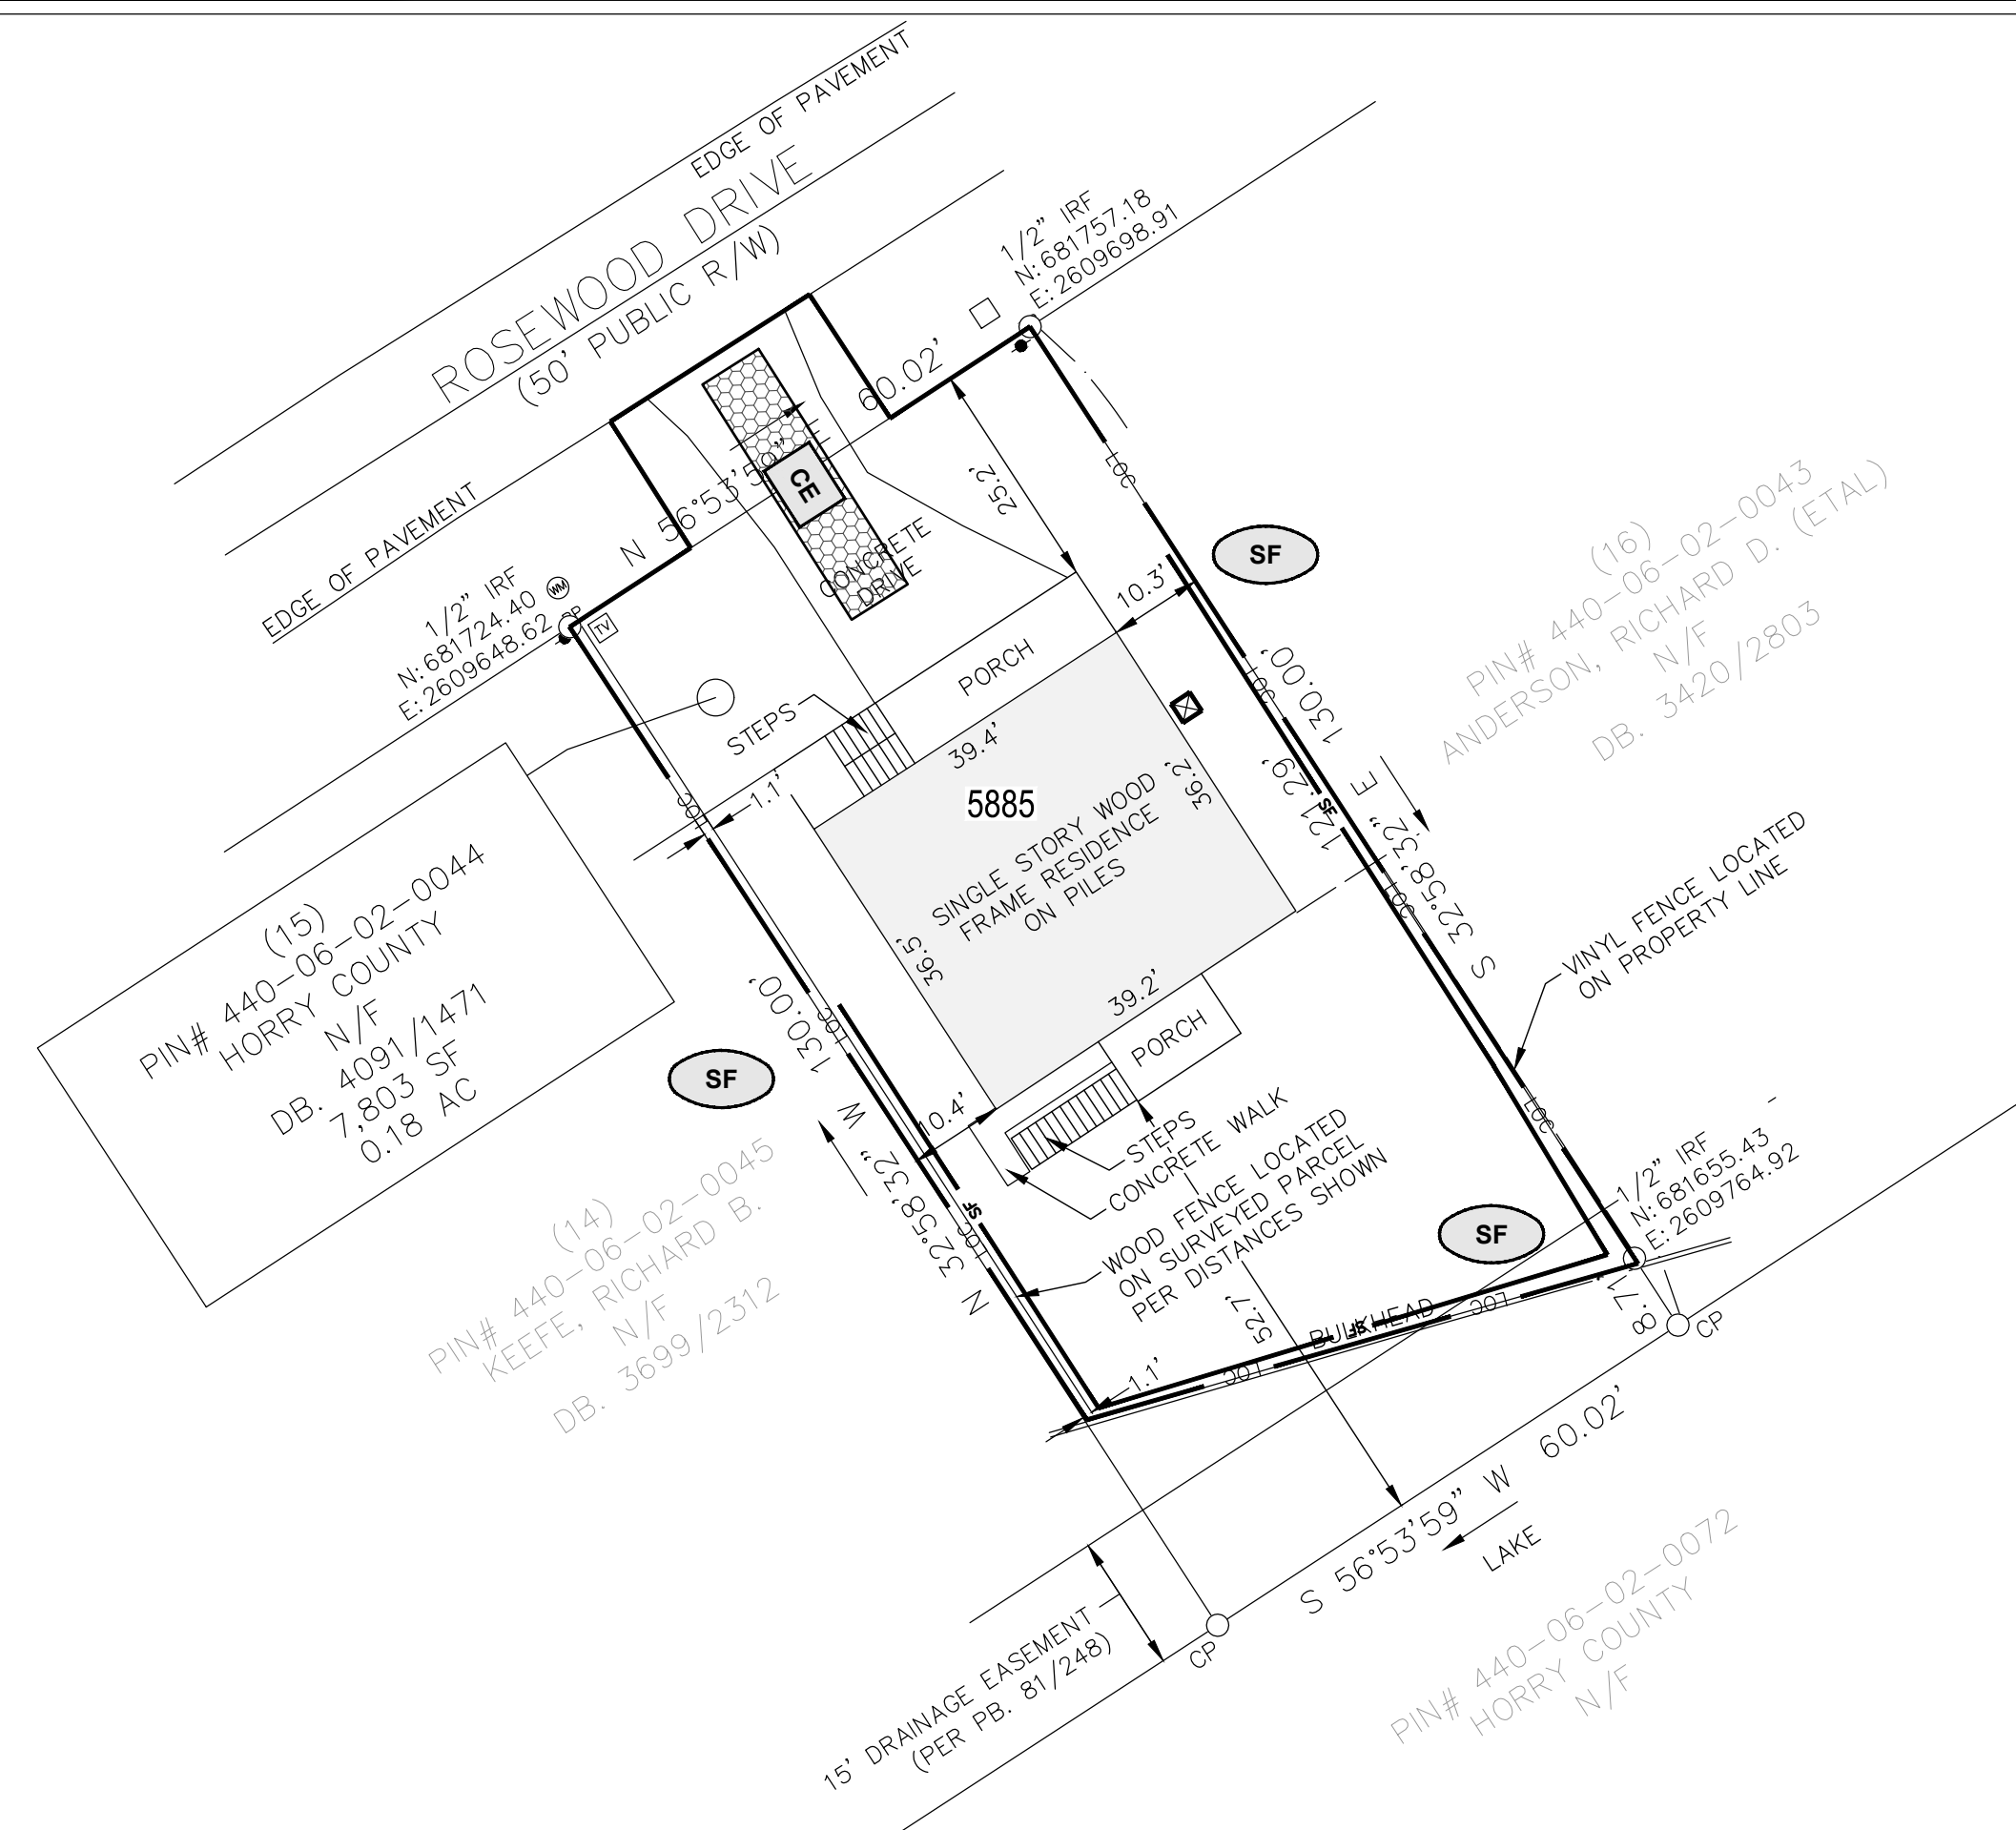




E.L. ROBINSON
ENGINEERING
1301 Cervais St., Suite 450
Columbia, SC 29201
Phone: (803) 400-6031
www.elrobinsonengineering.com





LEGEND

- | | | |
|---|-----|---|
|  | LOC | LIMITS OF DISTURBANCE |
|  | SF | SILT FENCE |
|  | CE | TEMPORARY CONSTRUCTION
ENTRANCE/EXIT |
|  | IPa | INLET PROTECTION DET. A |
|  | IPe | INLET PROTECTION DET. E |
|  | | SEDIMENT TUBES |


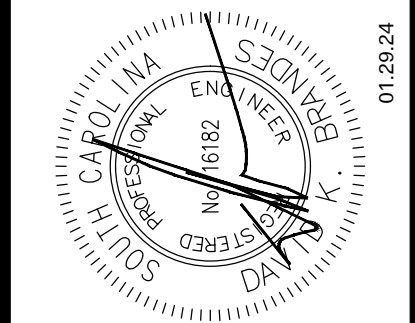
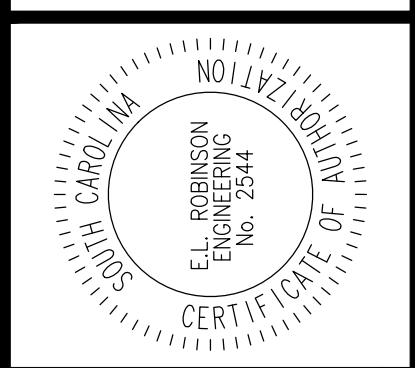
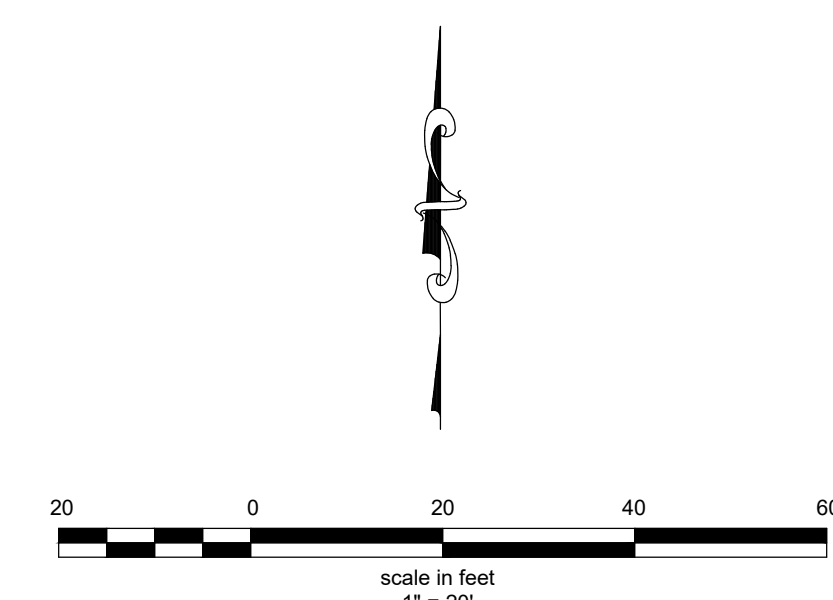


HORRY COUNTY BUYOUT DEMOLITION

SOUTH CAROLINA OFFICE OF RESILIENCE
HORRY COUNTY, SOUTH CAROLINA

Drawing Title	Drawing Information	Revisions	
DEMOLITION PLAN - PHASE 1	Project No. D30-N027-M	No.	Name
	Drawn By CWS		
	Date 05/08/23		
	Designed By DNB		
	Date 05/08/23		
	Approved By DNB		

**DEMOLITION
PLAN -
PHASE 1**

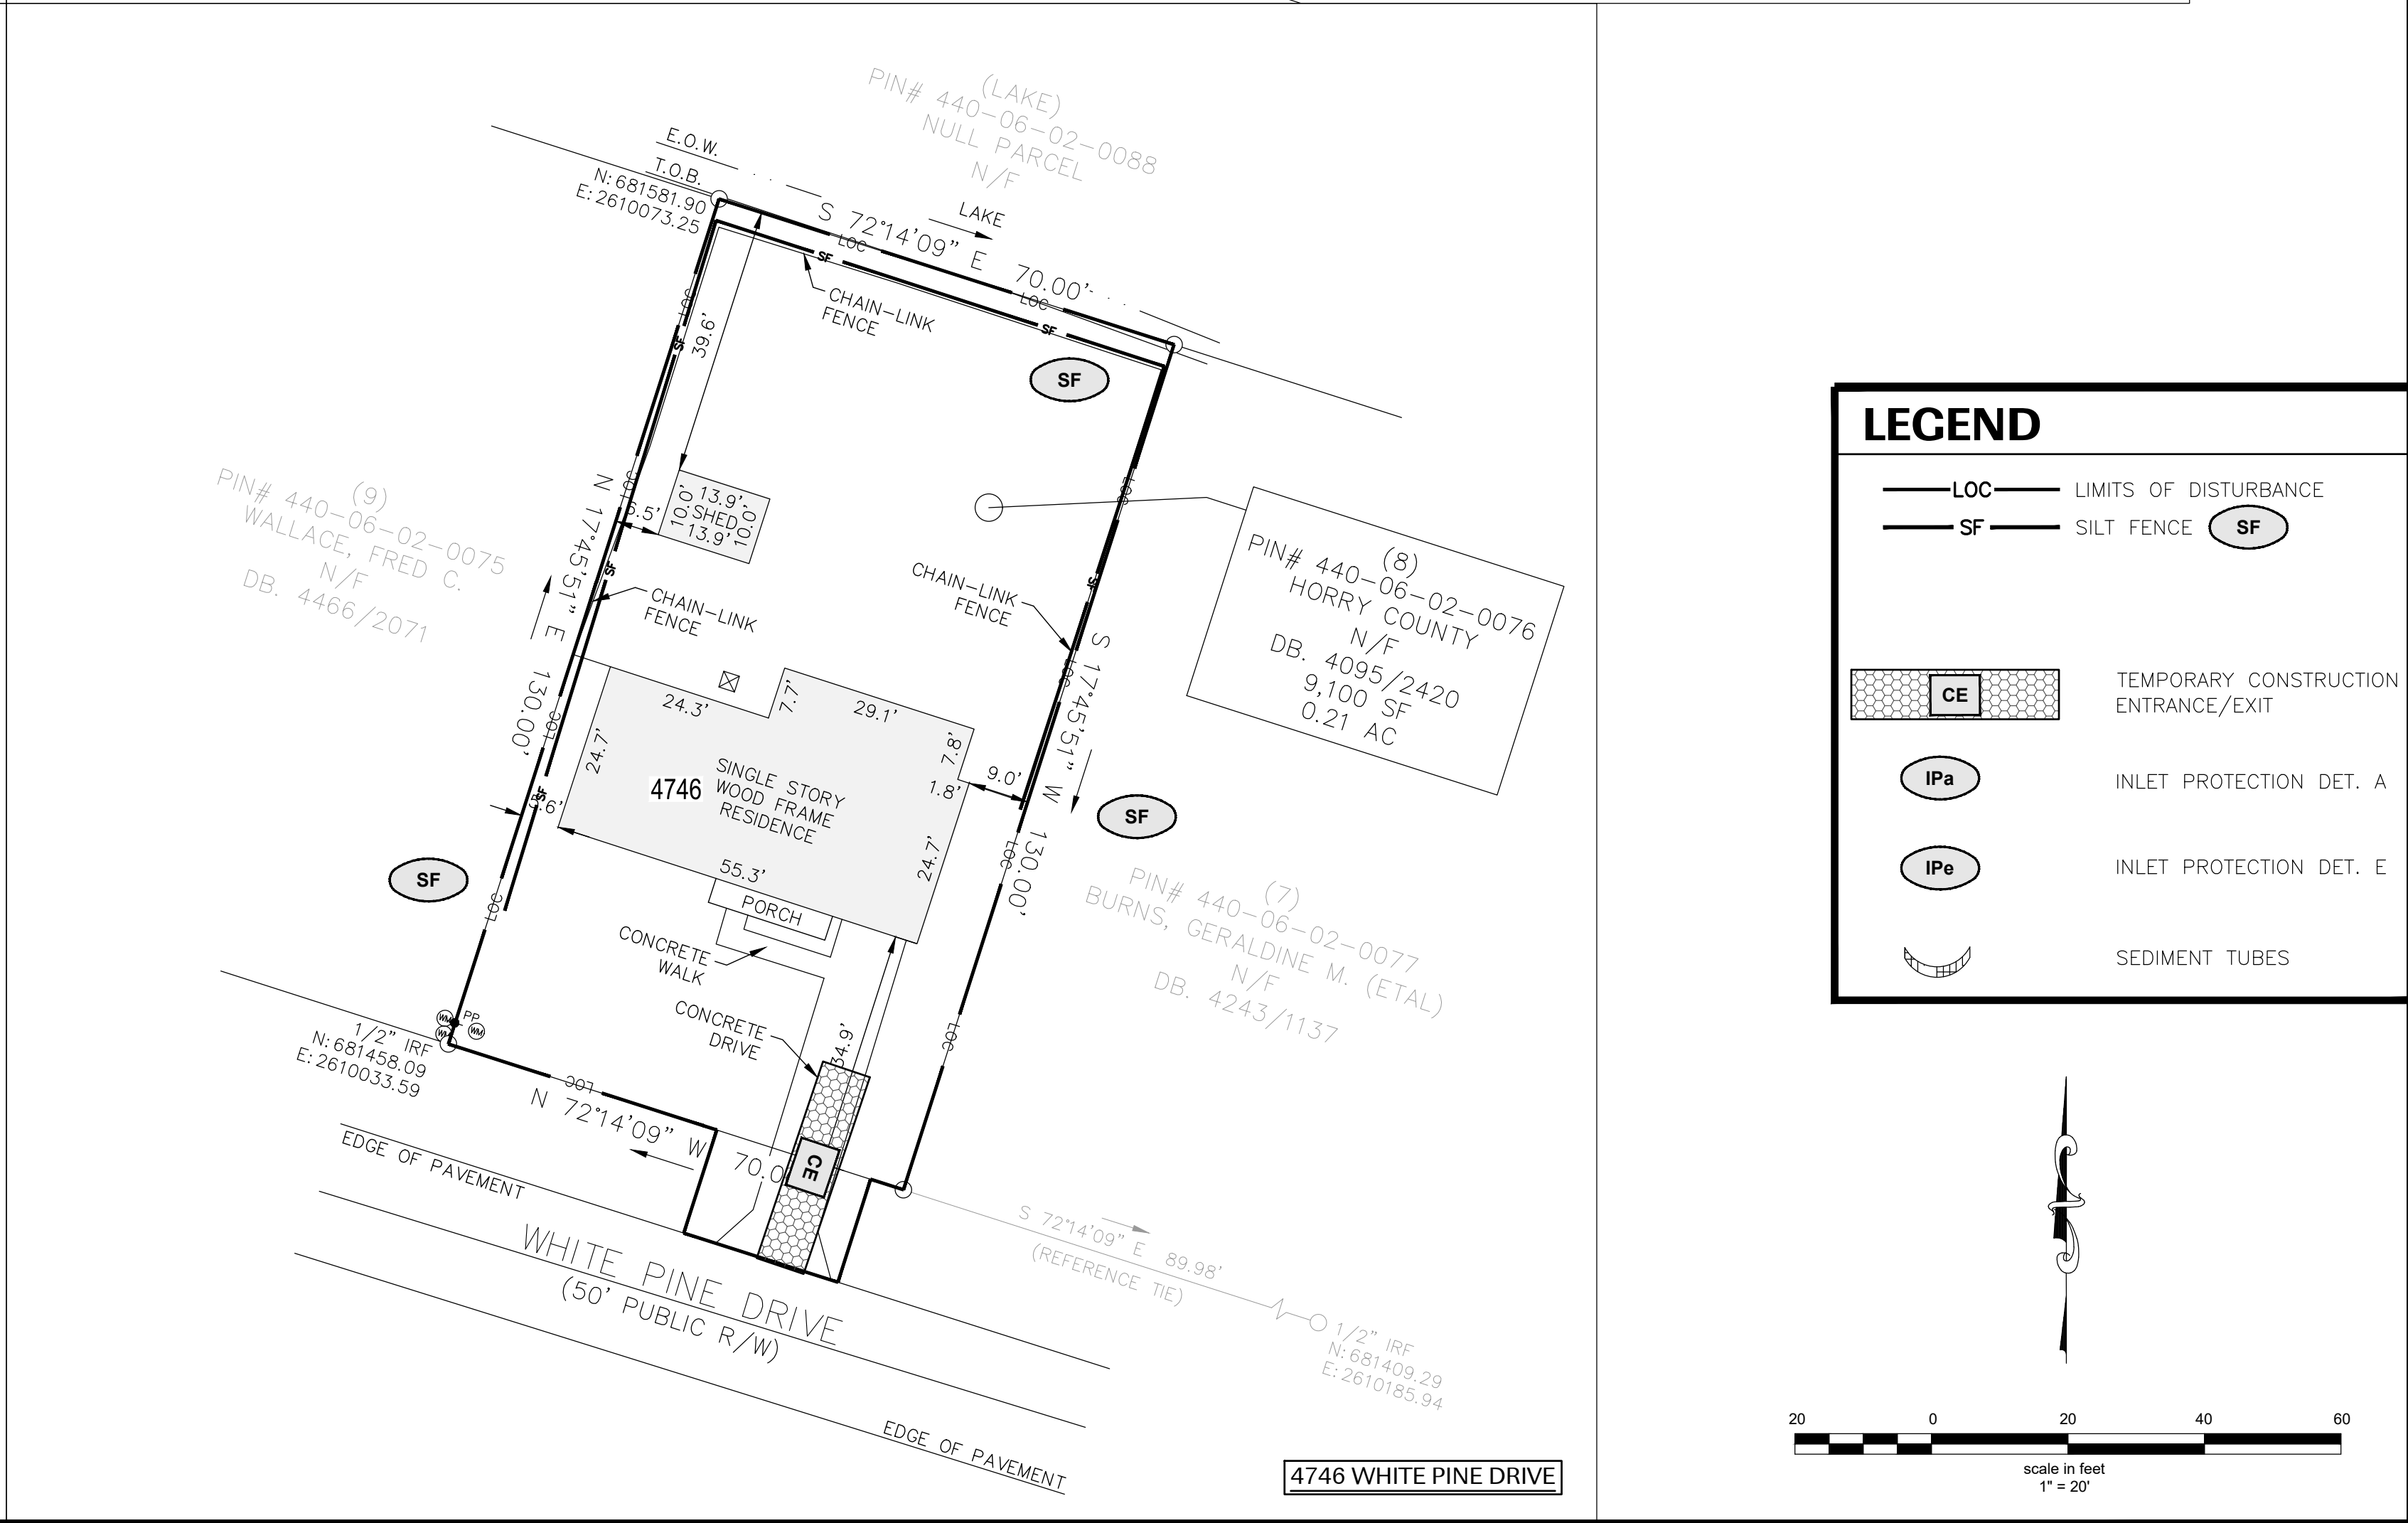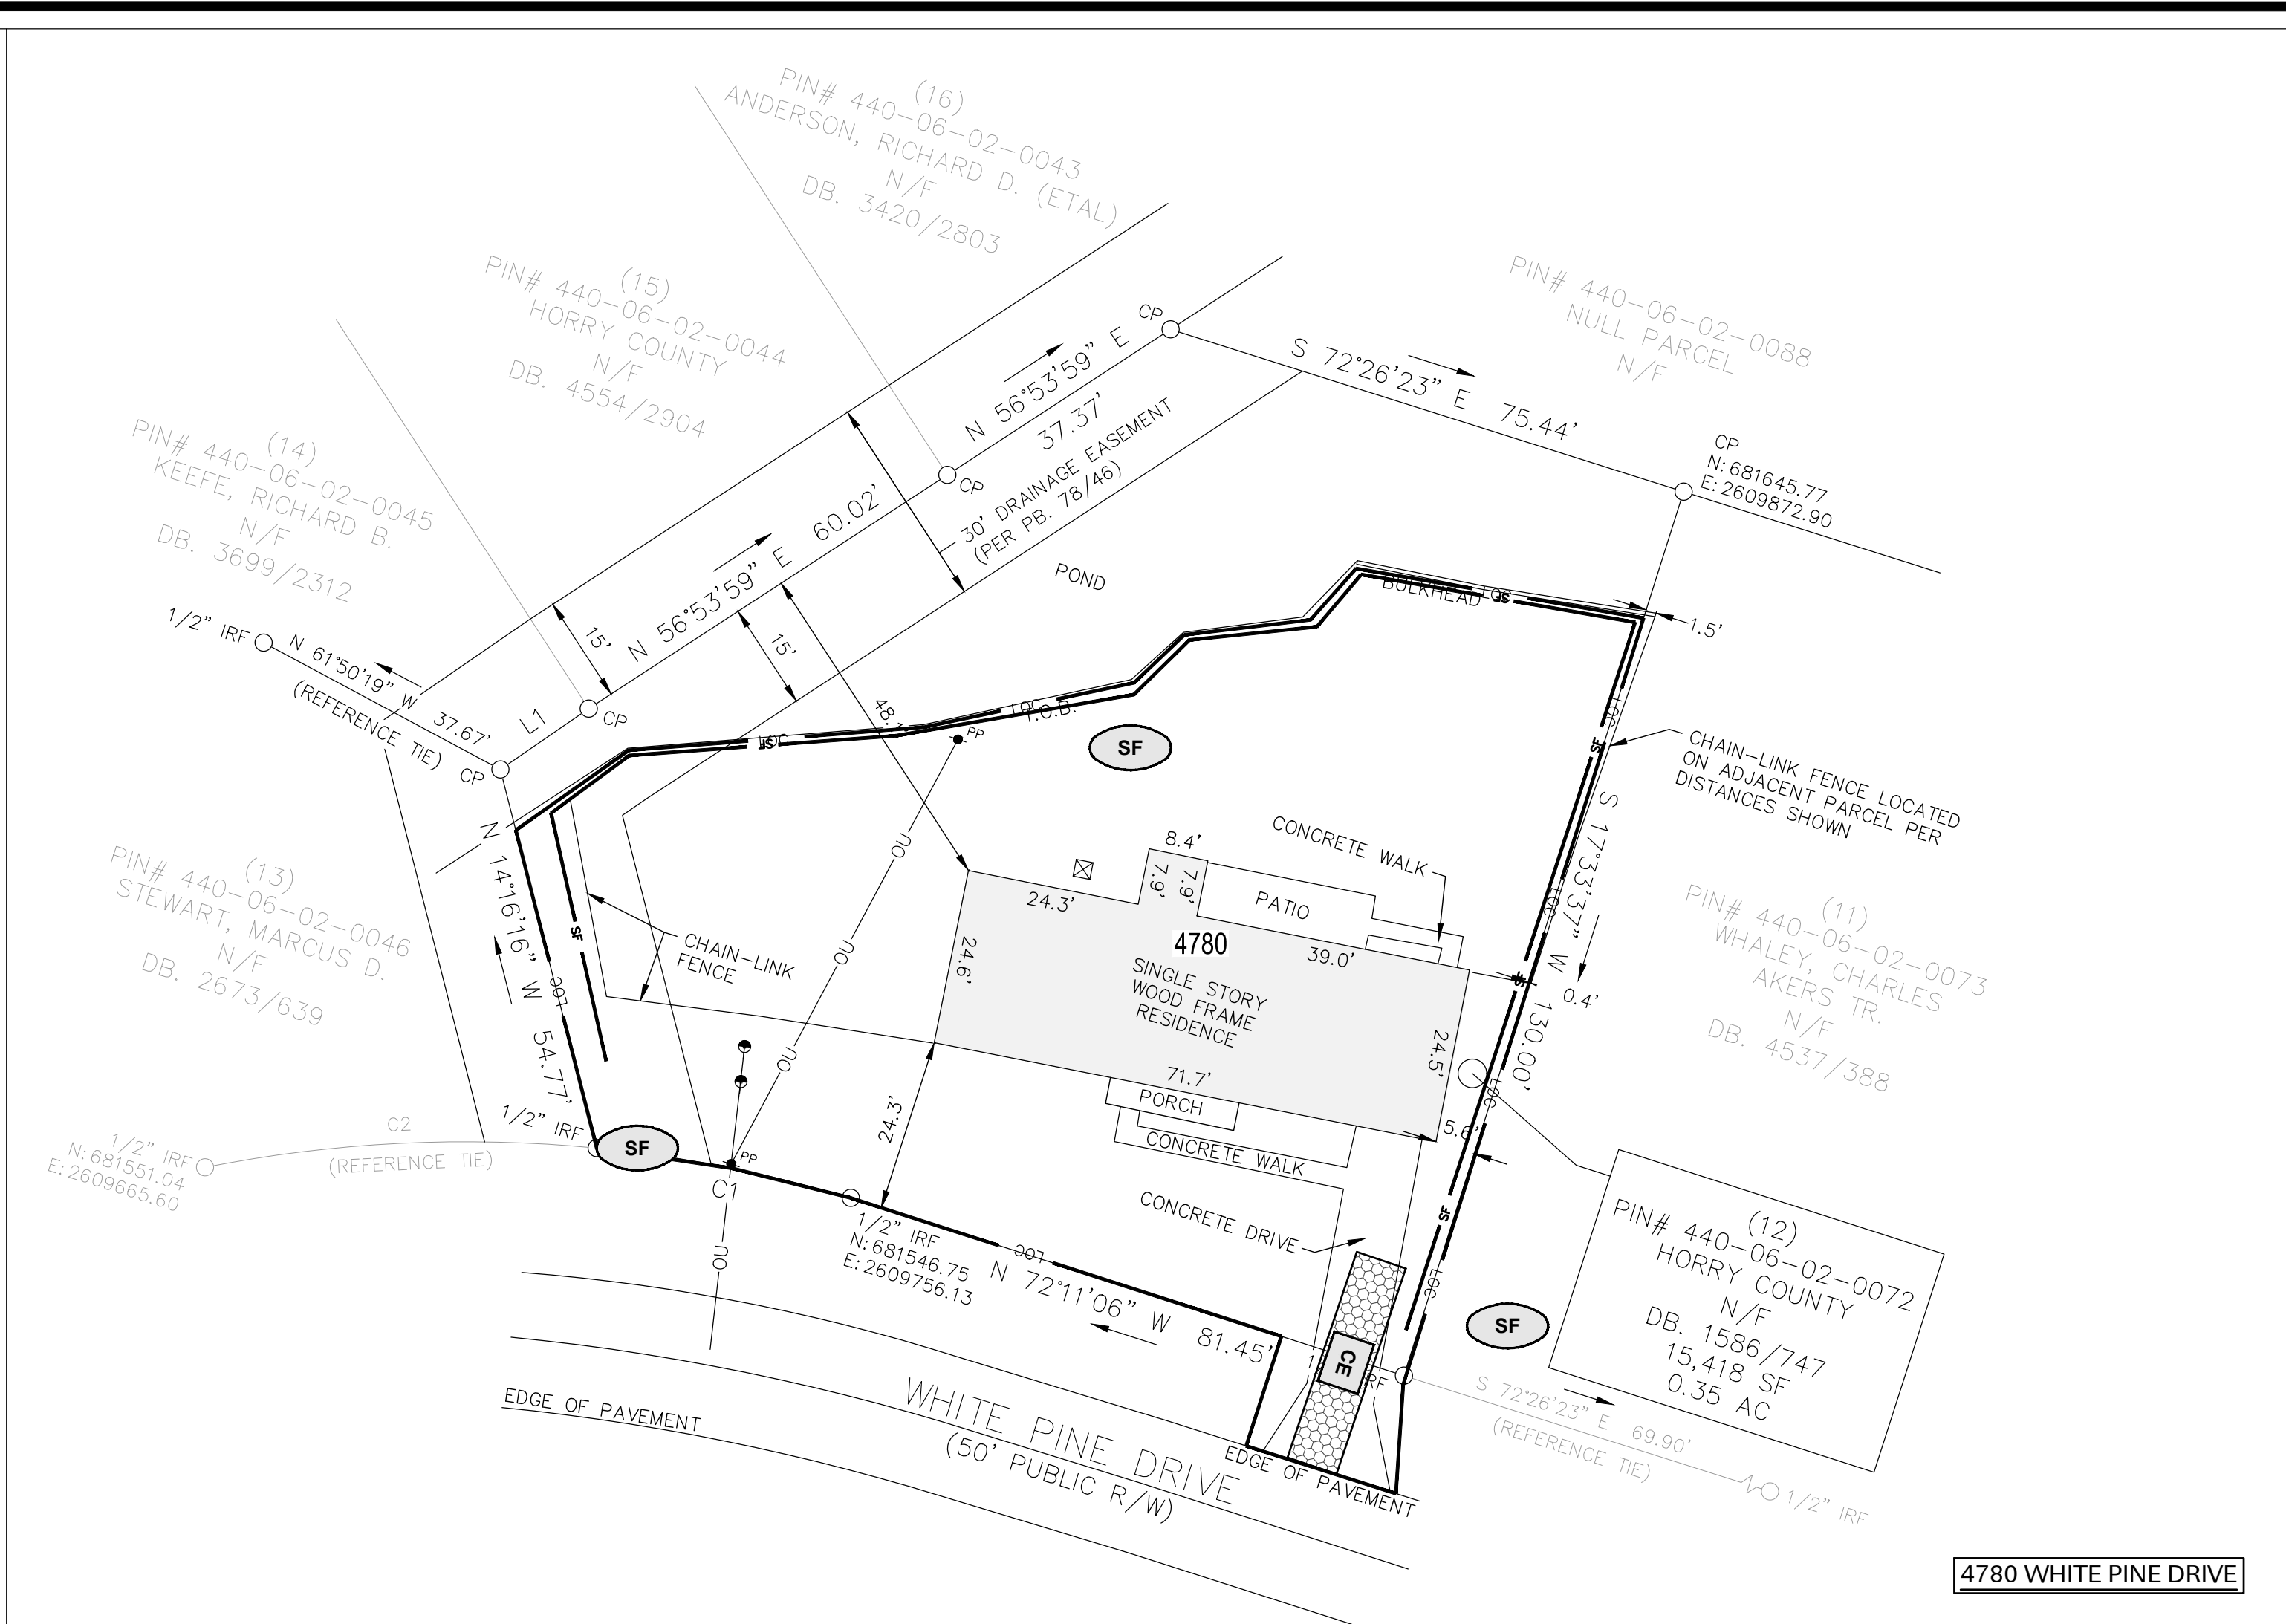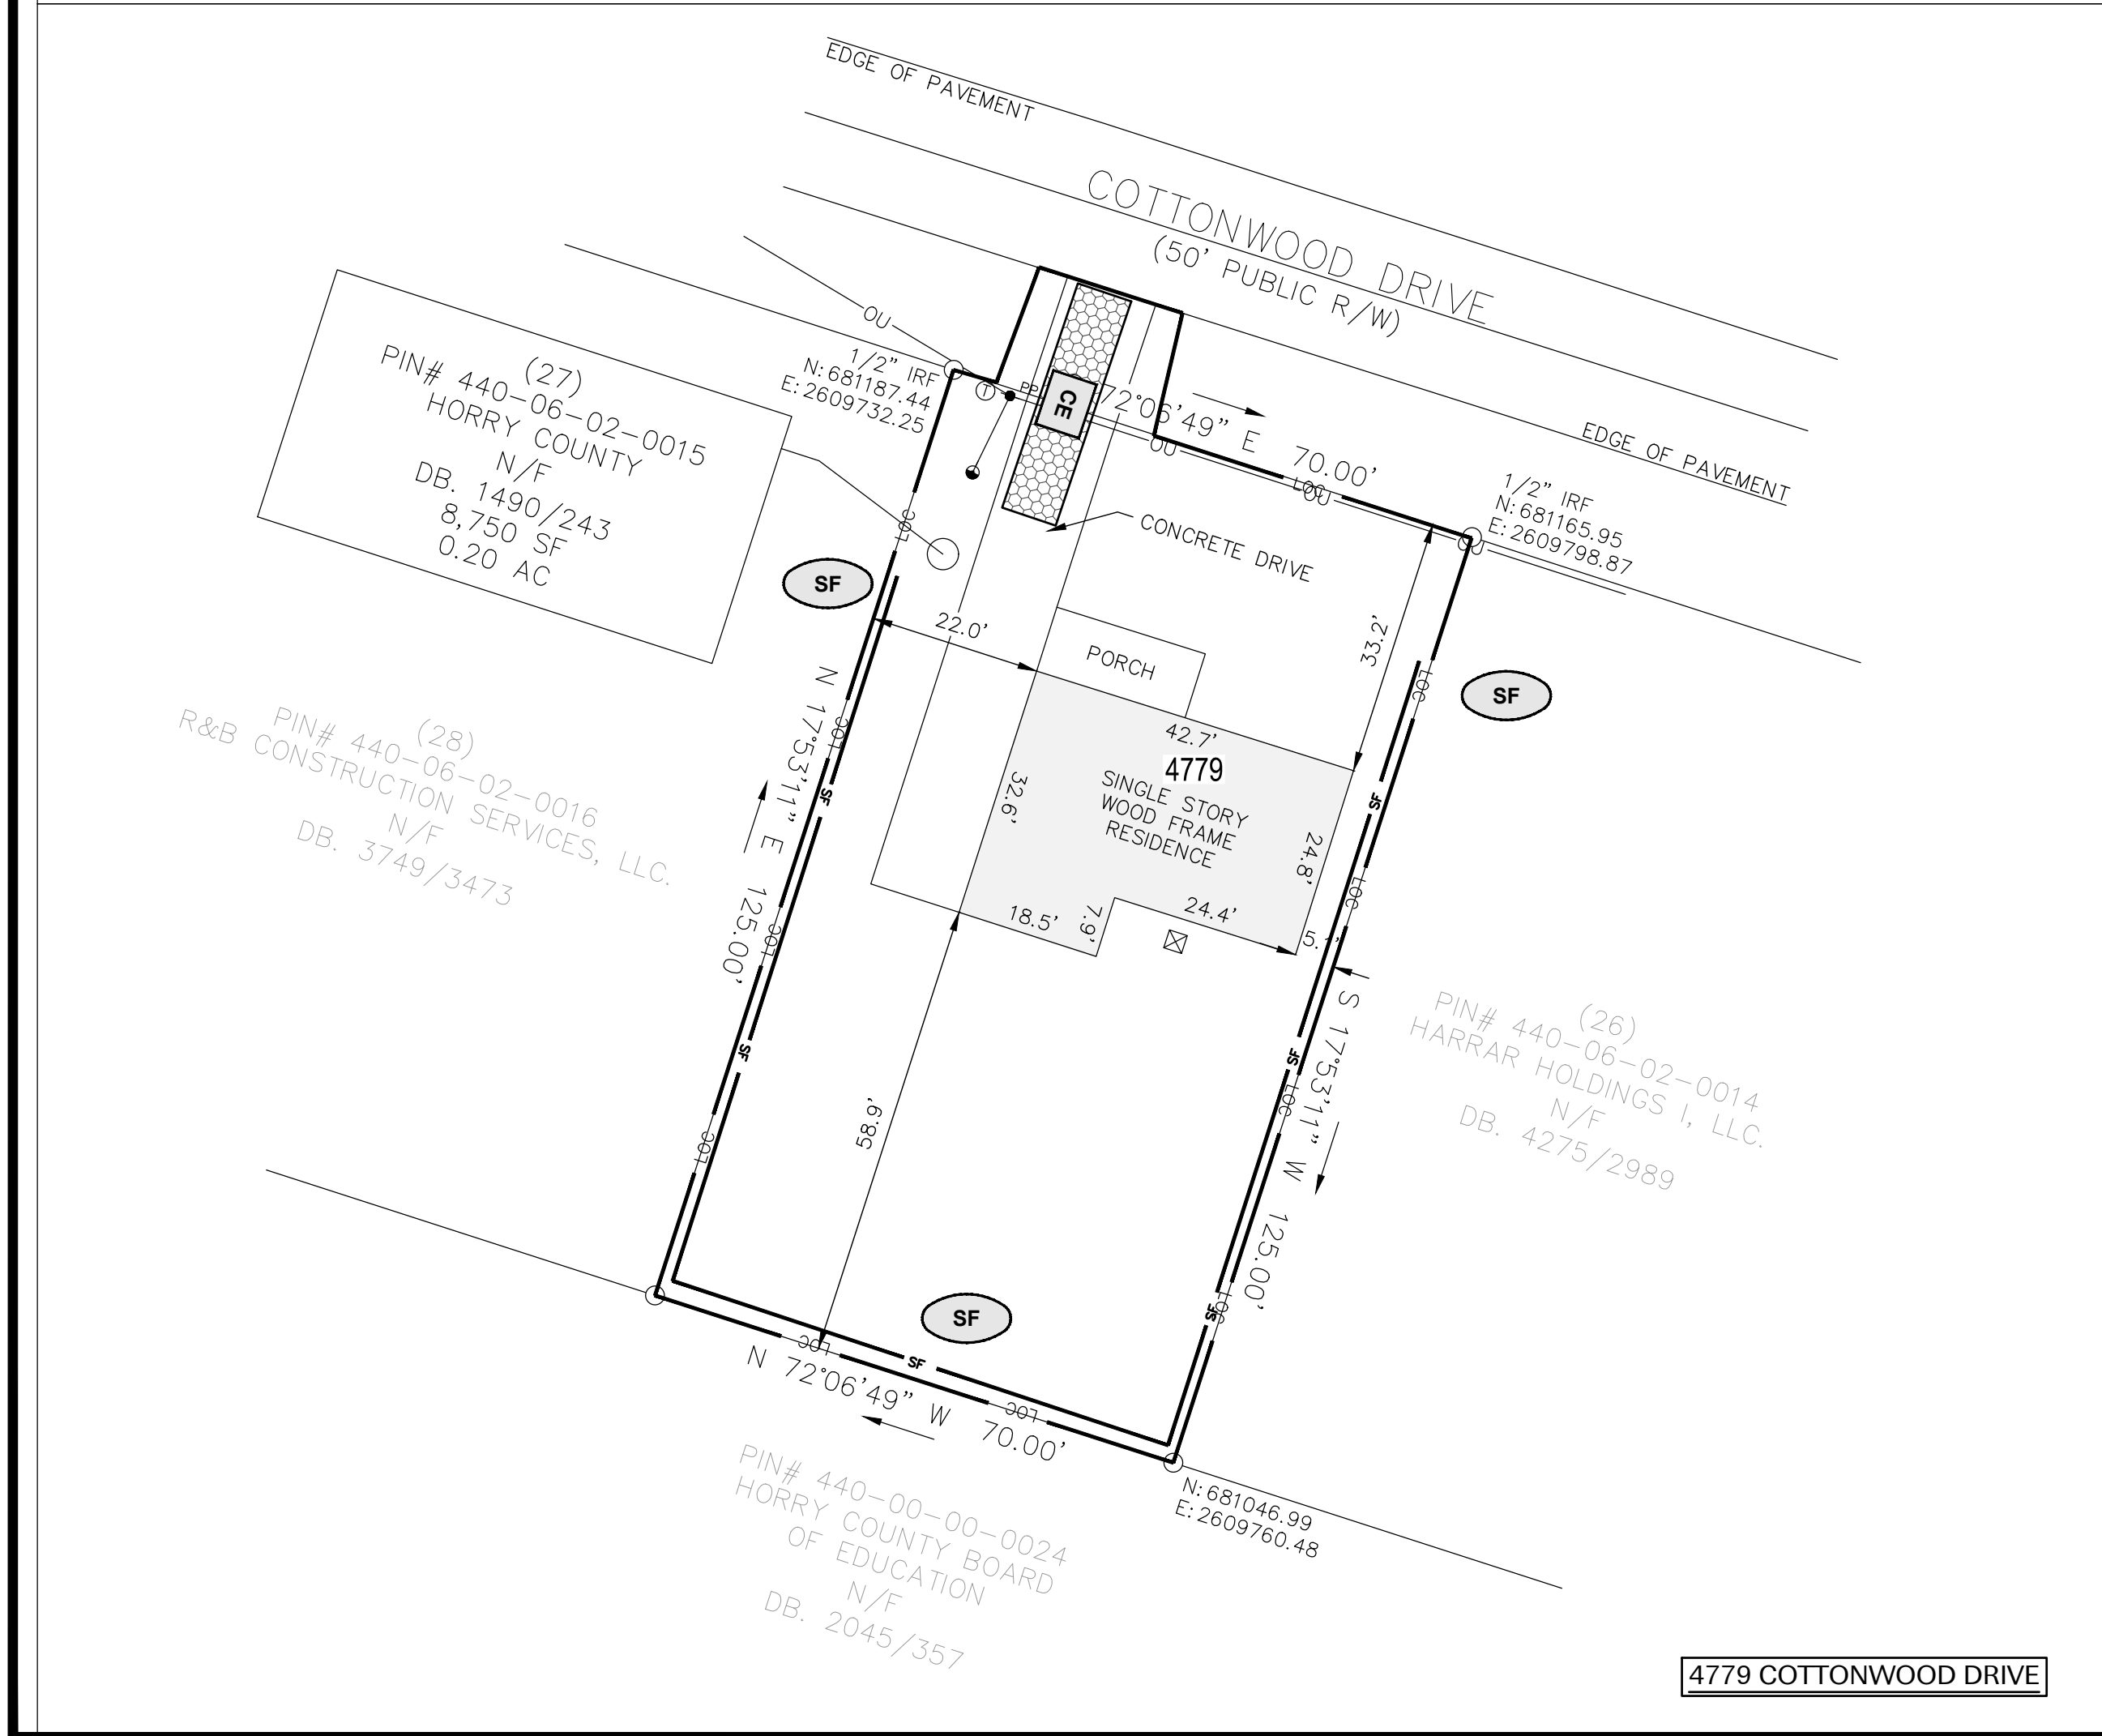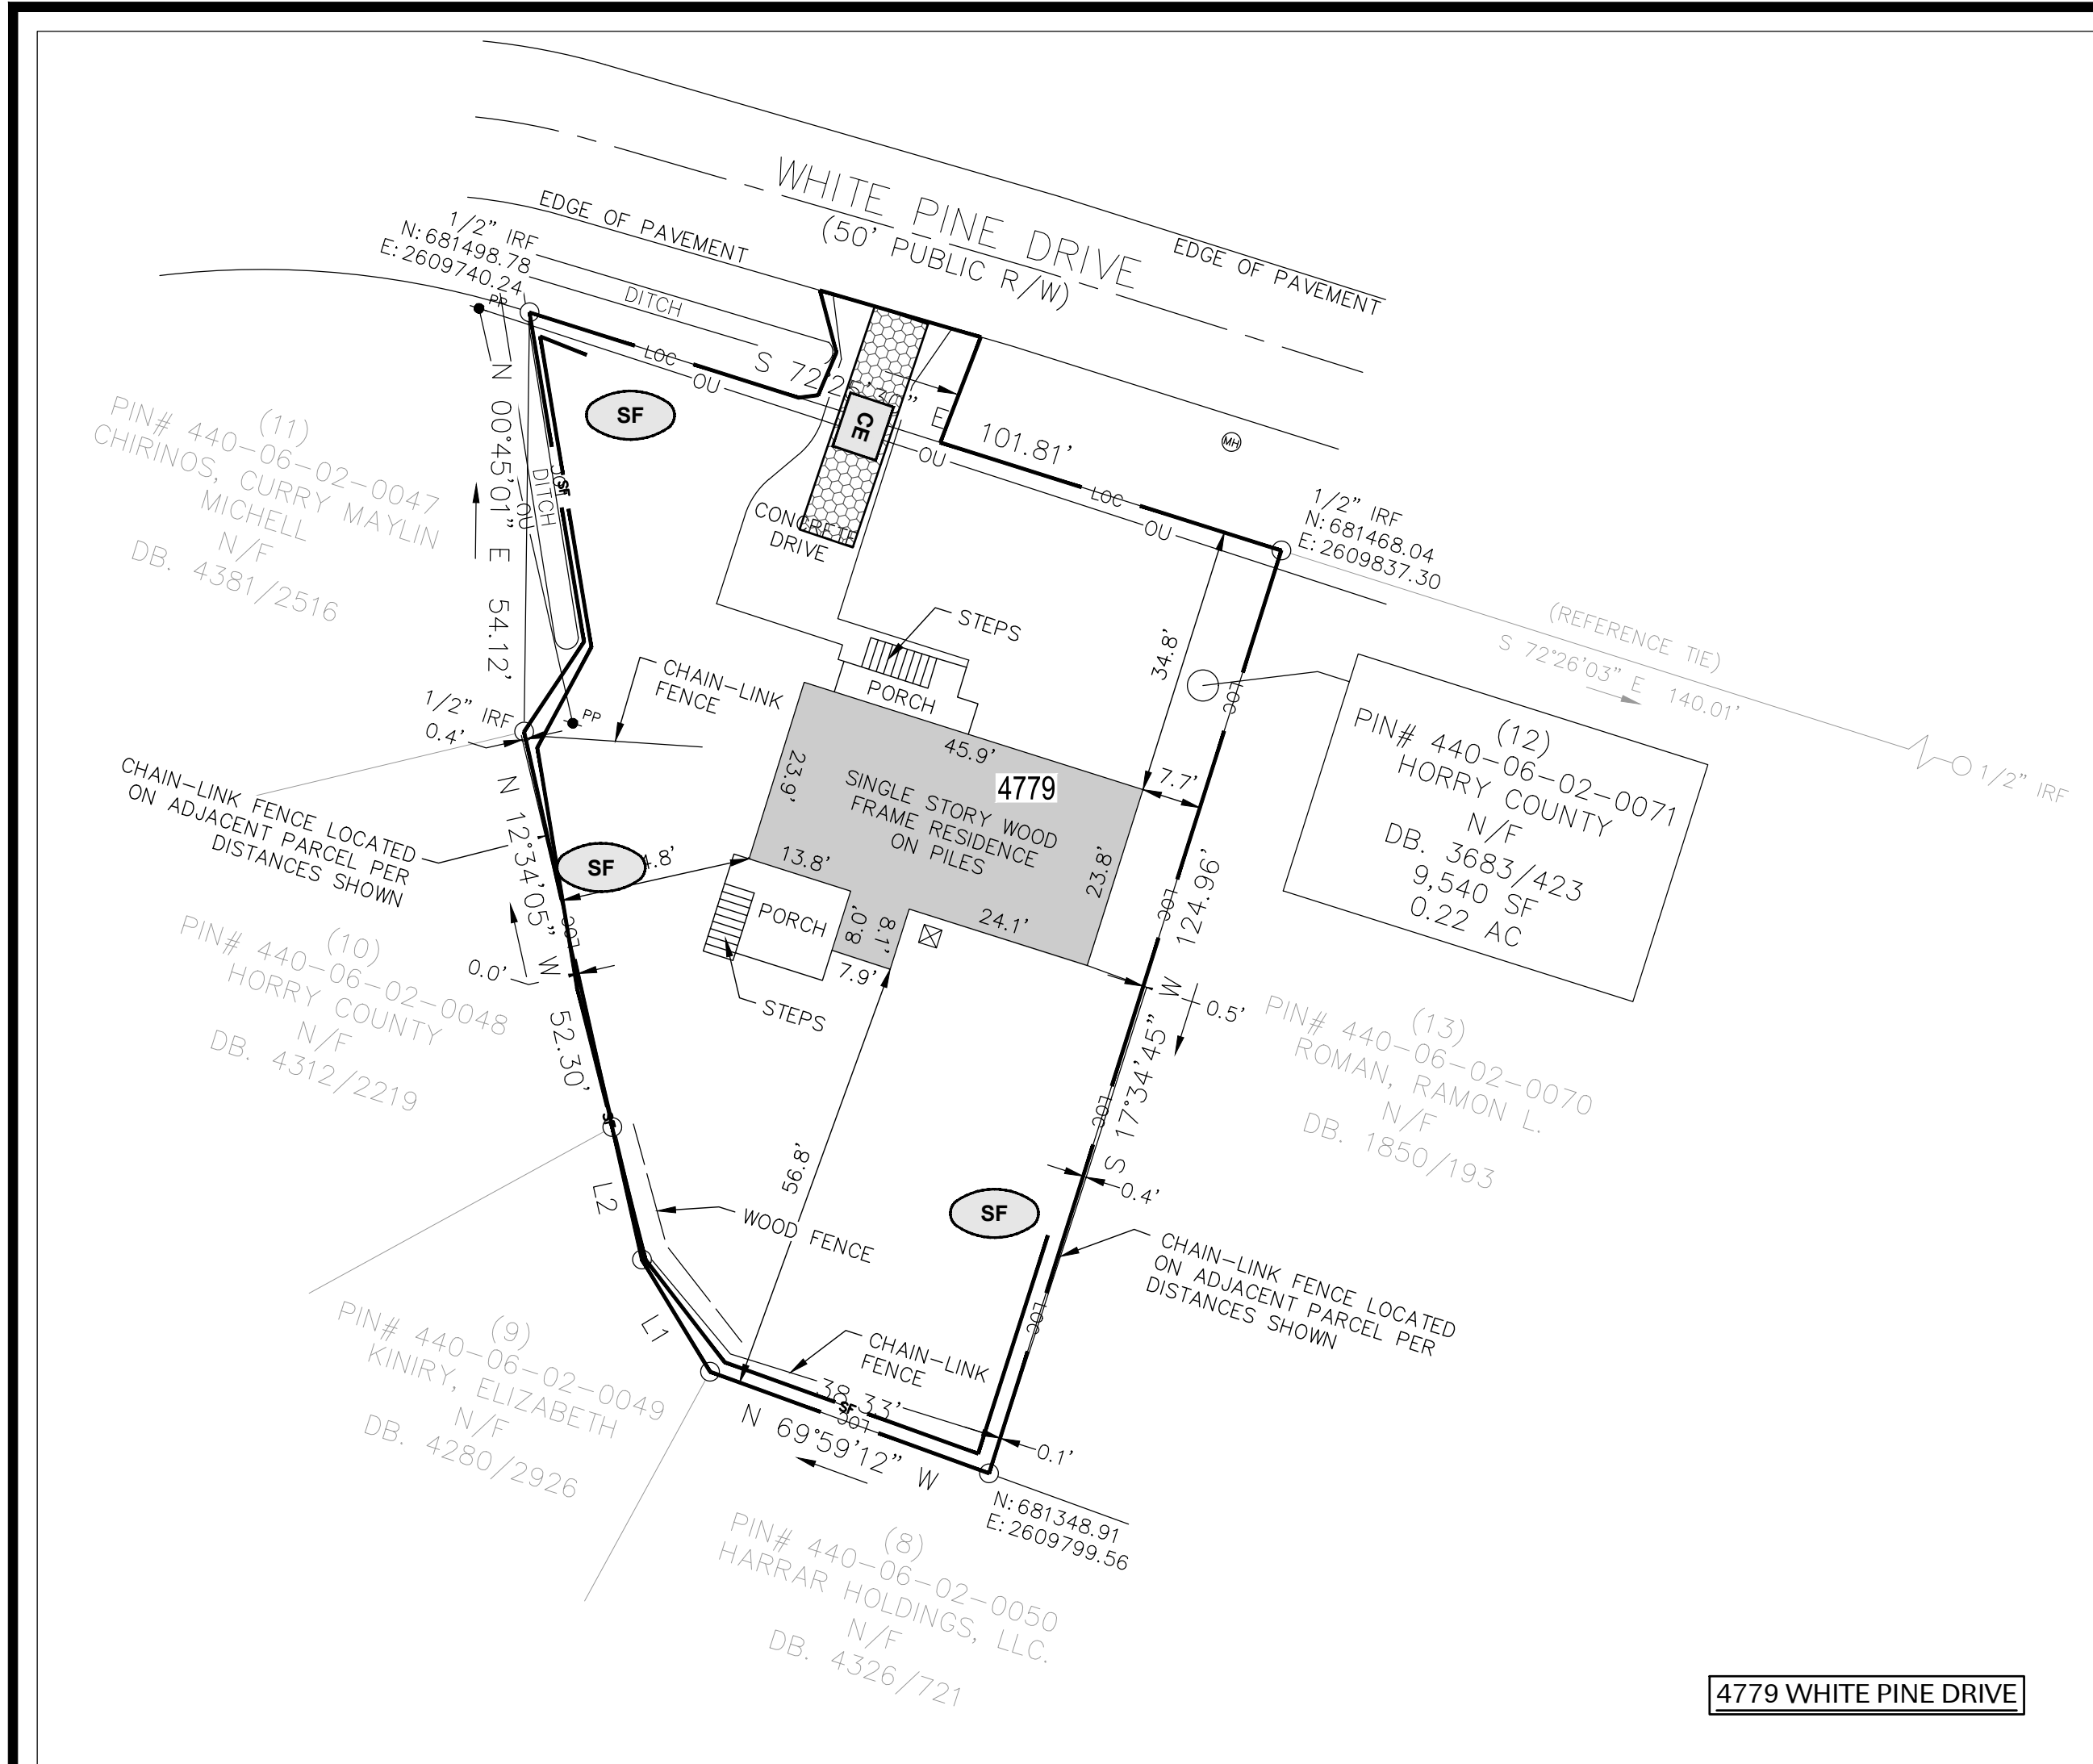

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CERTIFICATE OF
REGISTERED PROFESSIONAL ENGINEER
No. 2544
SOUTH CAROLINA
EXPIRATION DATE 01/23/24

**HORRY COUNTY BUYOUT
DEMOLITION PLAN - PHASE 1S**




SOUTH CAROLINA OFFICE OF RESILIENCE
HORRY COUNTY, SOUTH CAROLINA

Revisions	No.	Name	Date


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Checked By: [Signature]	
Date: 09.08.23	
Approved By: [Signature]	
Date: 09.08.23	

DEMOLITION PLAN - PHASE 1

Drawing No. **C2.2**

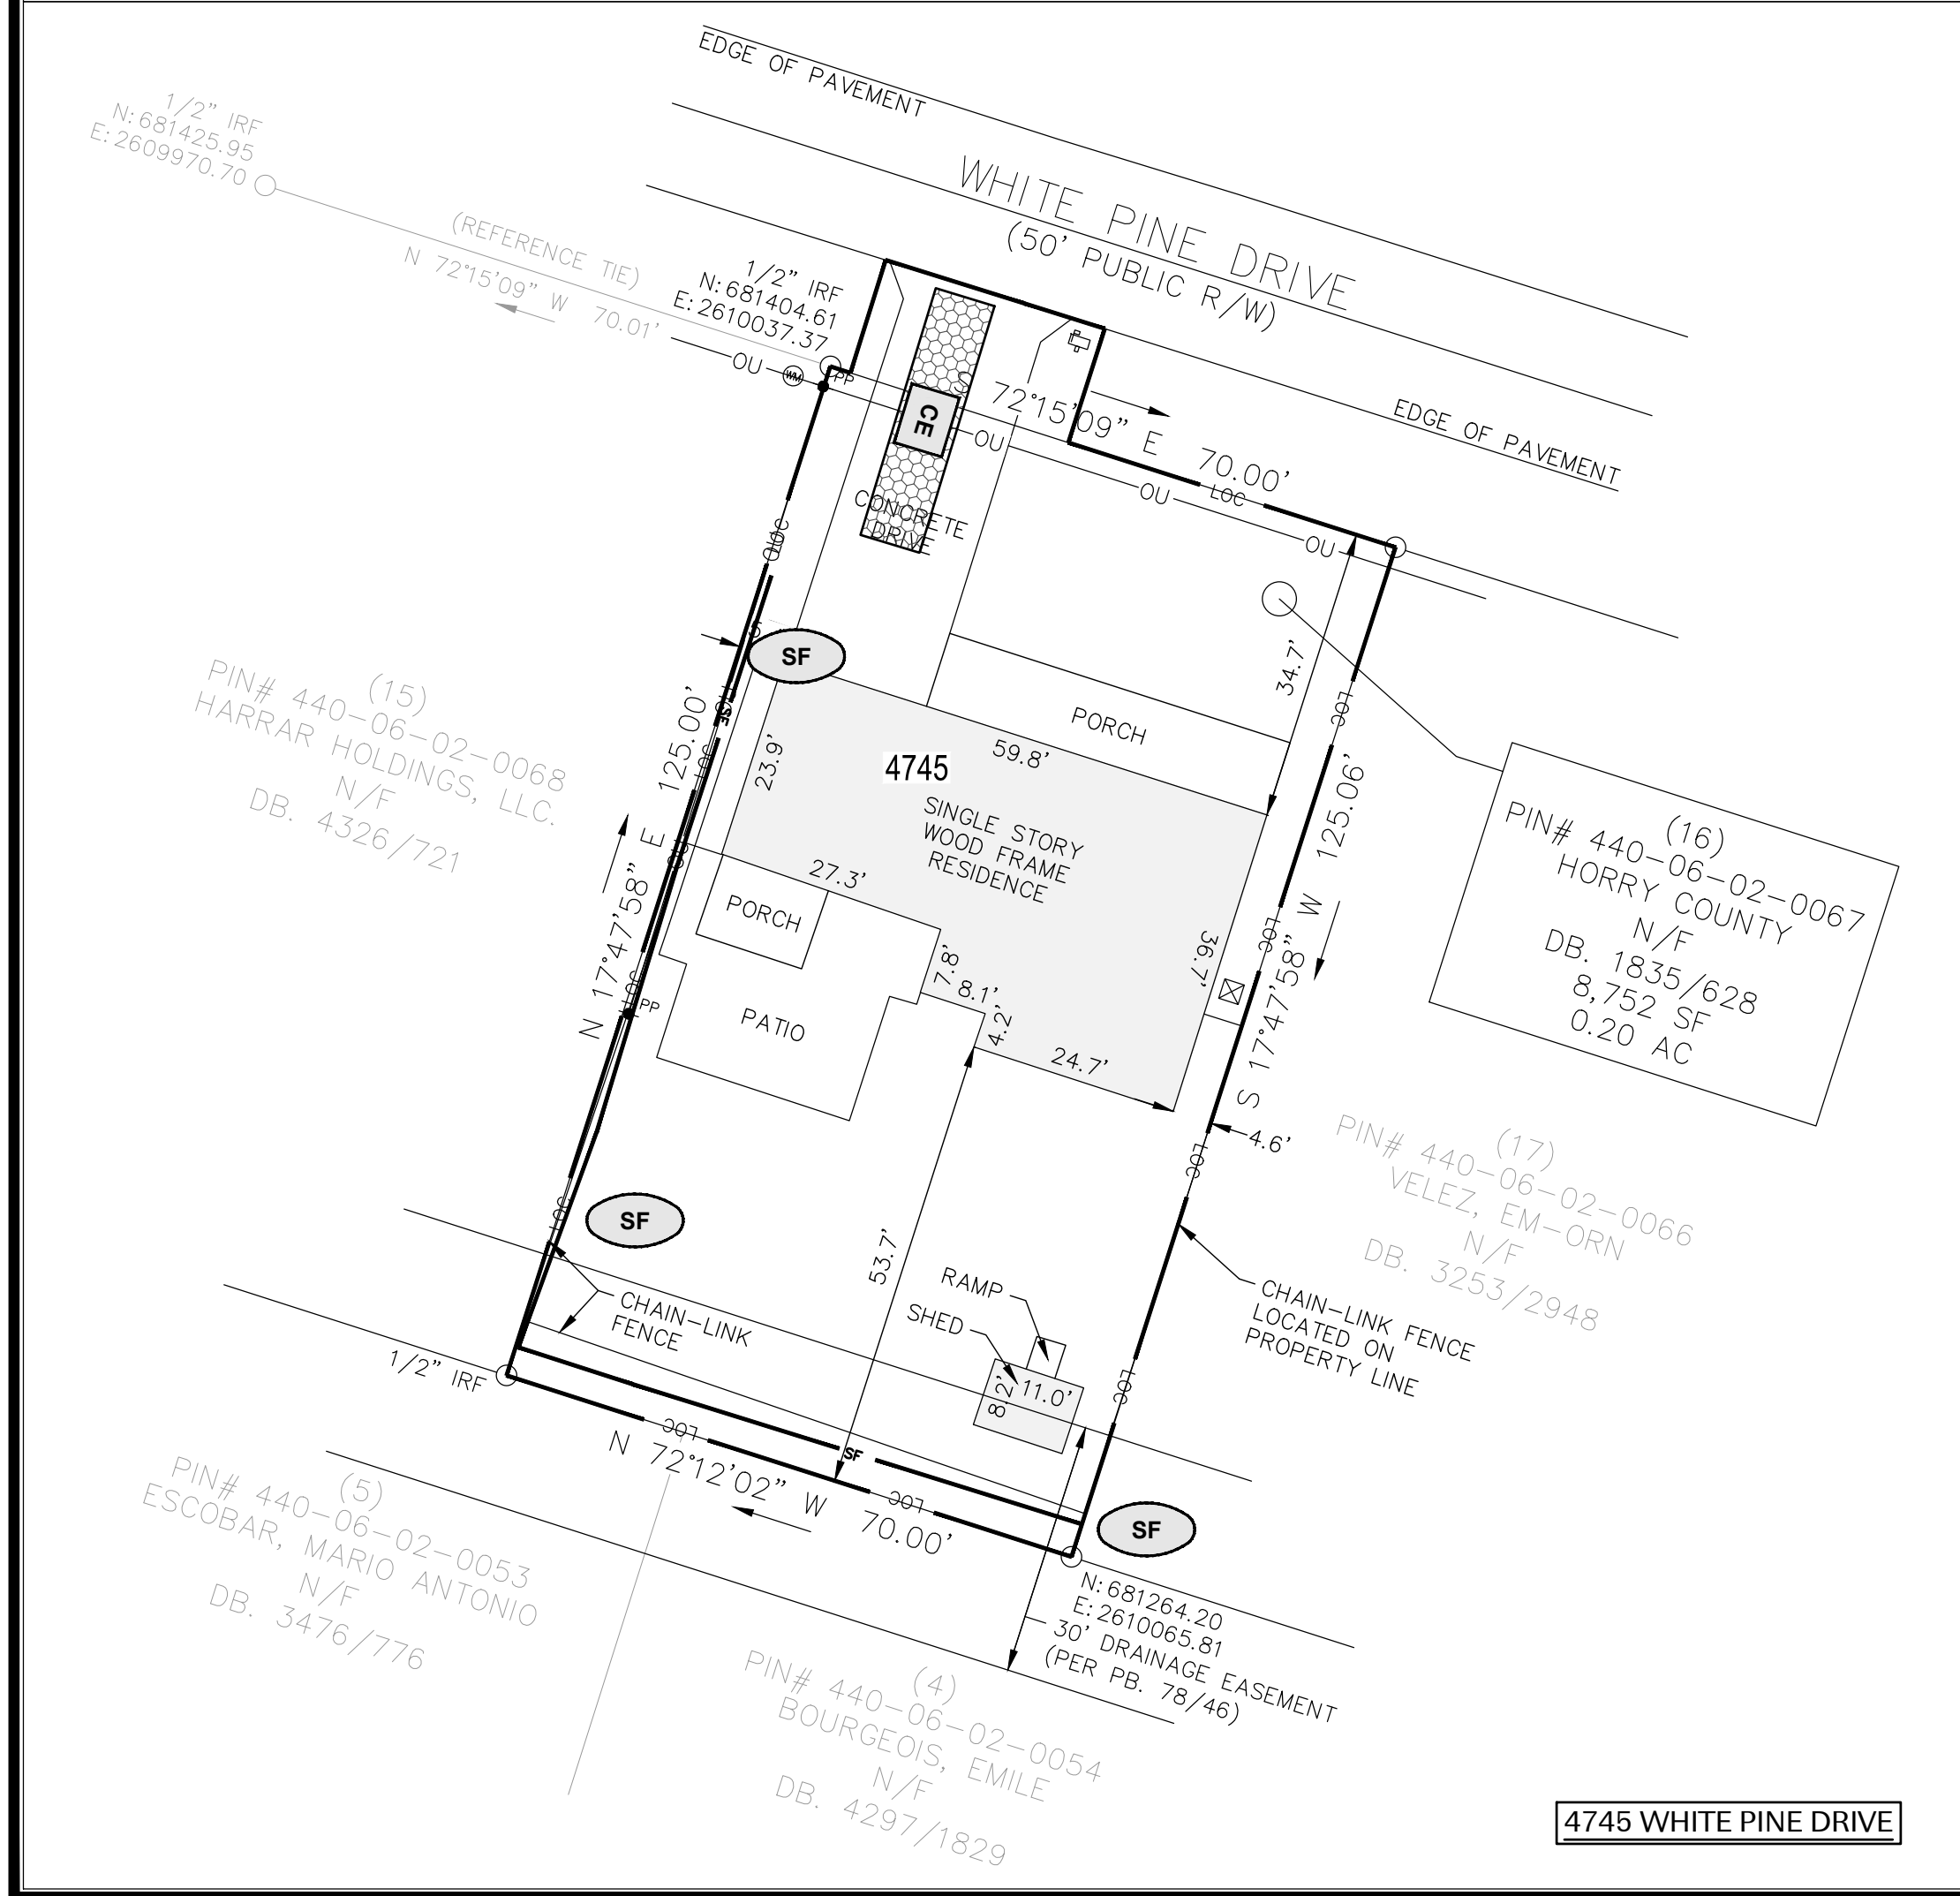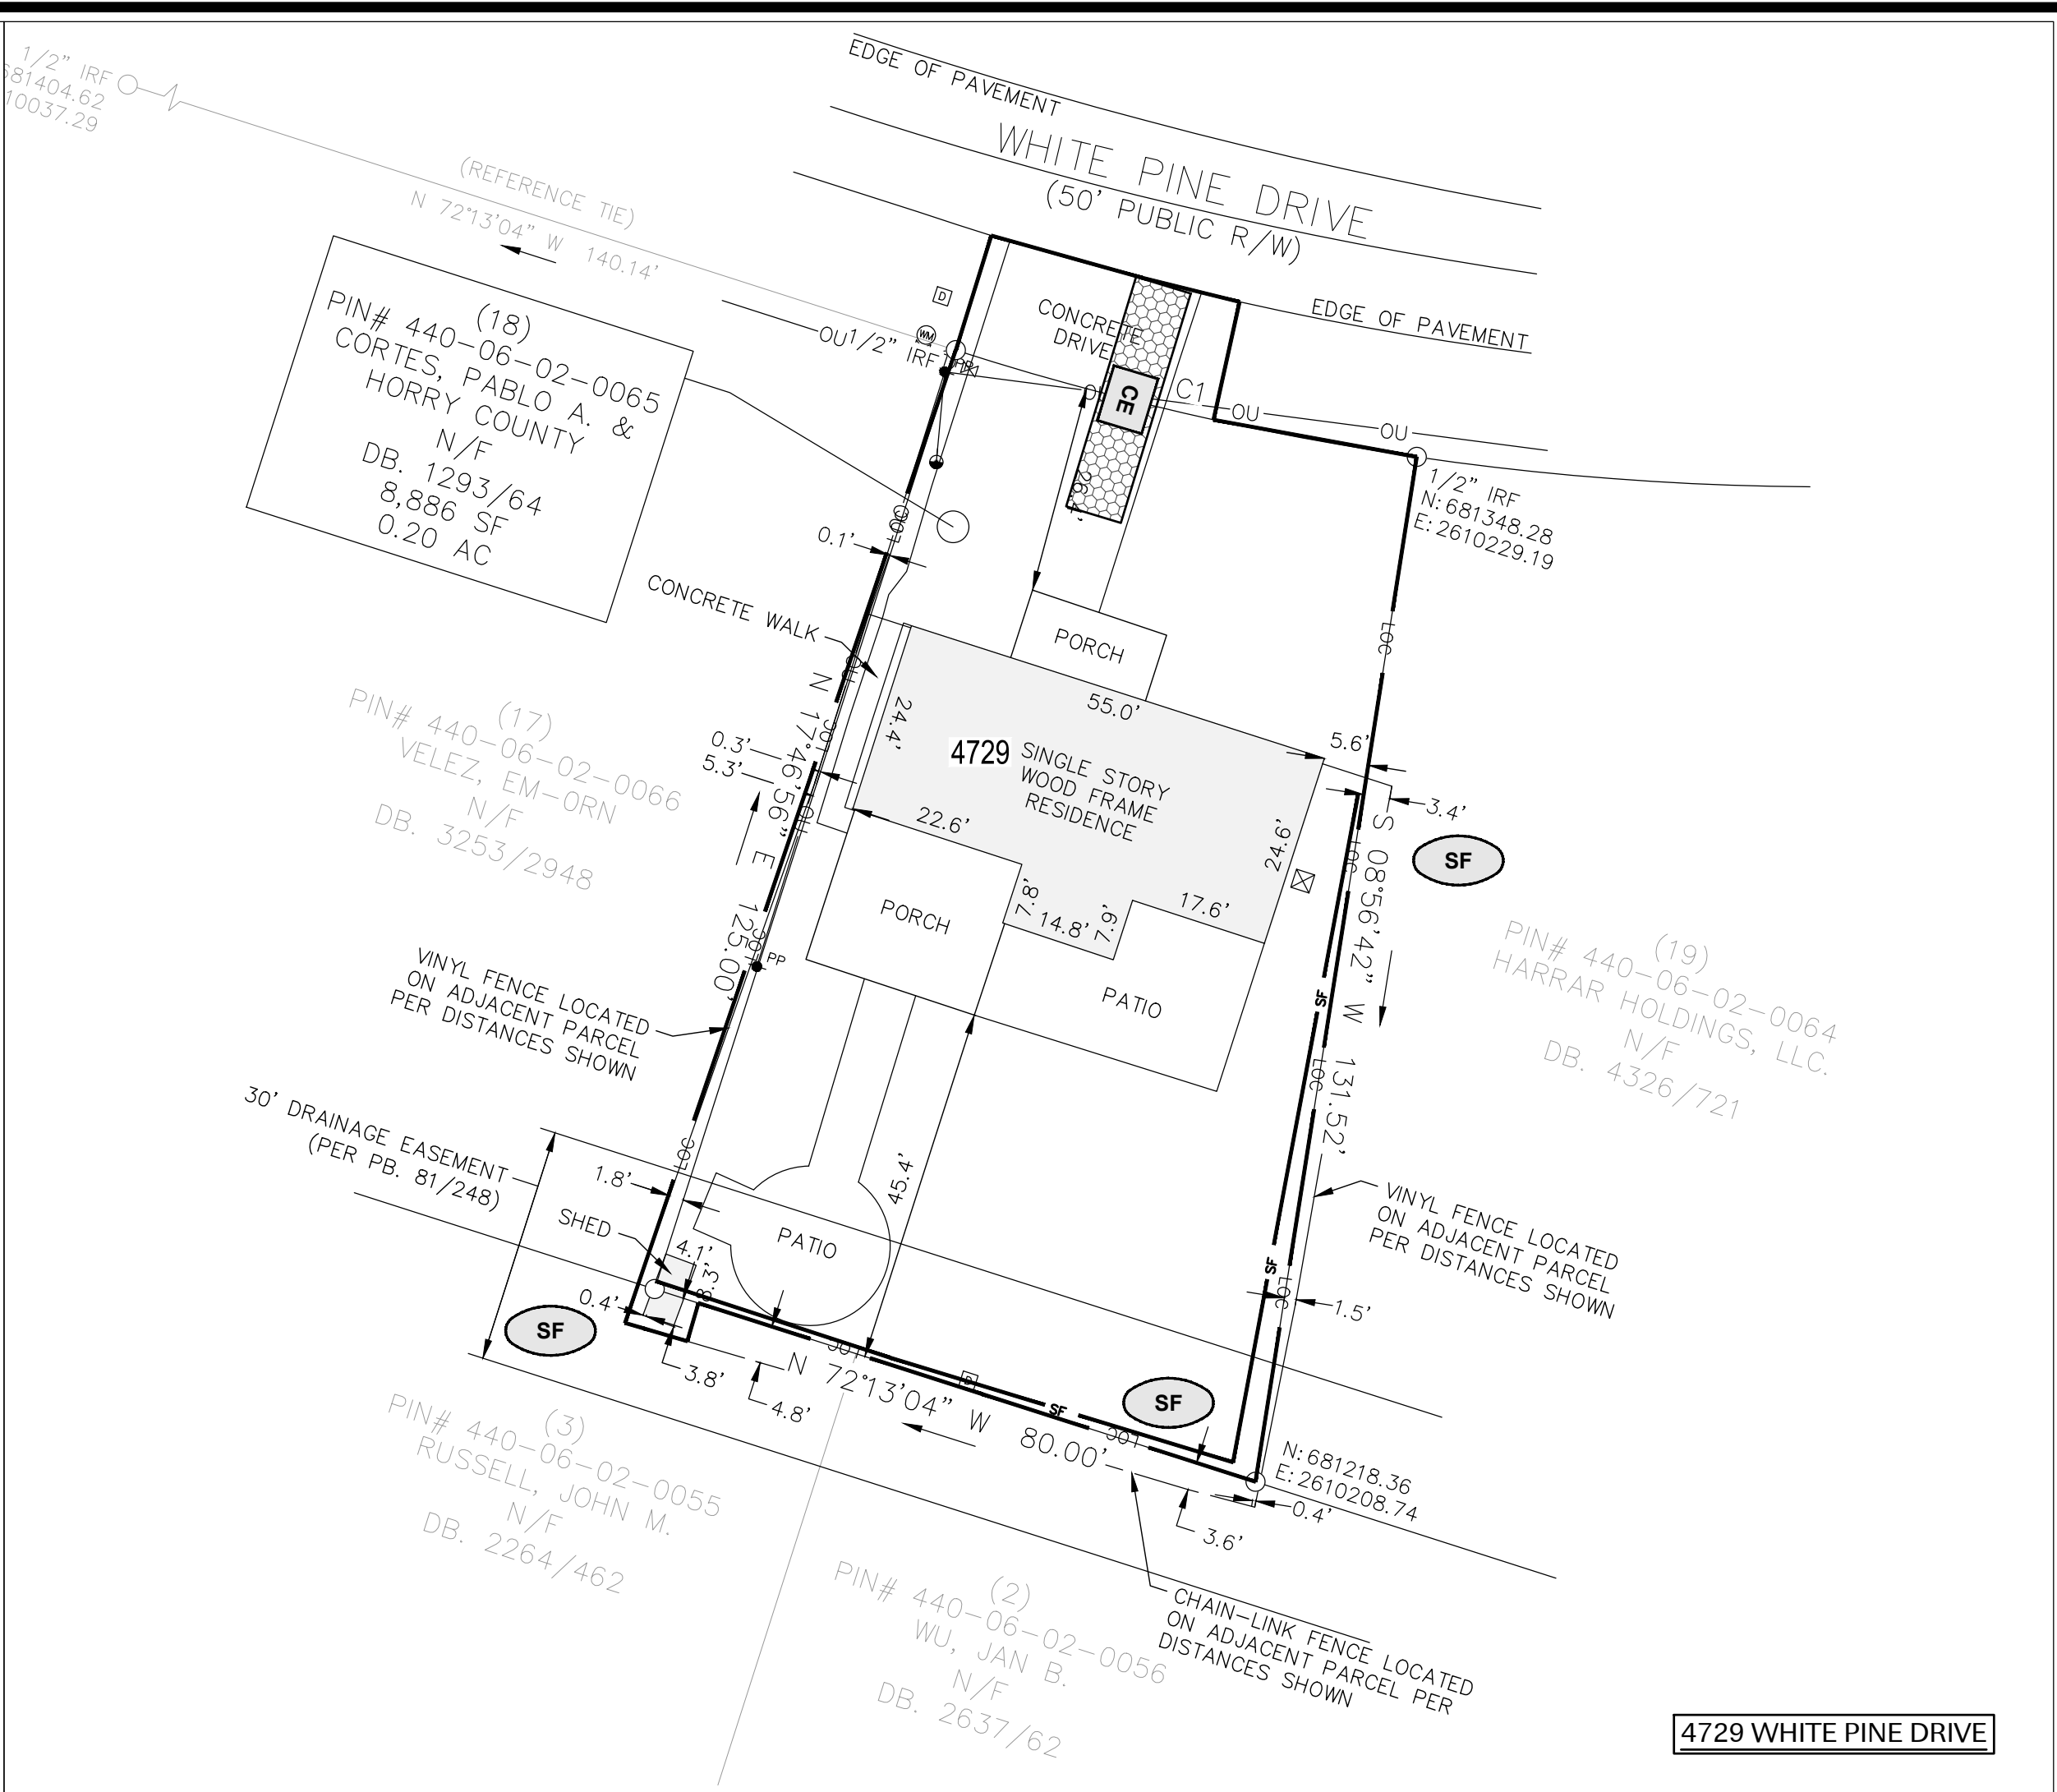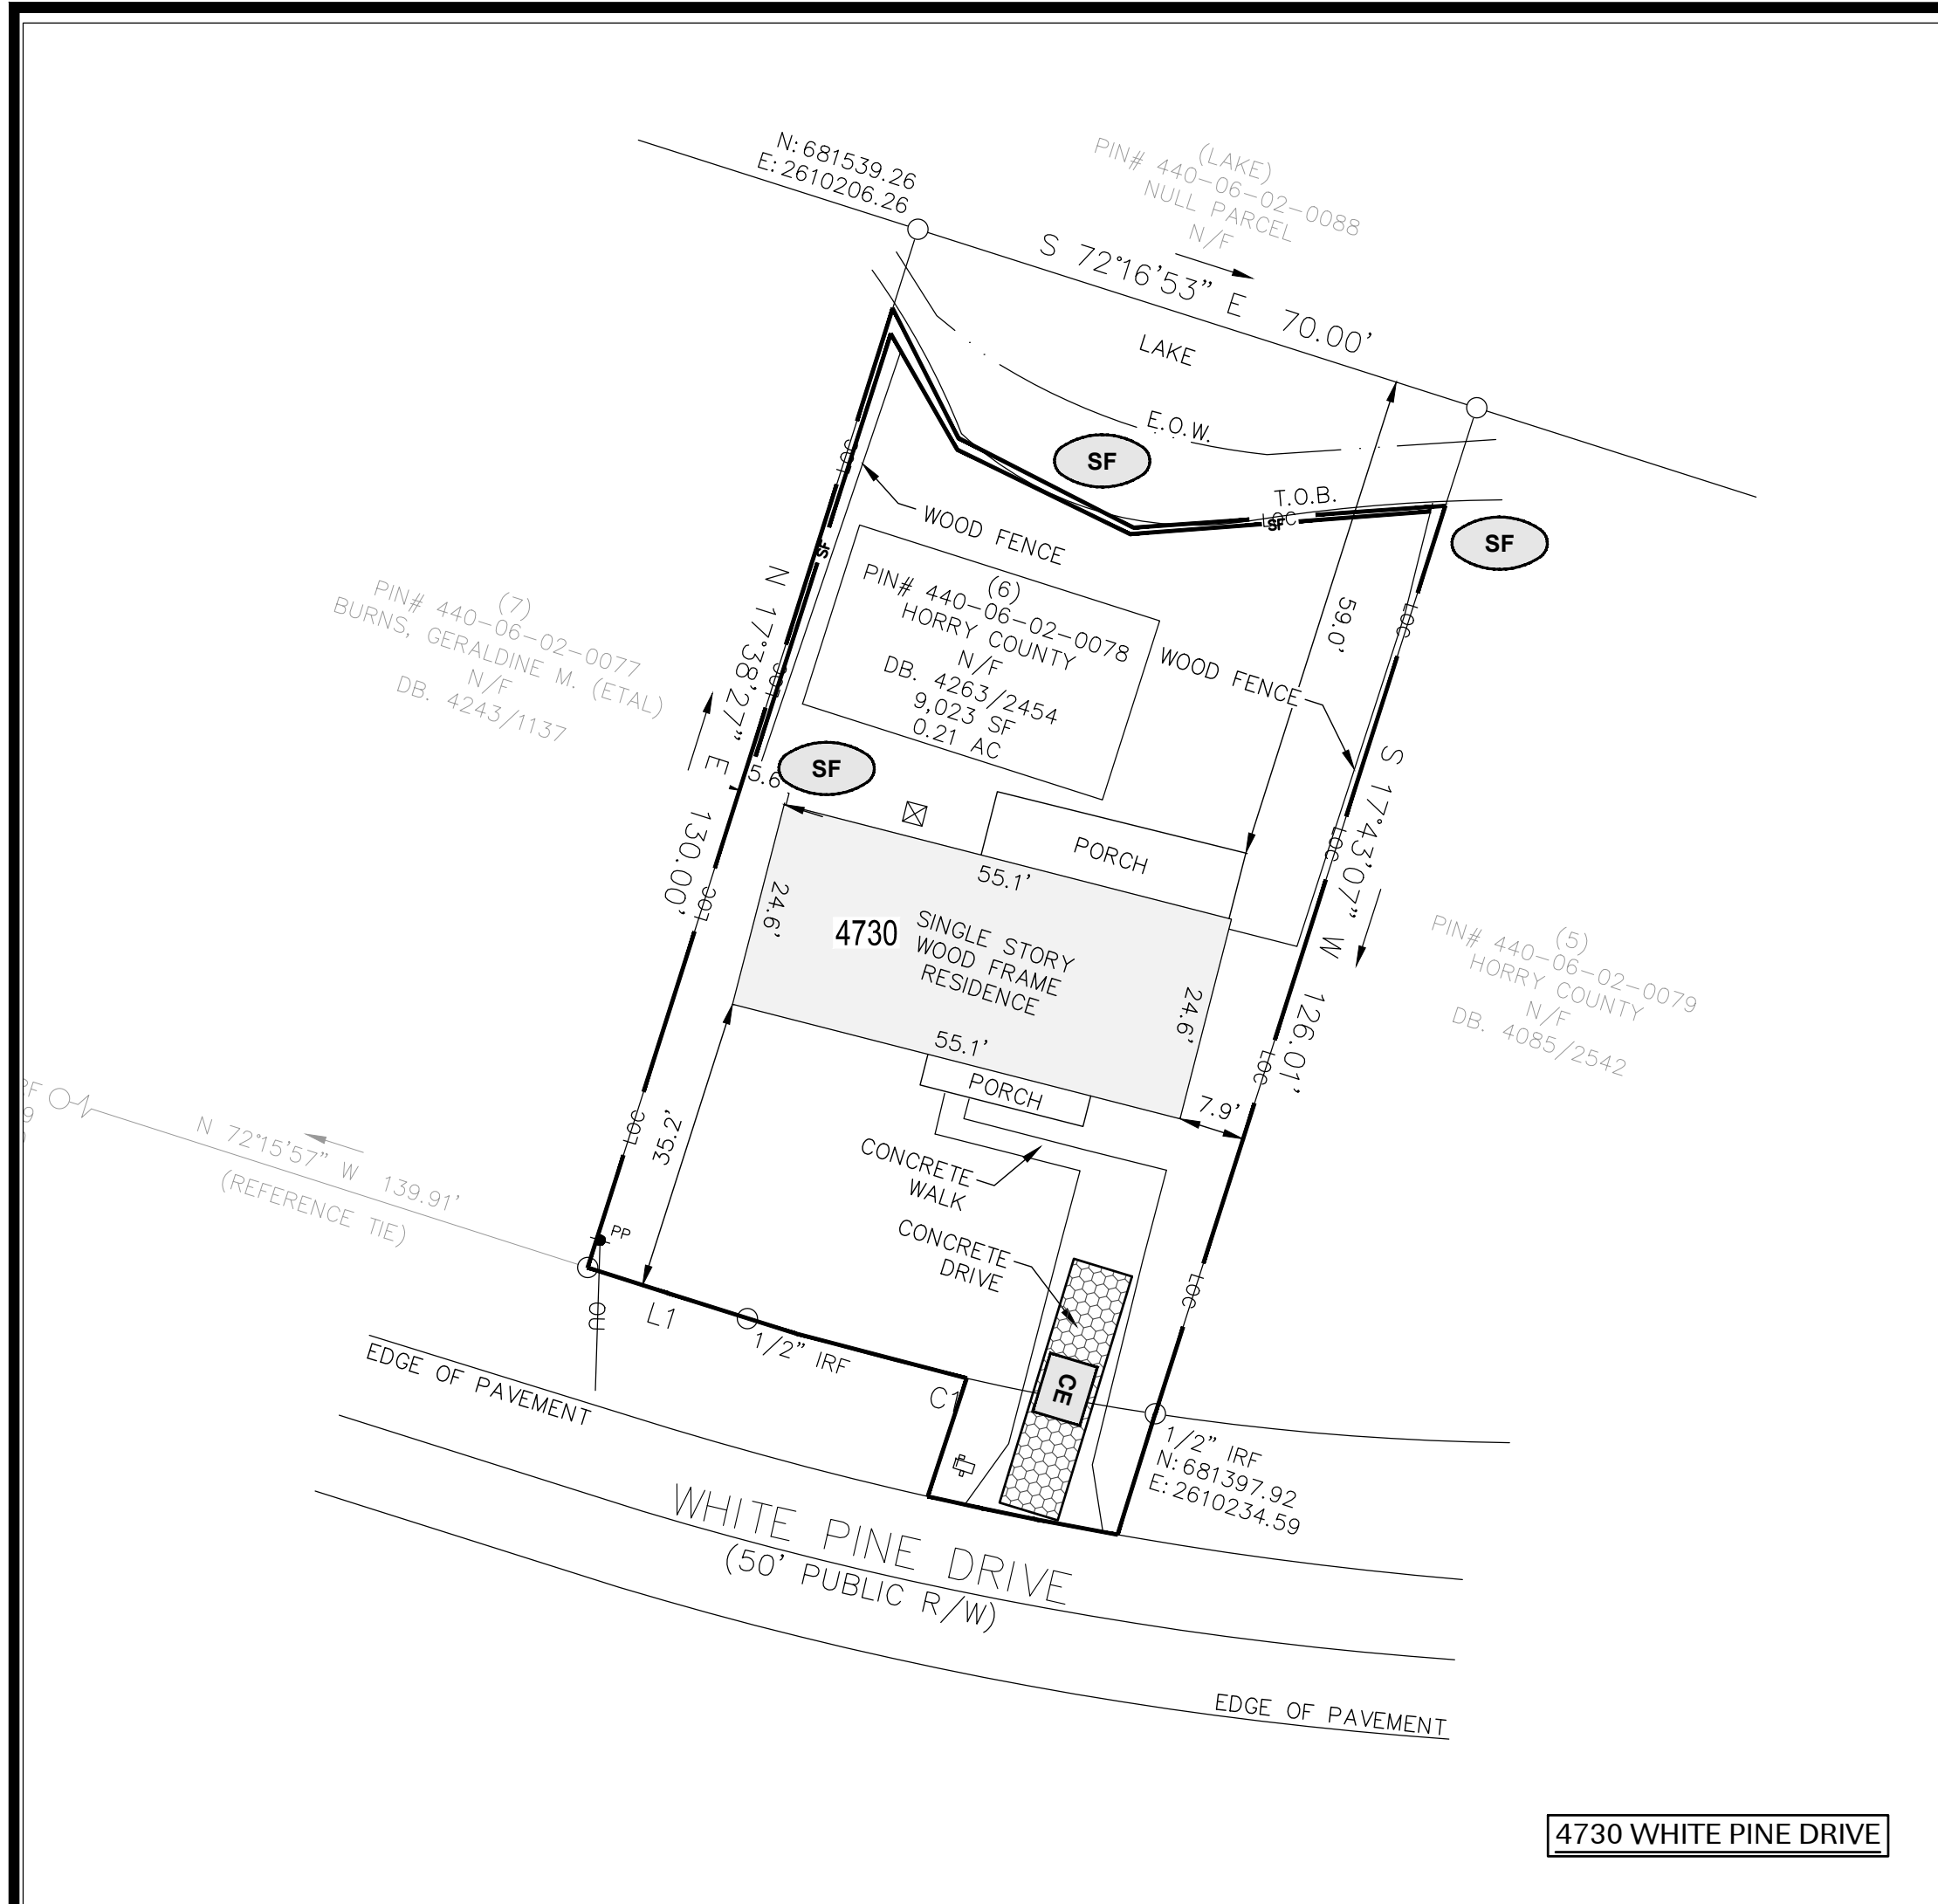

LEGEND			
LOC	LIMITS OF DISTURBANCE	SF	SILT FENCE
CE	TEMPORARY CONSTRUCTION ENTRANCE/EXIT	IPa	INLET PROTECTION DET. A
IPe	INLET PROTECTION DET. E		SEDIMENT TUBES

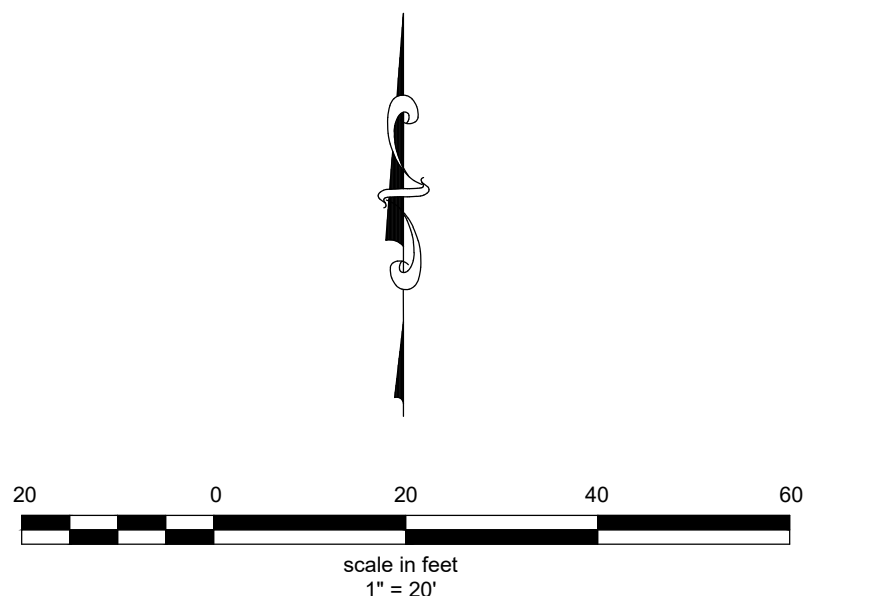


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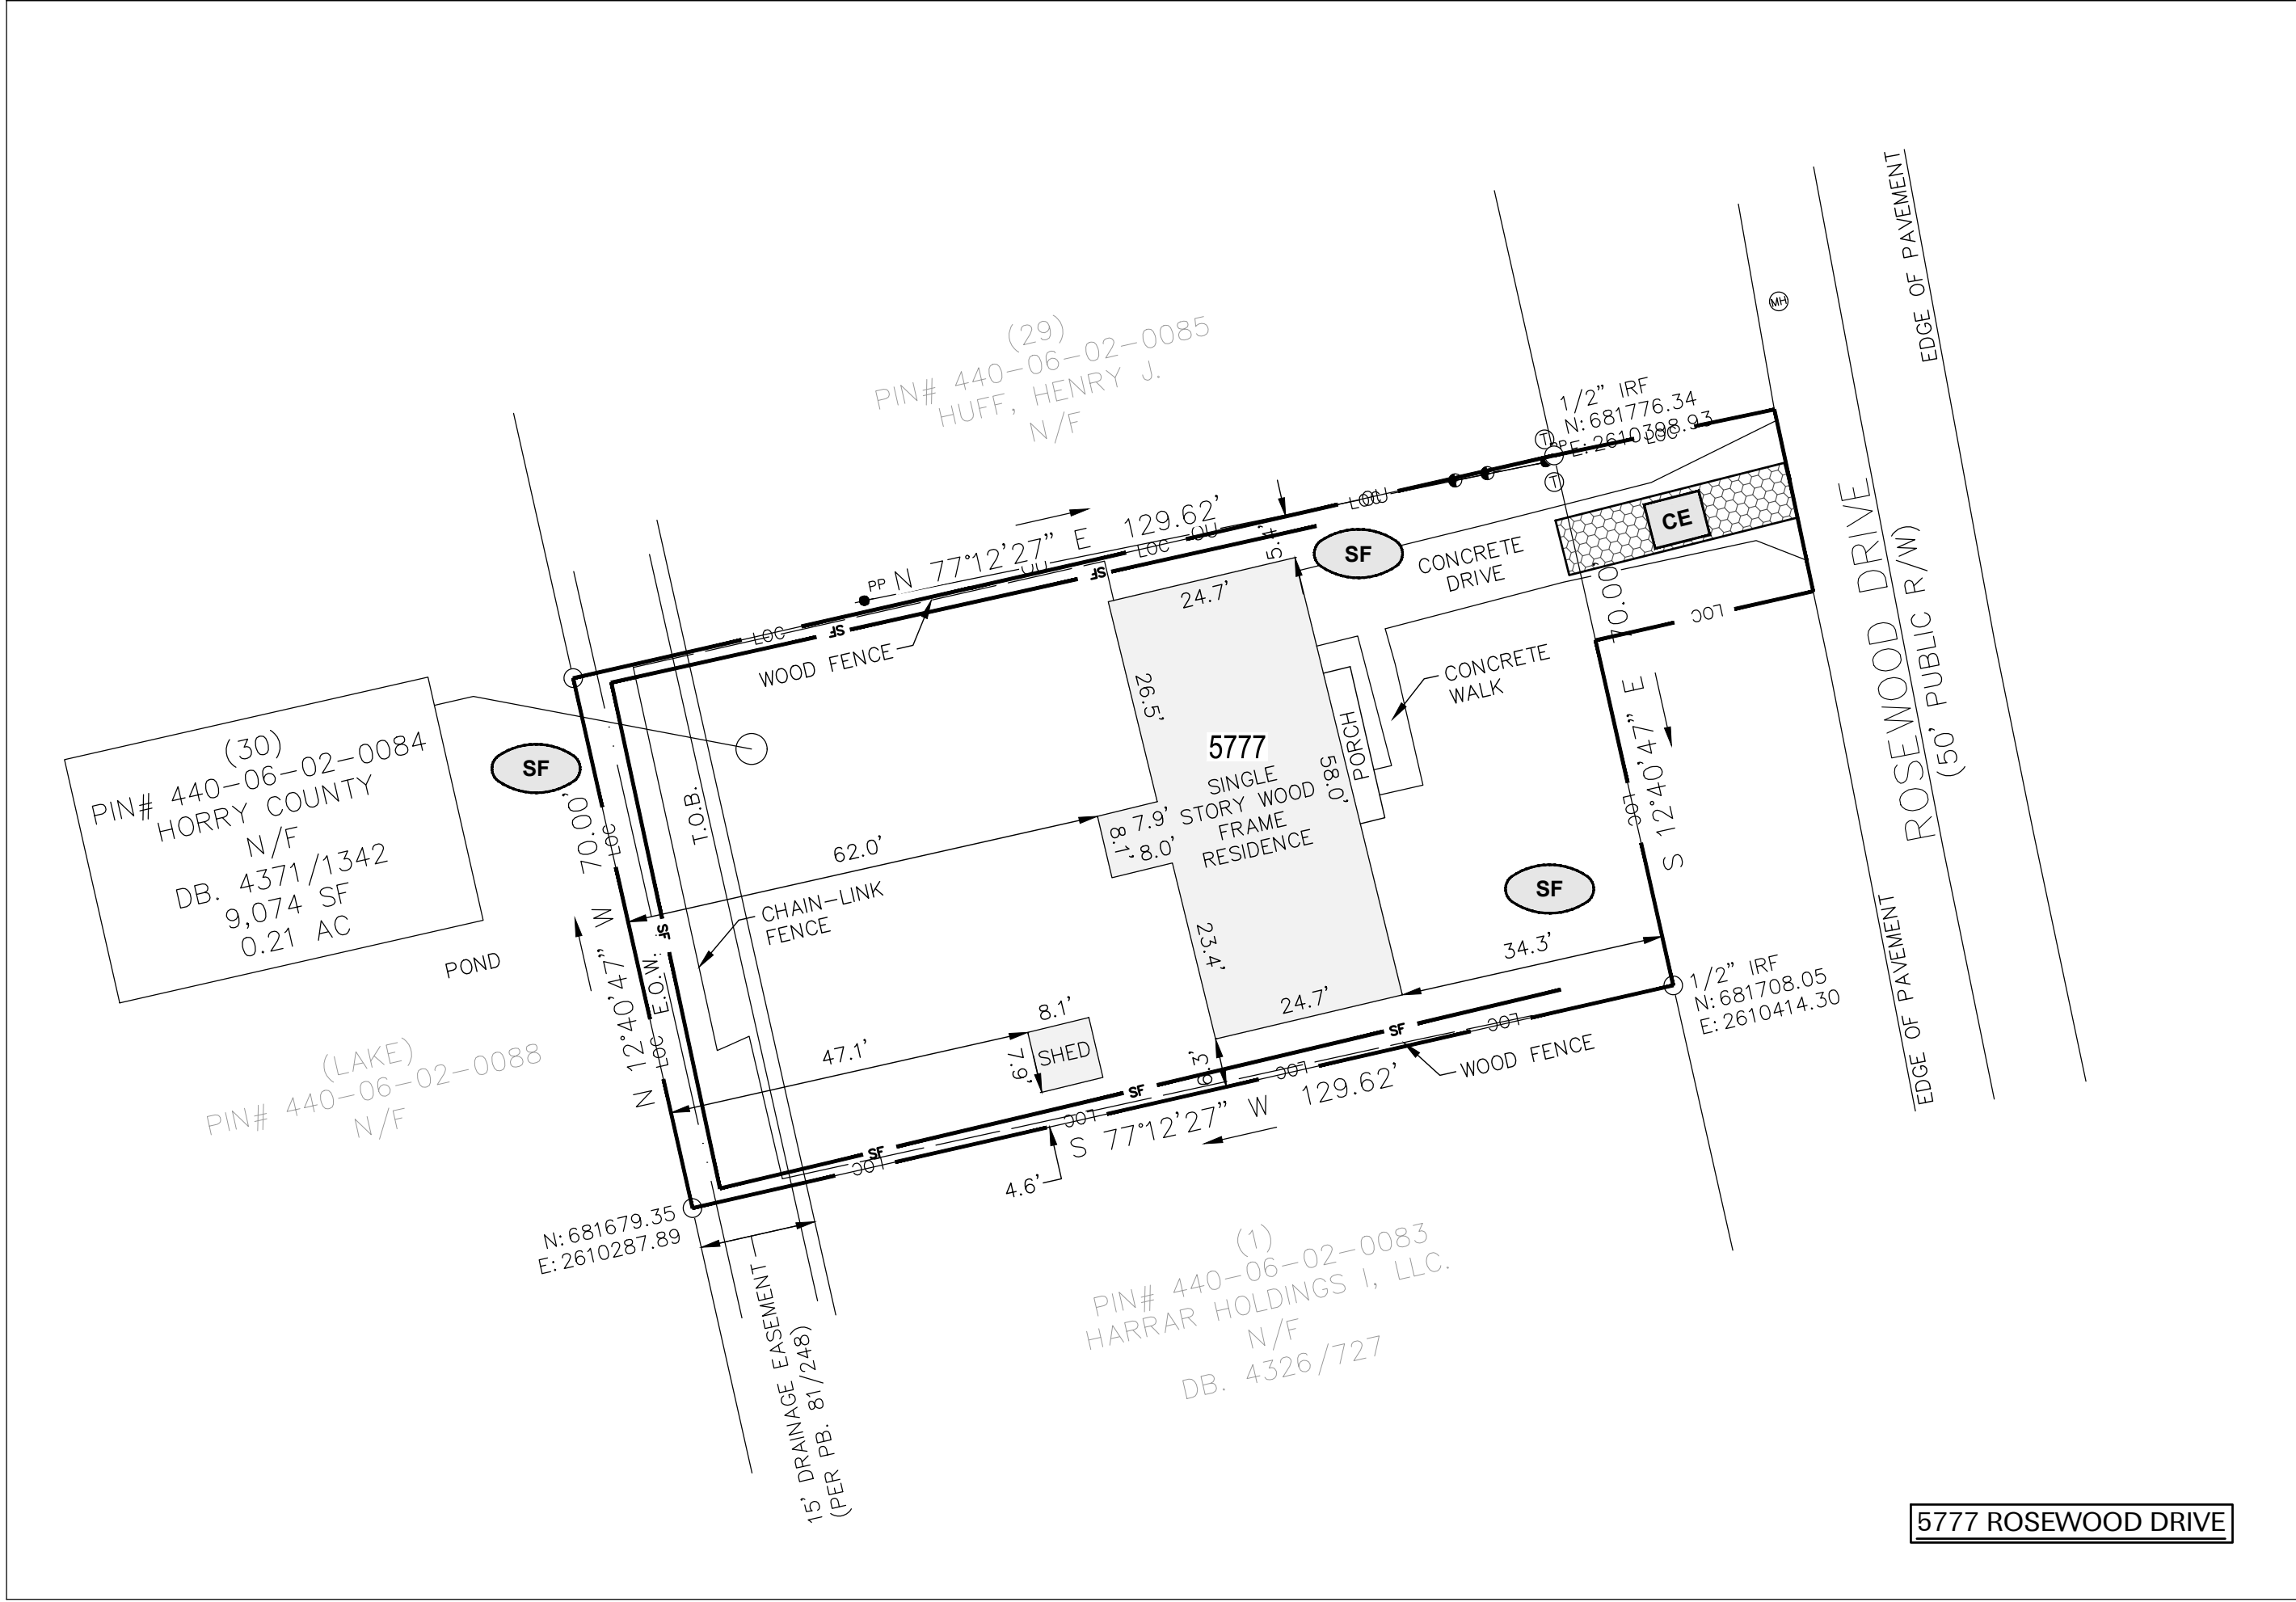
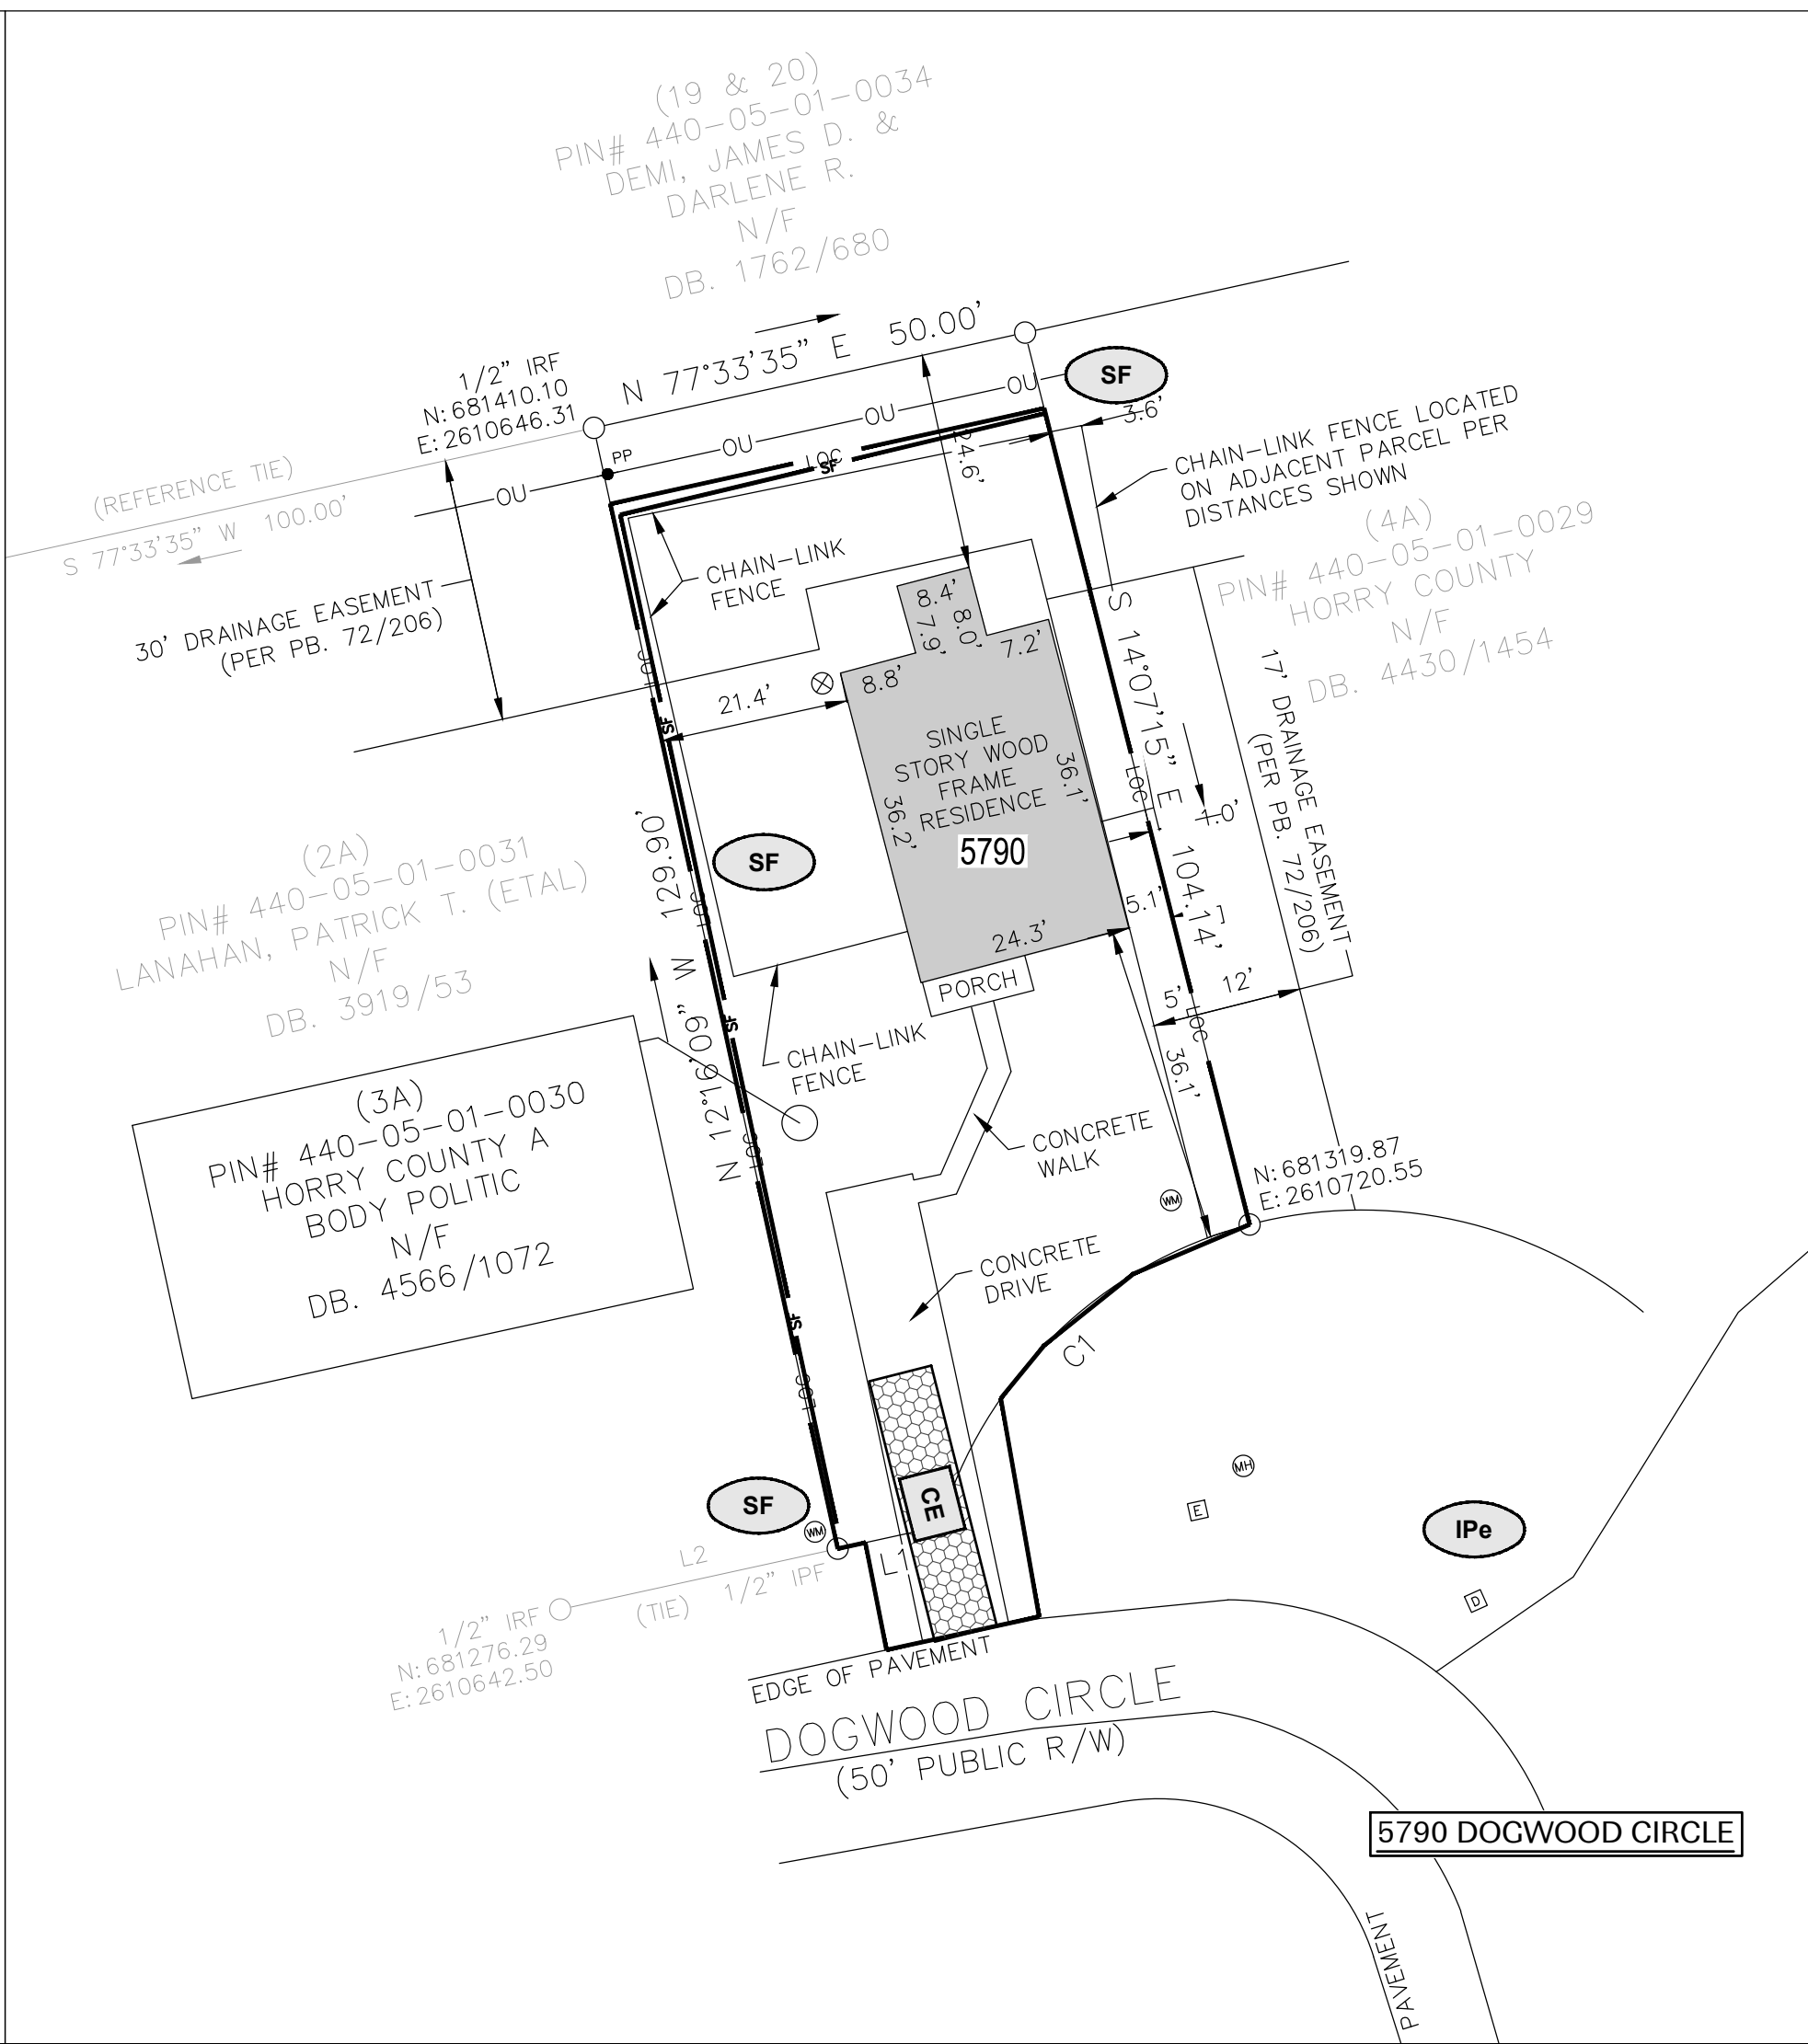
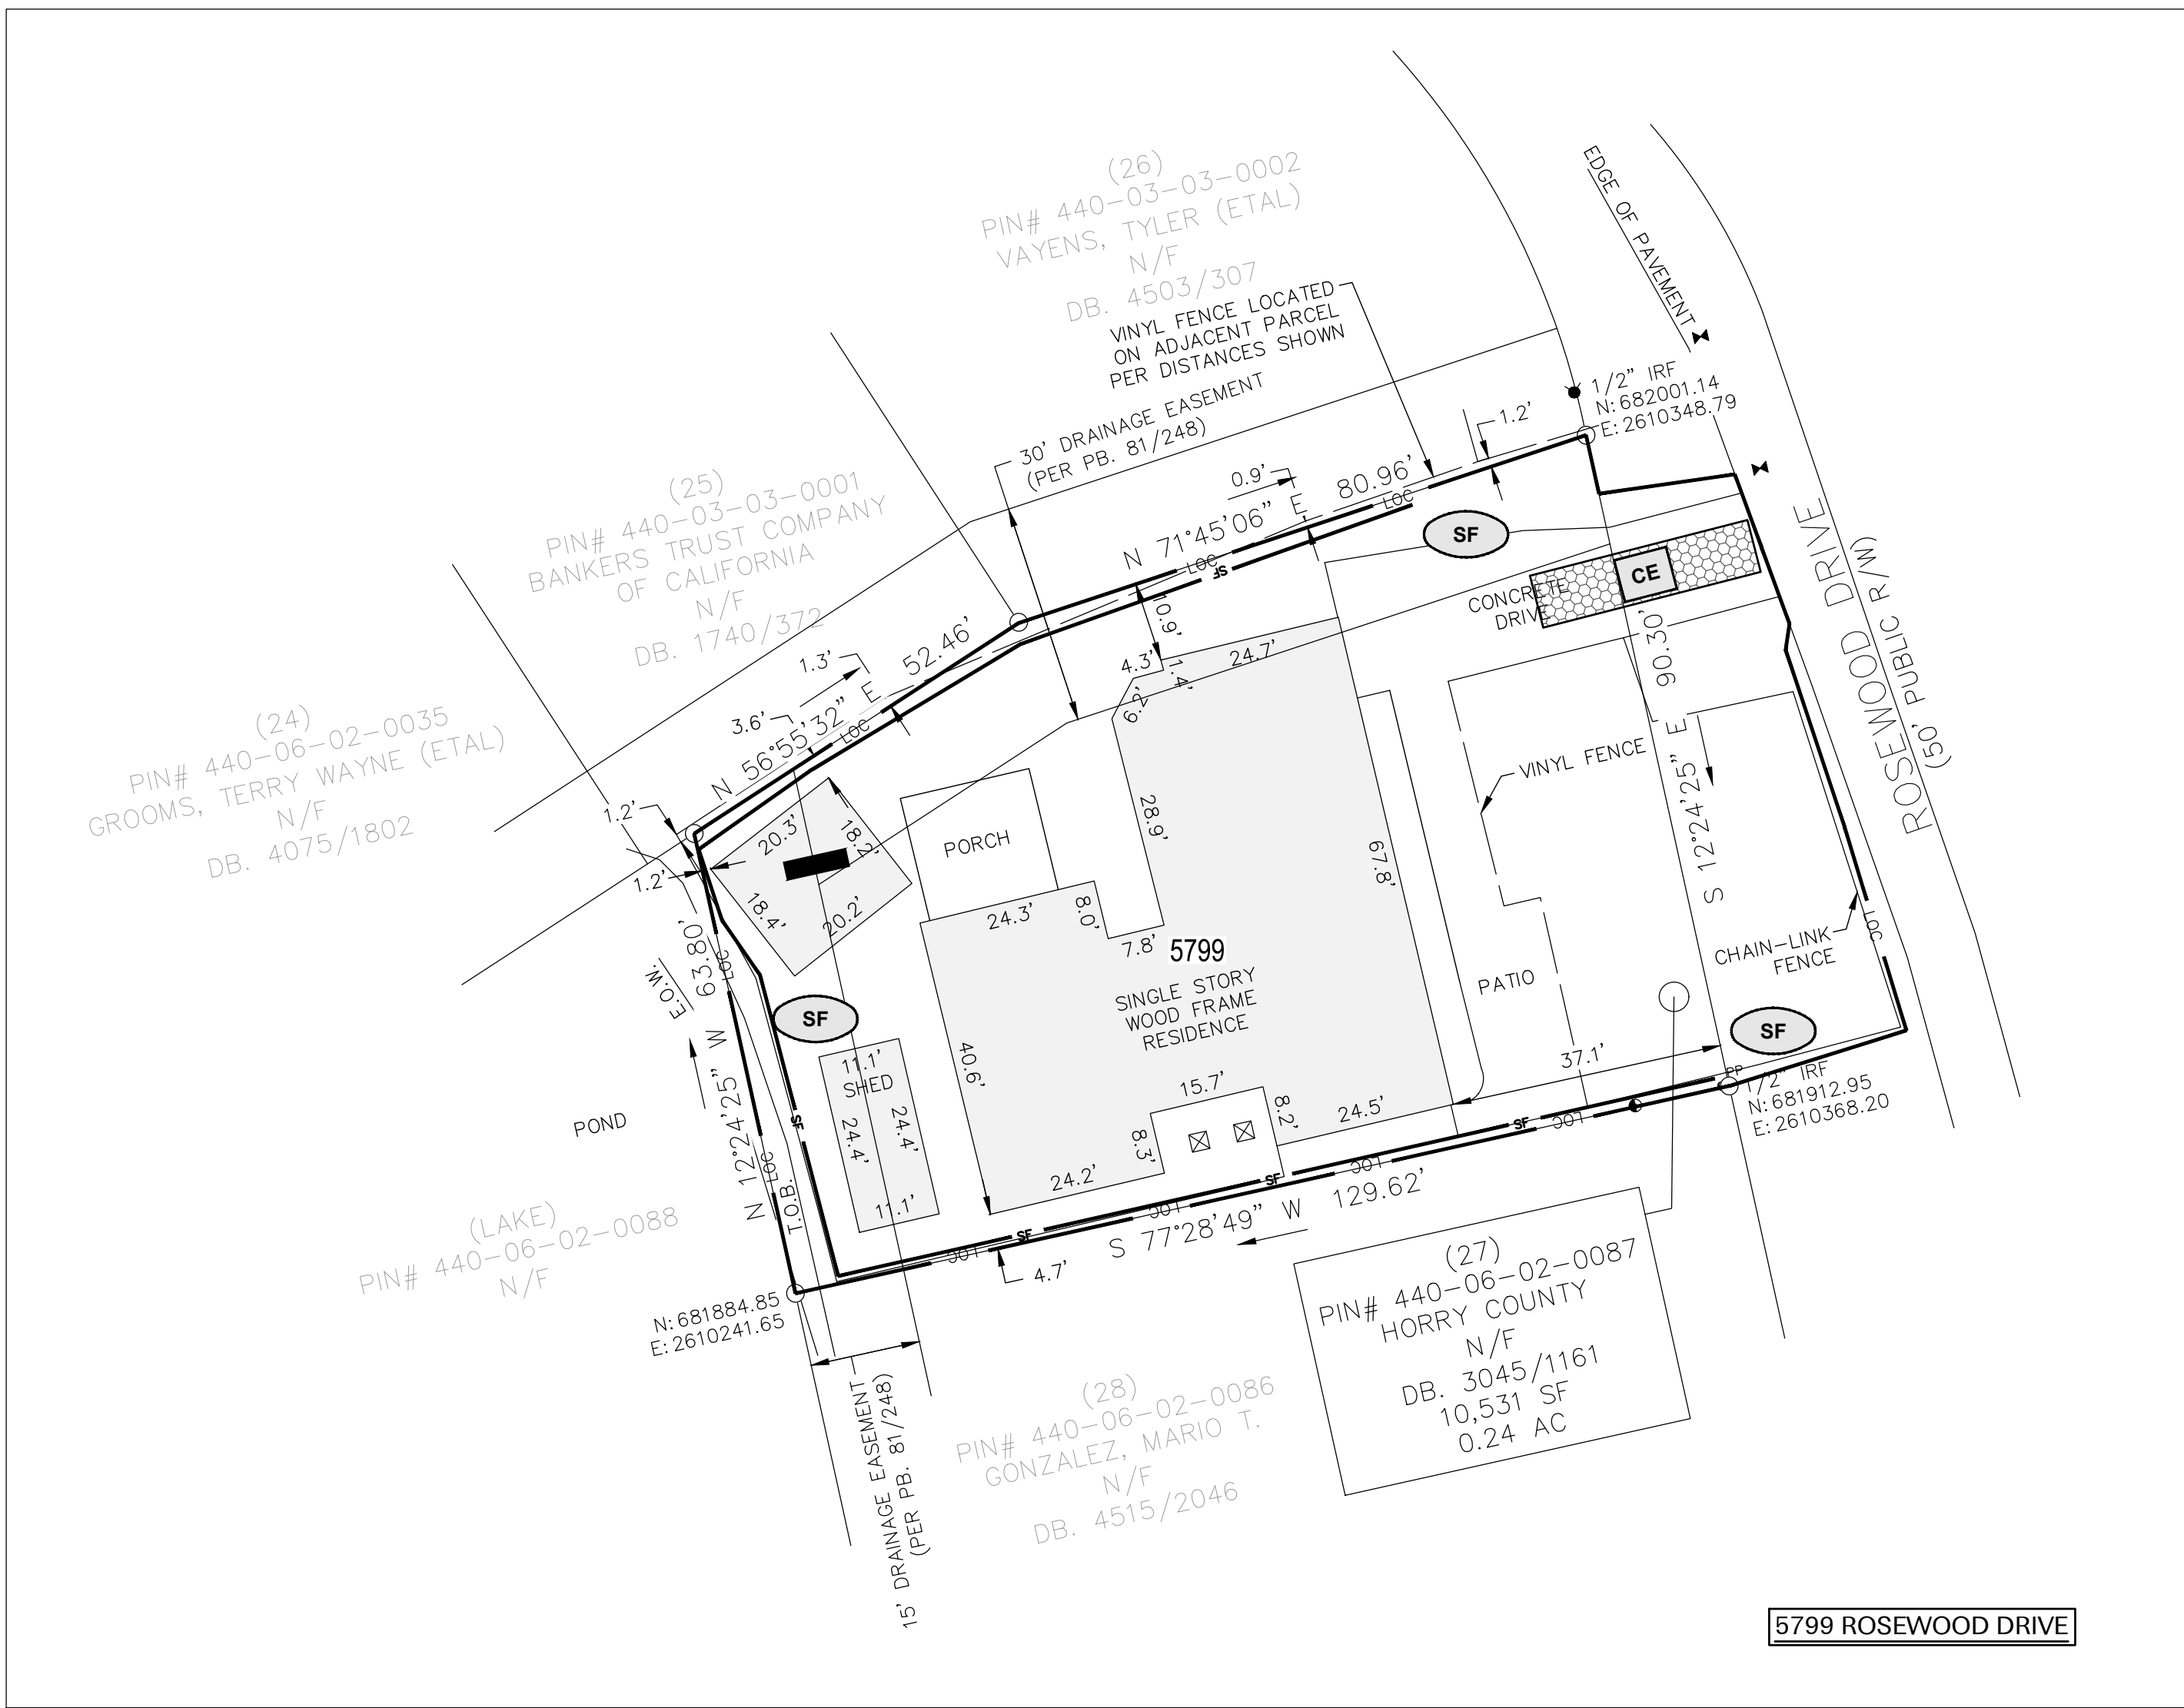
HORRY COUNTY BUYOUT
DEMOLITION PLAN - PHASE 1S

SOUTH CAROLINA OFFICE OF RESILIENCE
HORRY COUNTY, SOUTH CAROLINA


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
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Project No. 230-N027-M	No.
Drawn By	Name
Date	
Checked By	
Date	
Approved By	
Date	



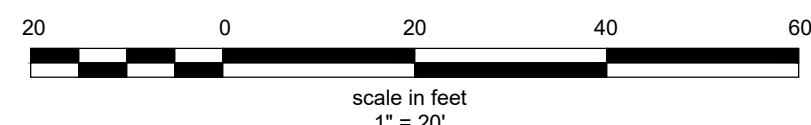



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— LOC —	LIMITS OF DISTURBANCE		
— SF —	SILT FENCE	(SF)	
(CE)	TEMPORARY CONSTRUCTION ENTRANCE/EXIT		
(IPa)	INLET PROTECTION DET. A		
(IPe)	INLET PROTECTION DET. E		
(ST)	SEDIMENT TUBES		



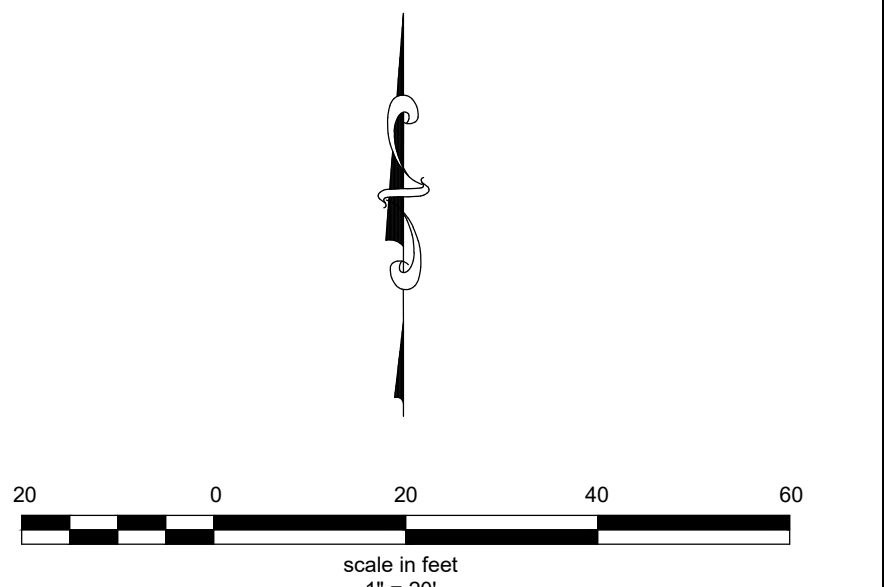

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**HORRY COUNTY BUYOUT
DEMOLITION PLAN - PHASE 1S**


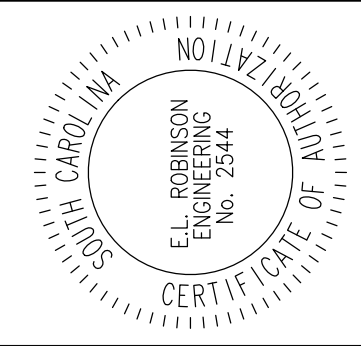
SOUTH CAROLINA OFFICE OF RESILIENCE
HORRY COUNTY, SOUTH CAROLINA

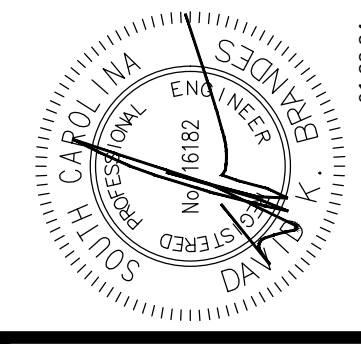Revisions	No.	Name	Date





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Drawn By	Checked By
09.08.23	09.08.23
Date	Date
09.08.23	09.08.23
Approved By	Approved By
DOB	DOB

**DEMOLITION
PLAN -
PHASE 1**

C2.6

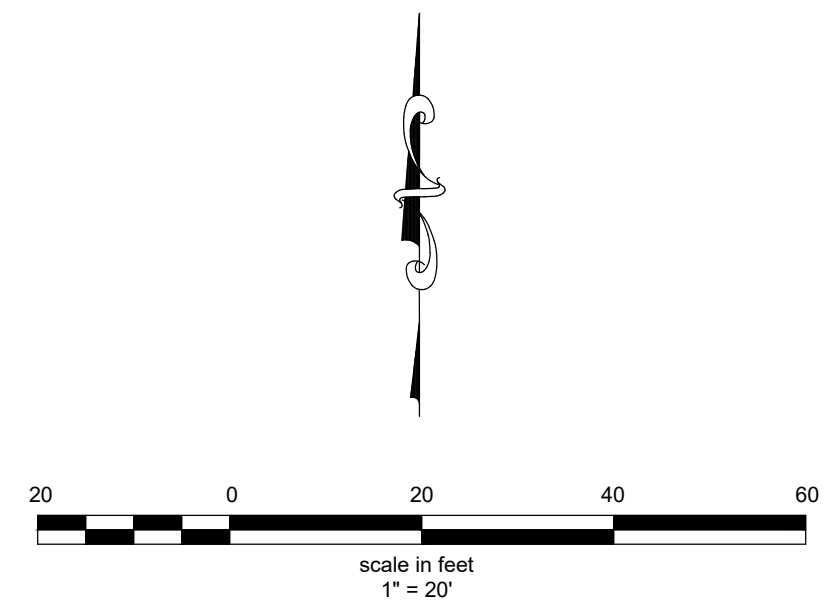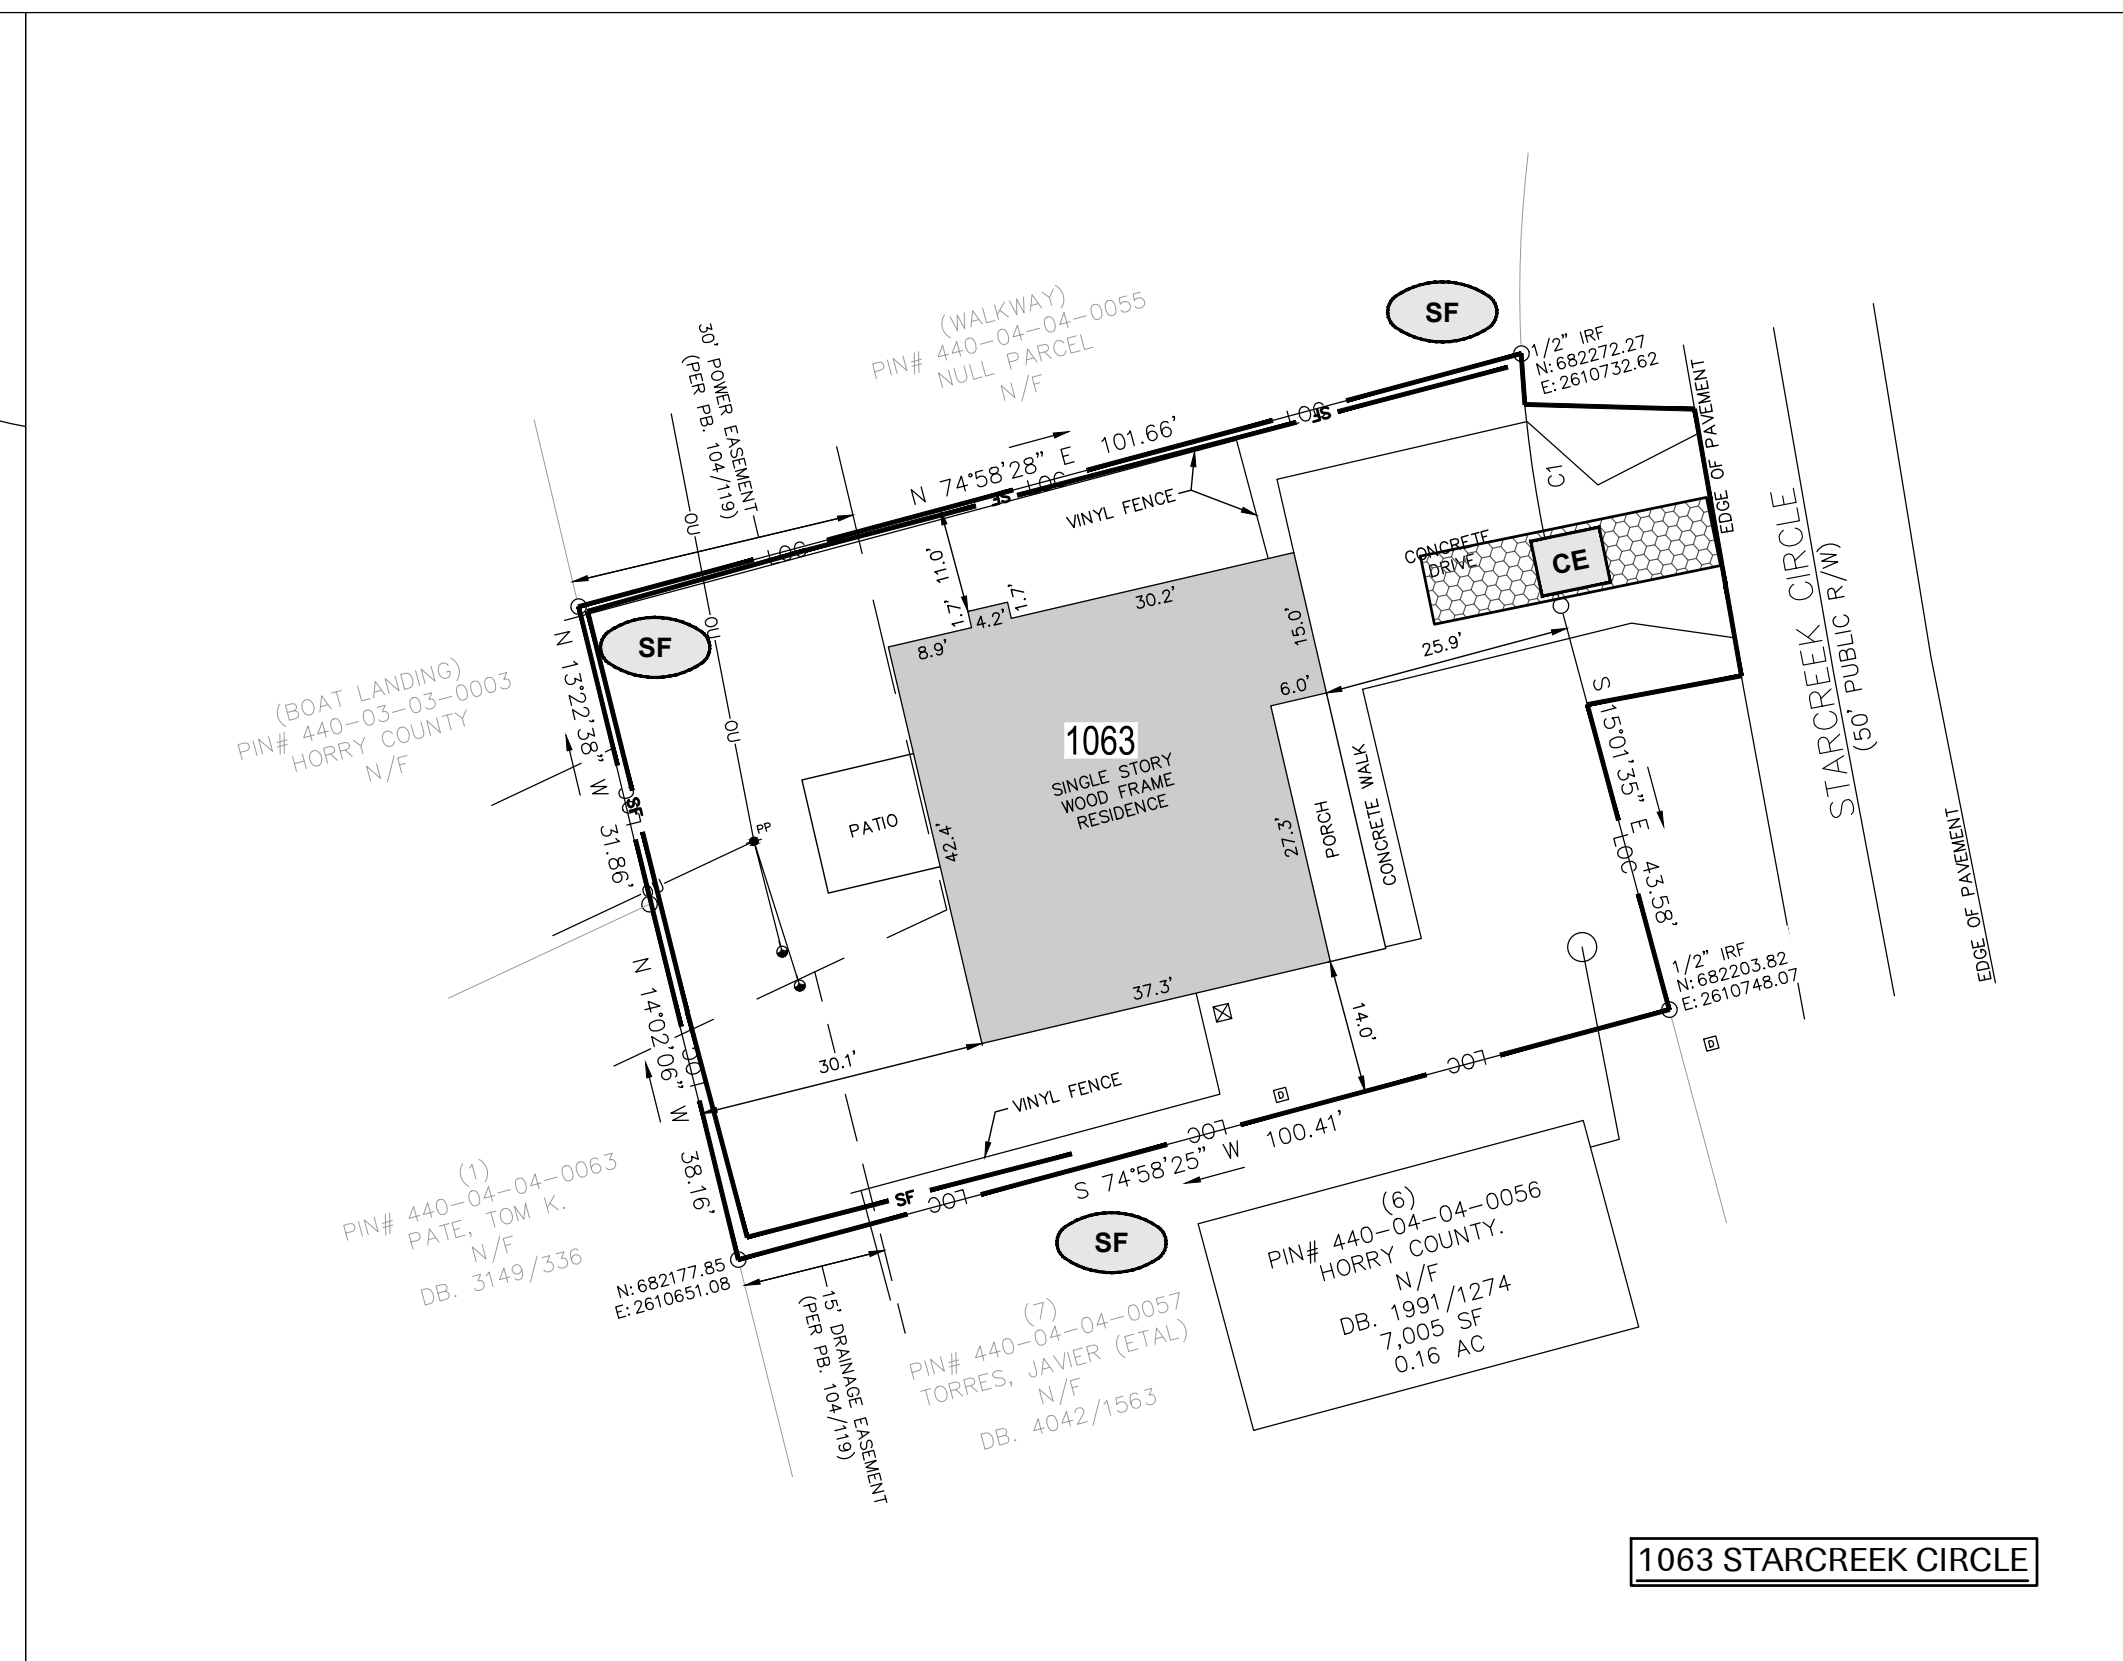

DEMOLITION PLAN - PHASE 1	Project No. D30-N027-M	No.	Name	Date
	Drawn By CWS			
	Date 09.08.23			
	Checked by DKB			
	Date 09.08.23			
	Approved By DKB			
HORRY COUNTY BUYOUT DEMOLITION PLAN - PHASE 1S				
SOUTH CAROLINA OFFICE OF RESILIENCE HORRY COUNTY, SOUTH CAROLINA				
E.L. ROBINSON ENGINEERING 1301 Cervaiss St., Suite 450 Columbia, SC 29201 Phone: (803) 400-6031 www.elrobinsonengineering.com				

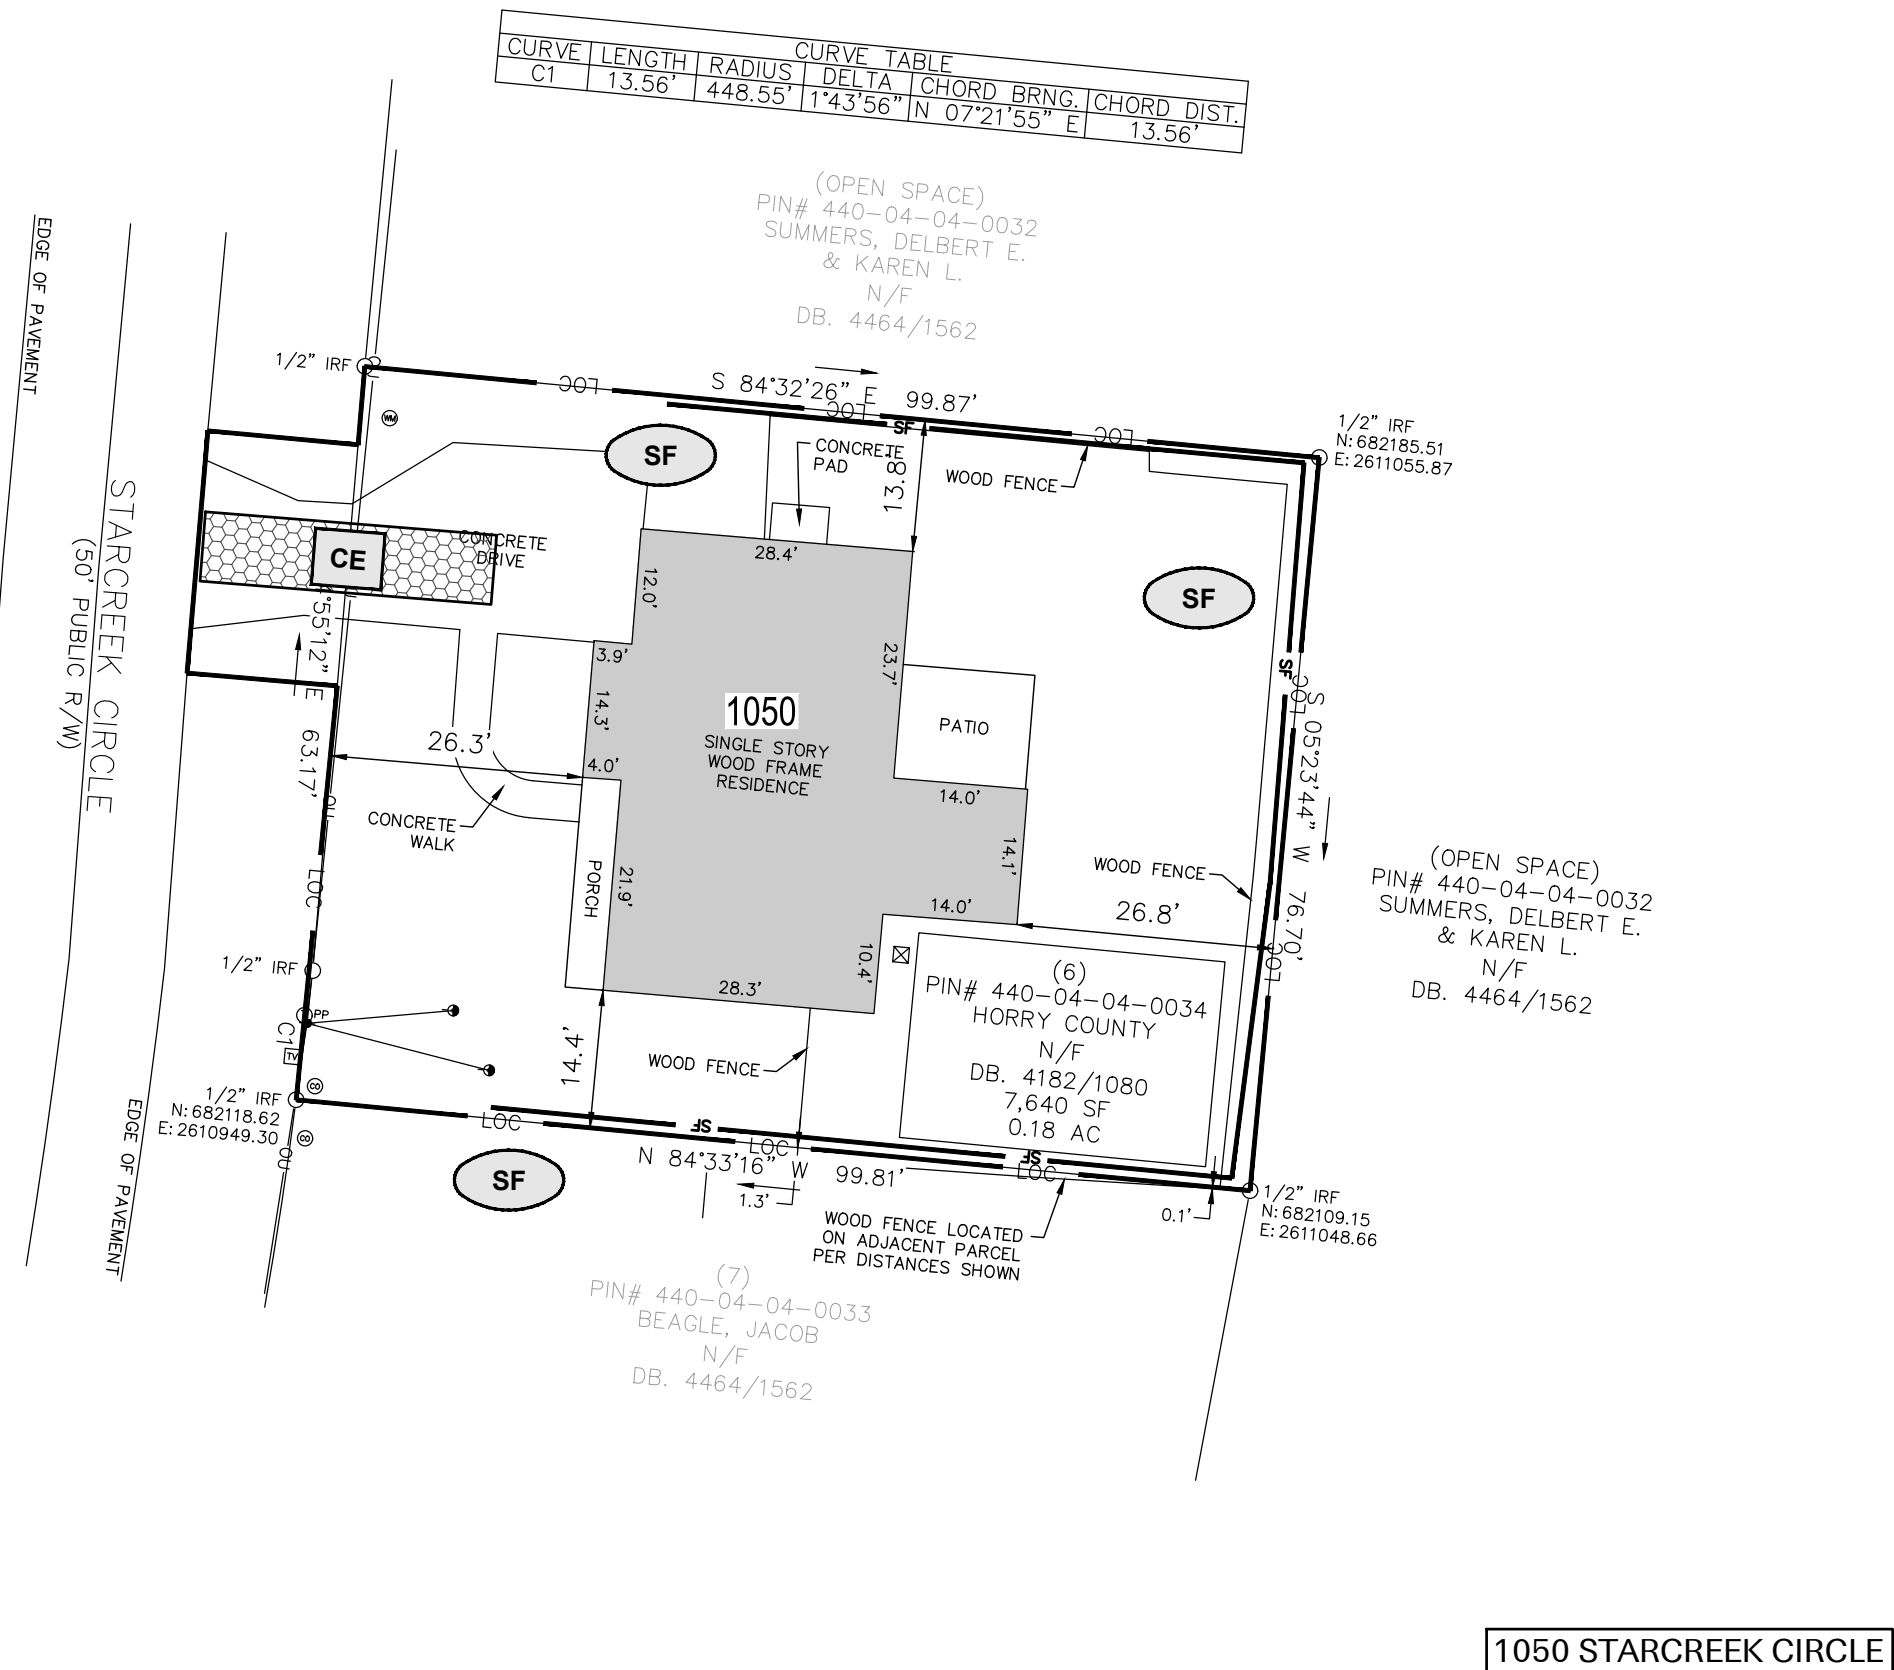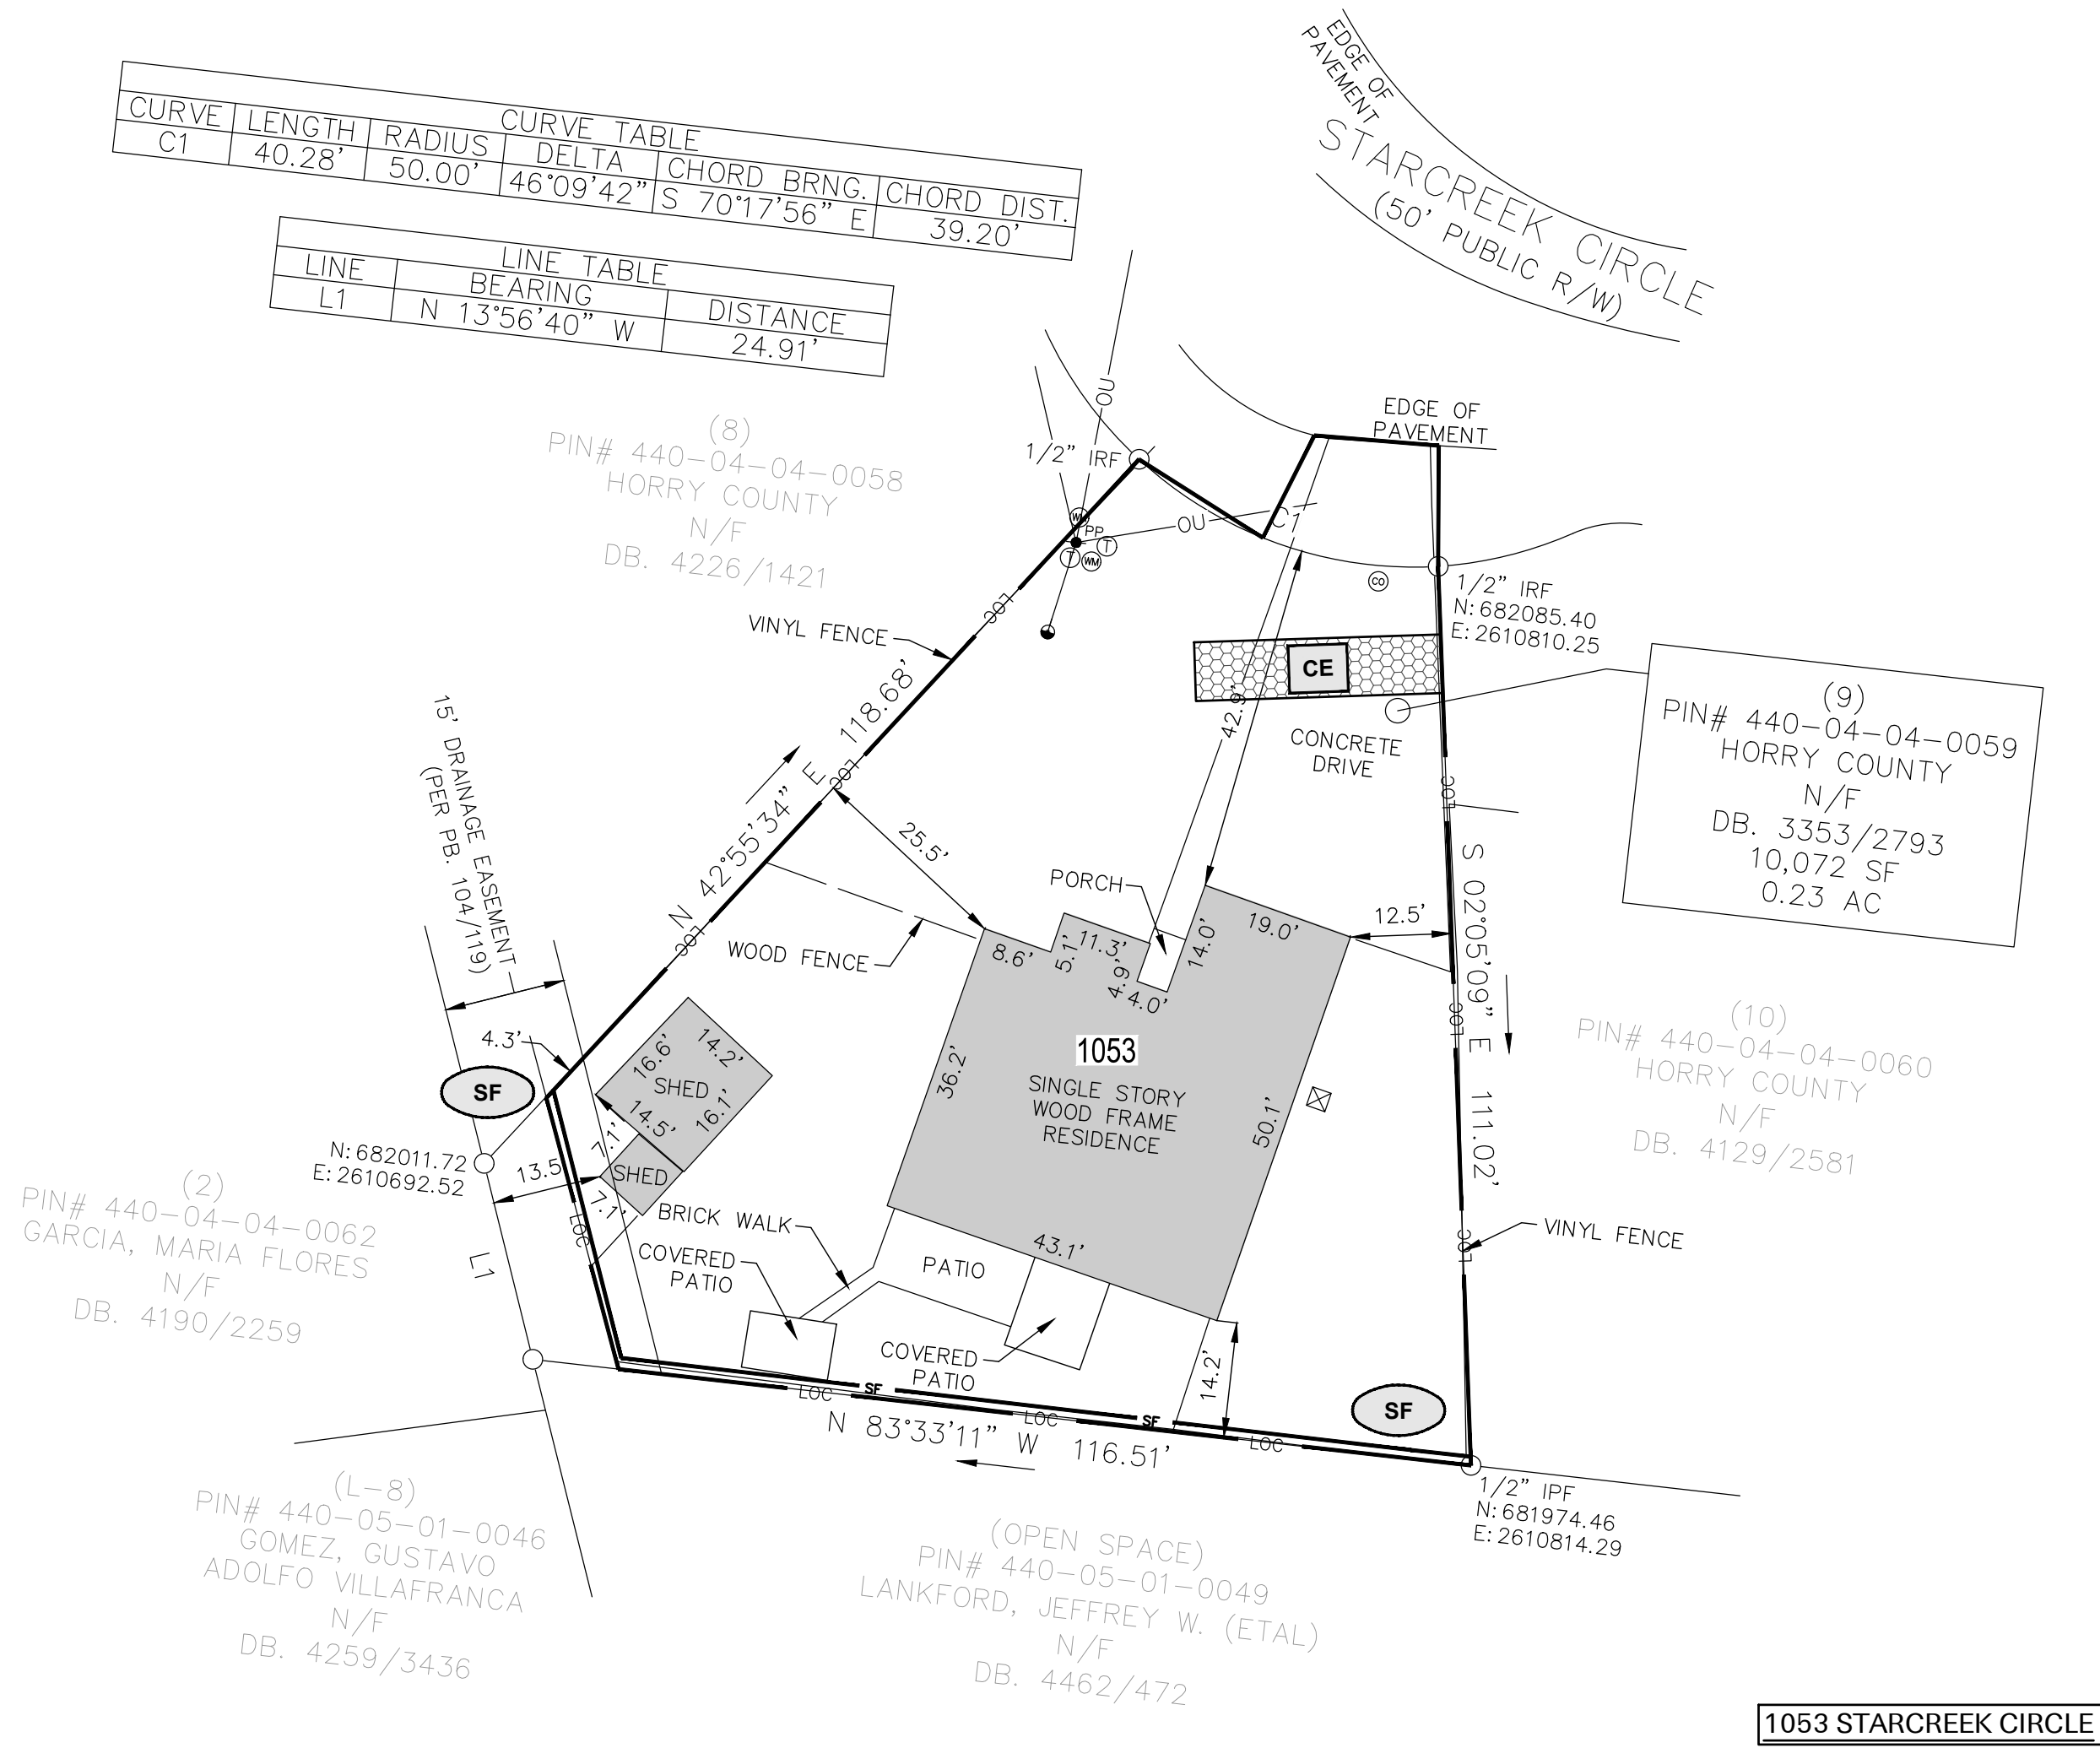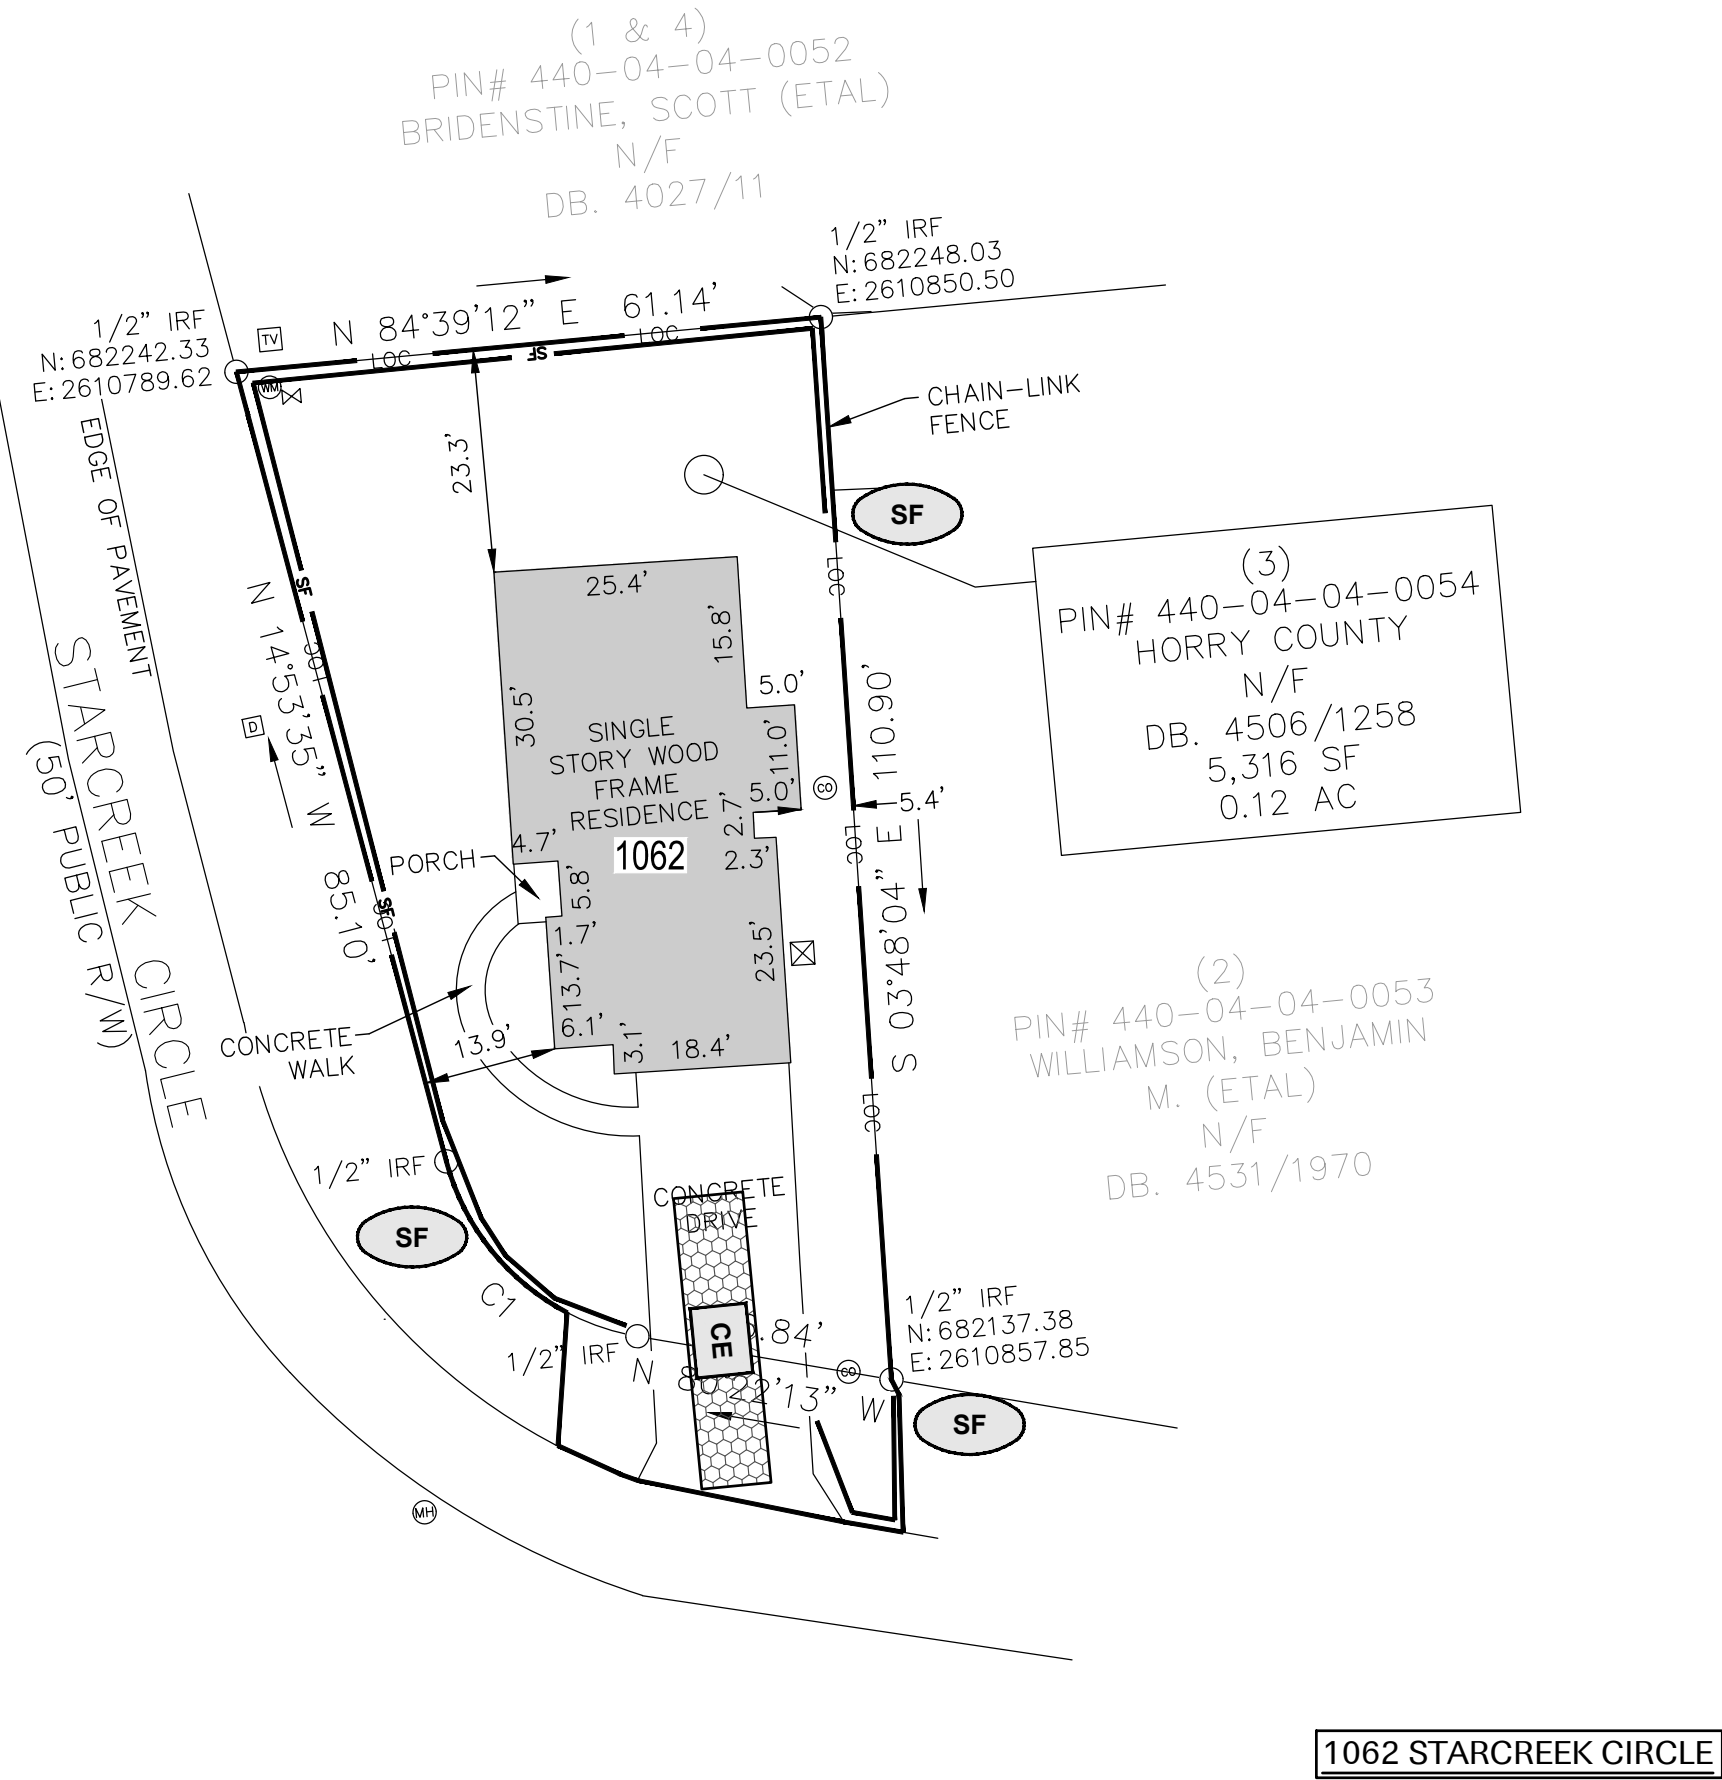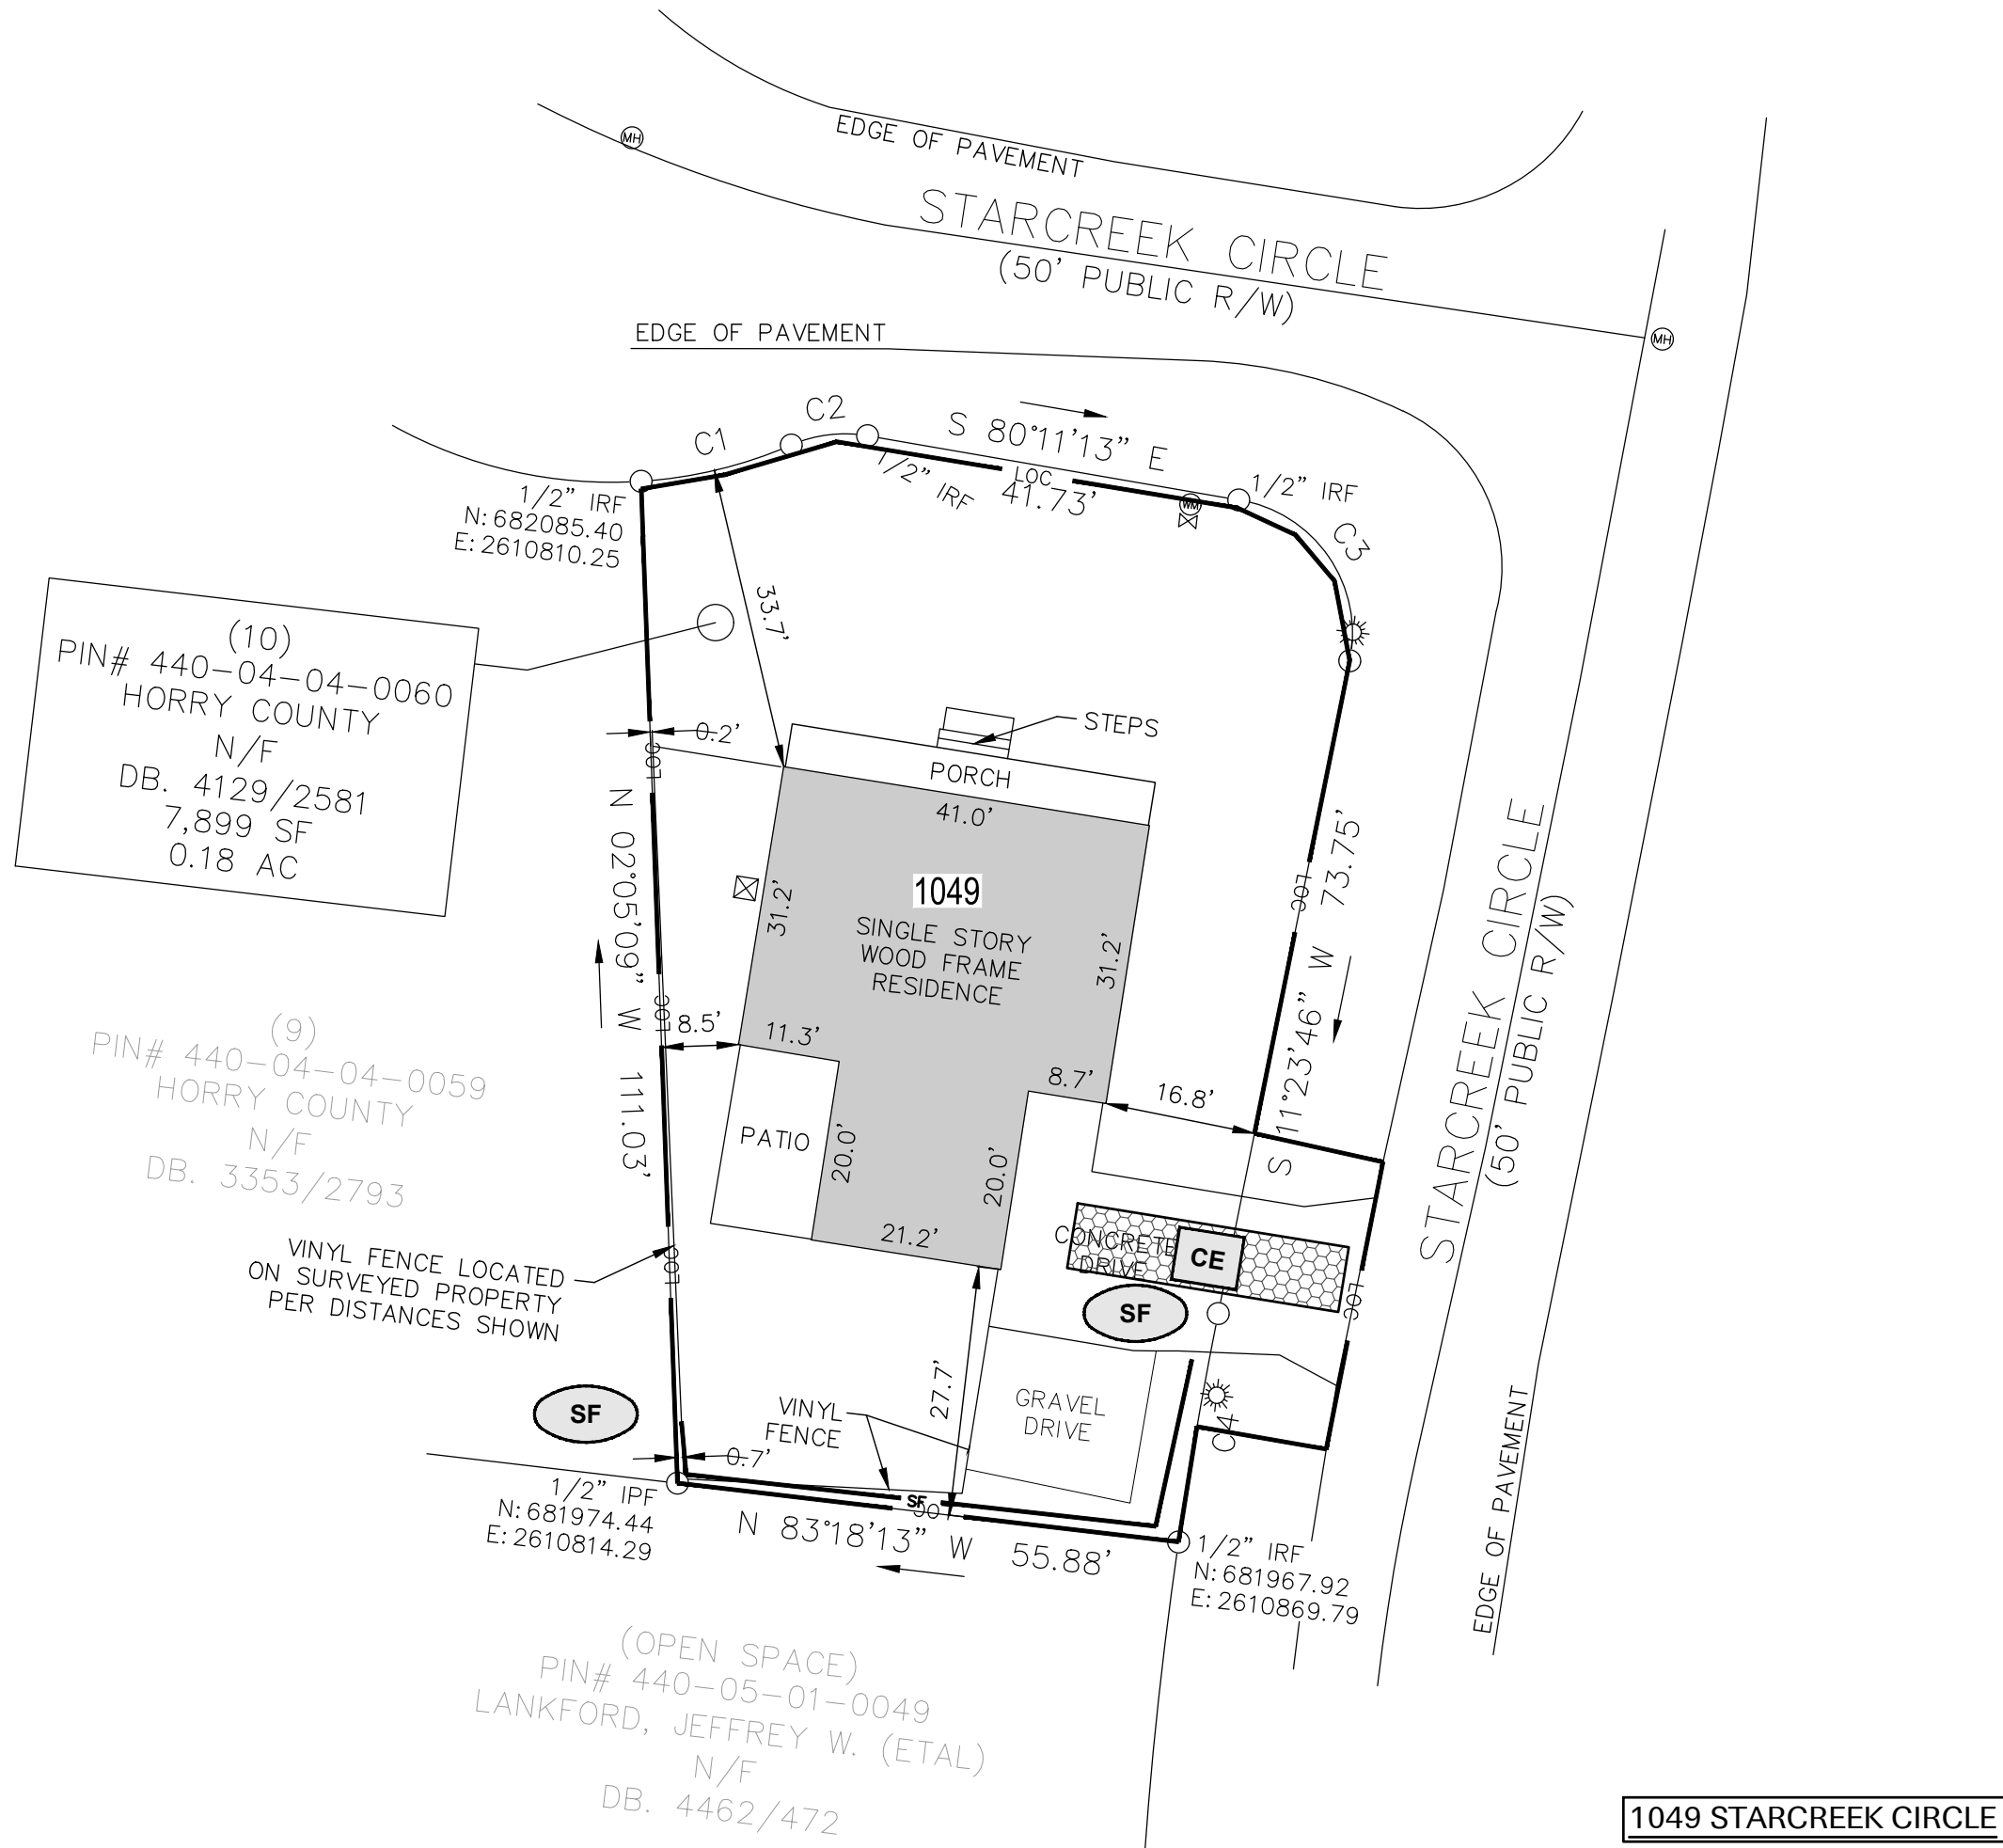

LEGEND

- LOC LIMITS OF DISTURBANCE
- SF SILT FENCE
- CE TEMPORARY CONSTRUCTION ENTRANCE/EXIT
- IPa INLET PROTECTION DET. A
- IPe INLET PROTECTION DET. E
- SEDIMENT TUBES

20 0 20 40 60
scale in feet
1" = 20'

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Professional Engineer Seal for E.L. Robinson, No. 2544, State of South Carolina

HORRY COUNTY BUYOUT DEMOLITION PLAN - PHASE 1S


SOUTH CAROLINA OFFICE OF RESILIENCE
HORRY COUNTY, SOUTH CAROLINA

Project Title / Client Information	Revision	Date
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	No.	
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	No.	


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Drawn by	No.	
Date	No.	
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DWG	No.	
Date	No.	
Approved by	No.	
DWG	No.	

DEMOLITION PLAN - PHASE 1


C2.8

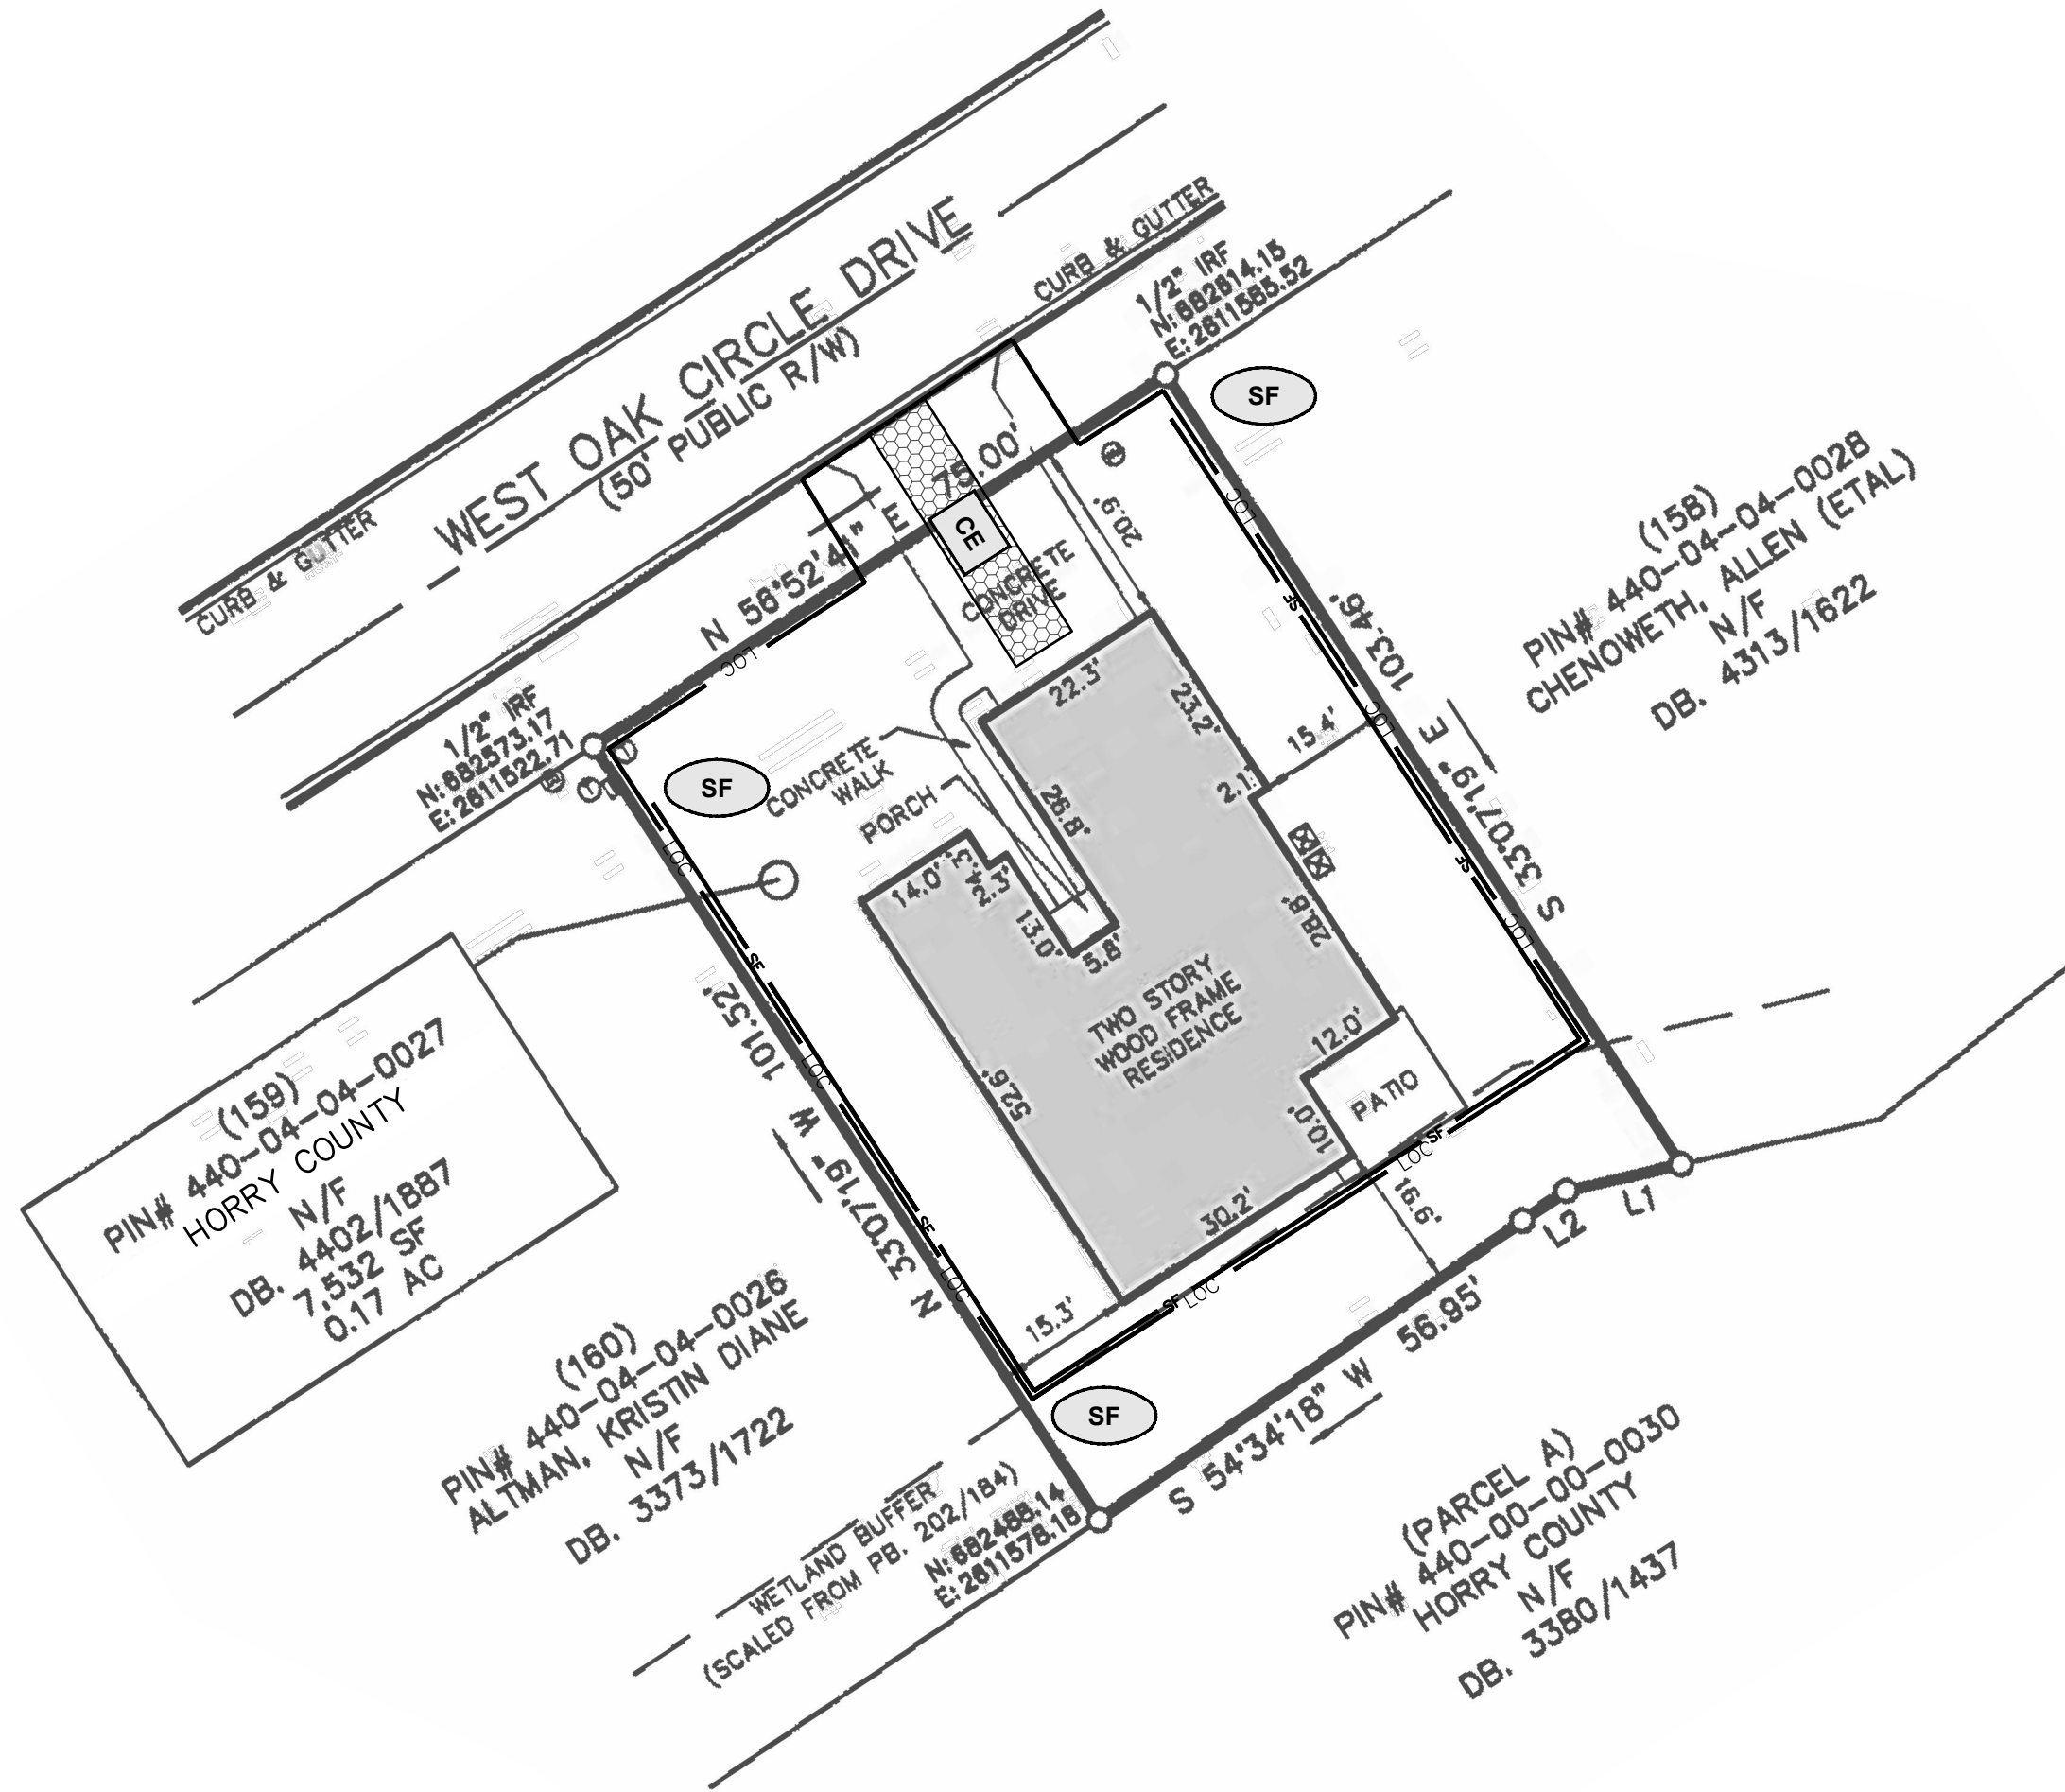


649 WEST OAK CIRCLE

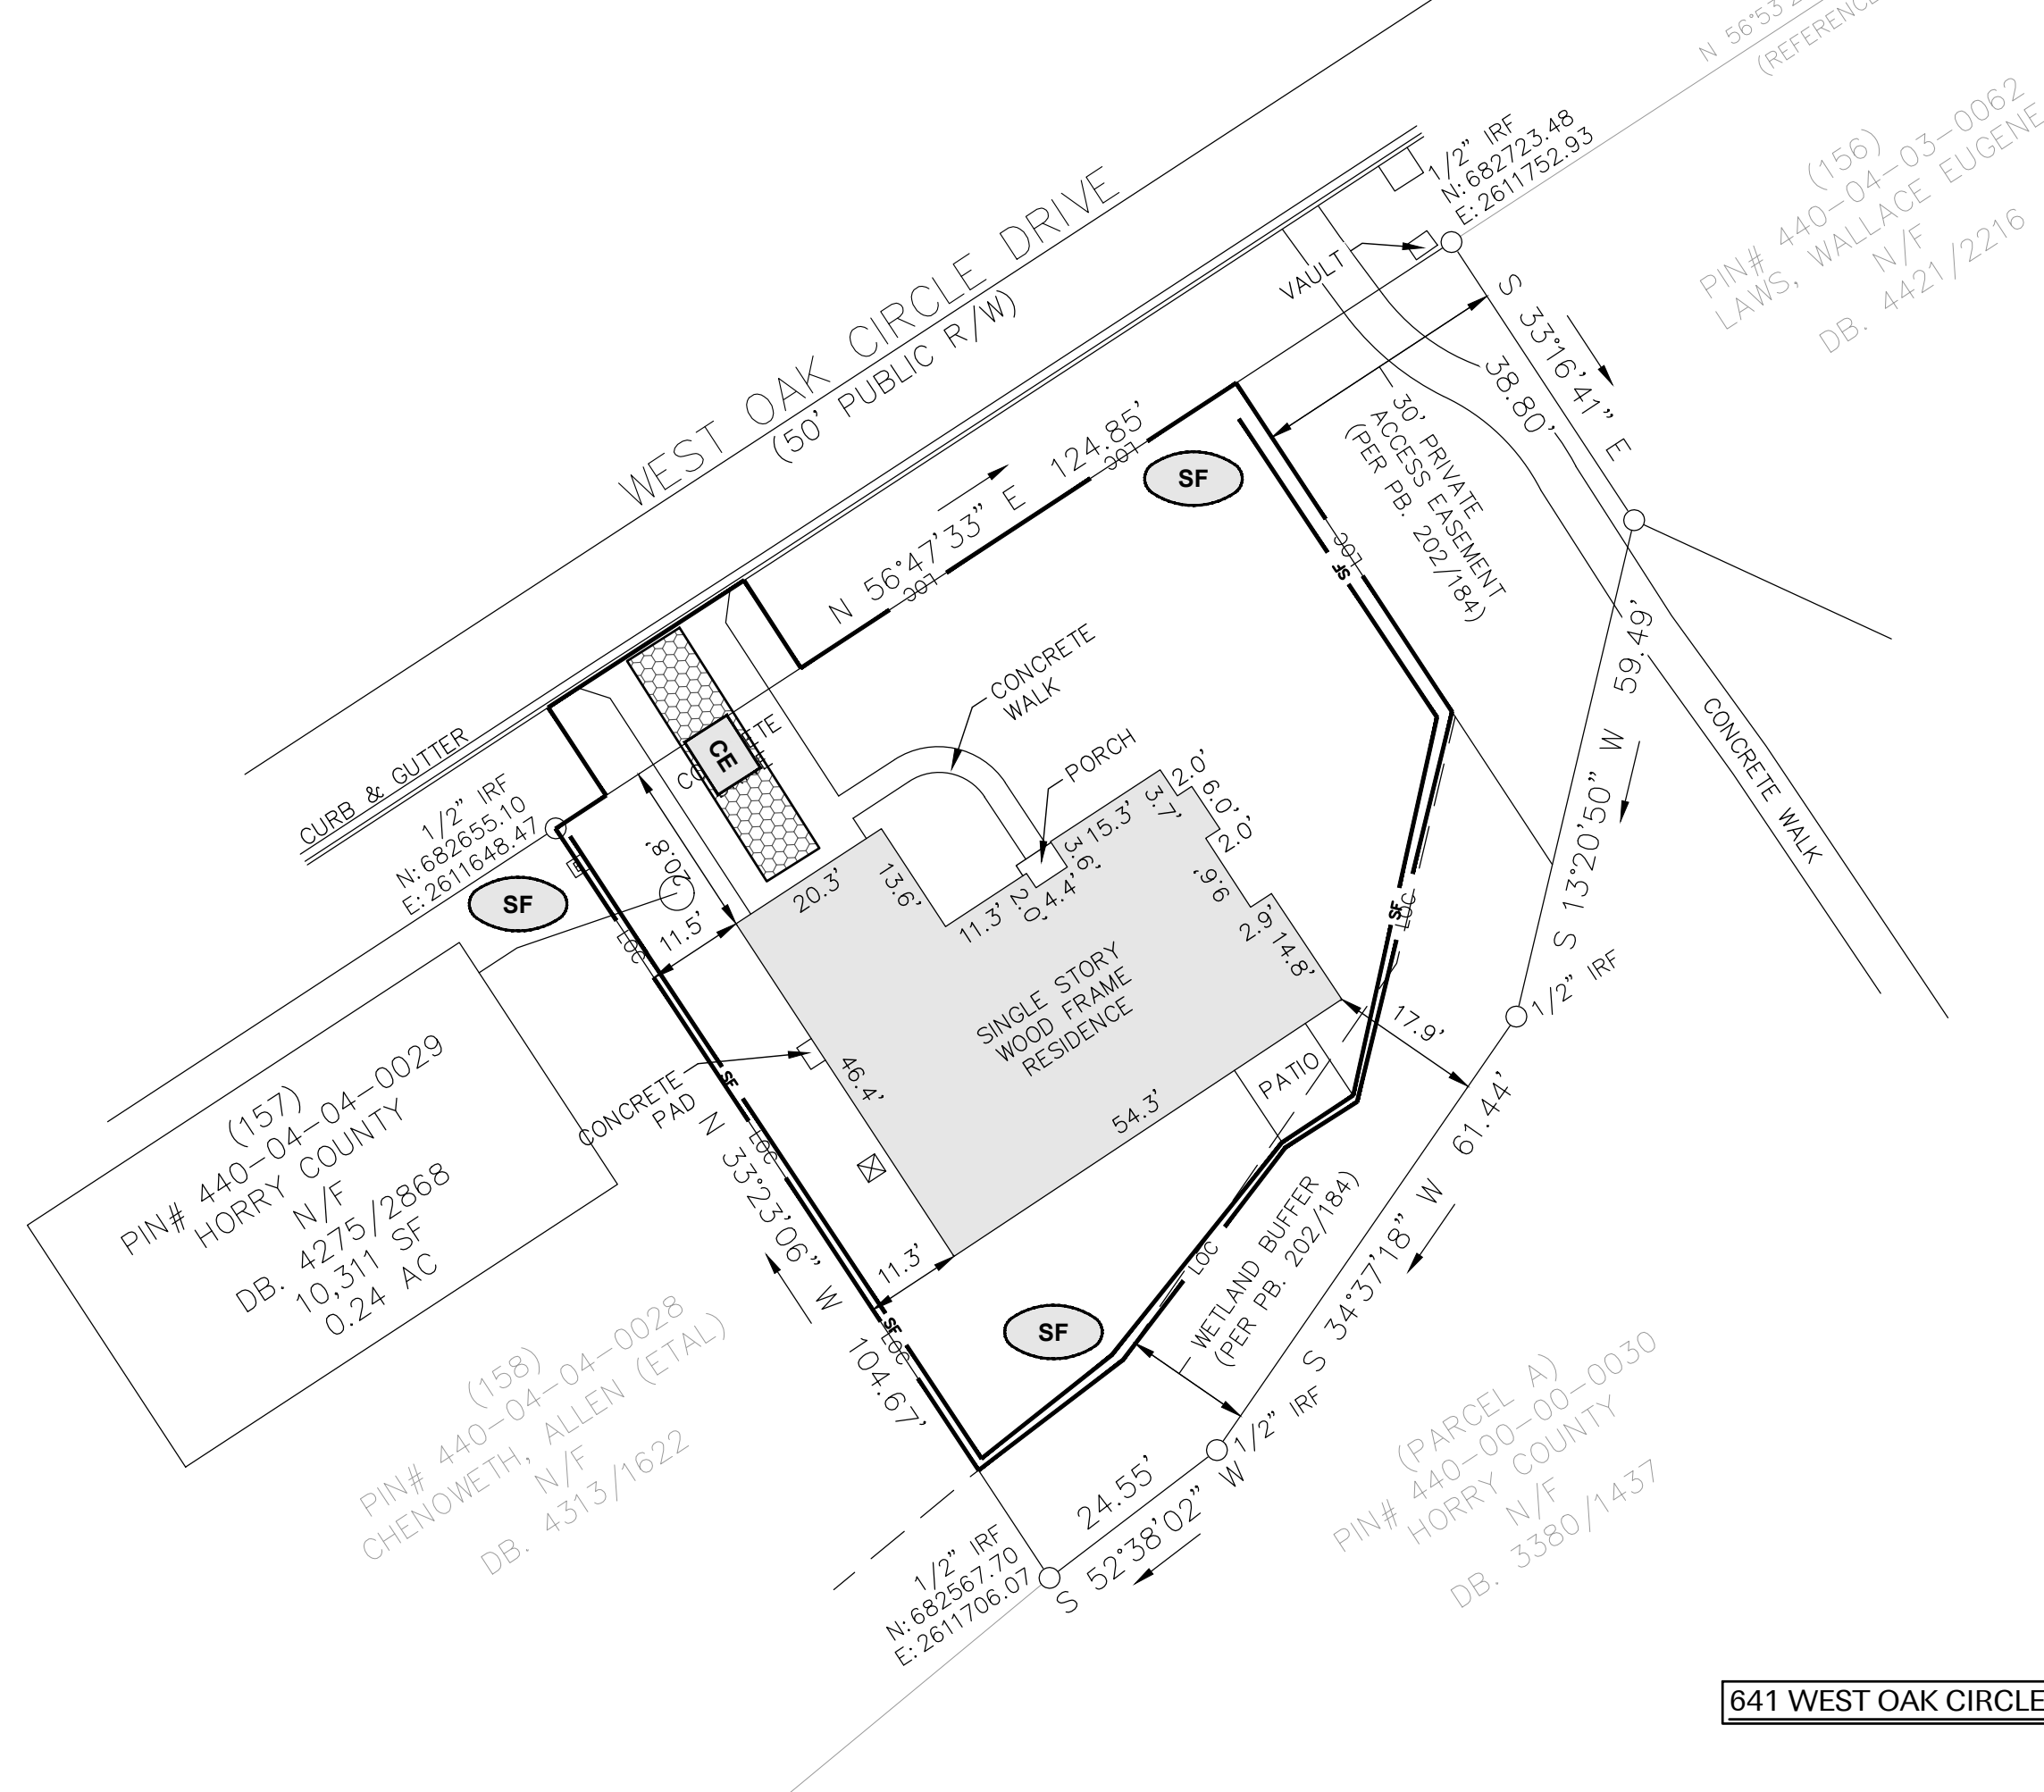

641 WEST OAK CIRCLE

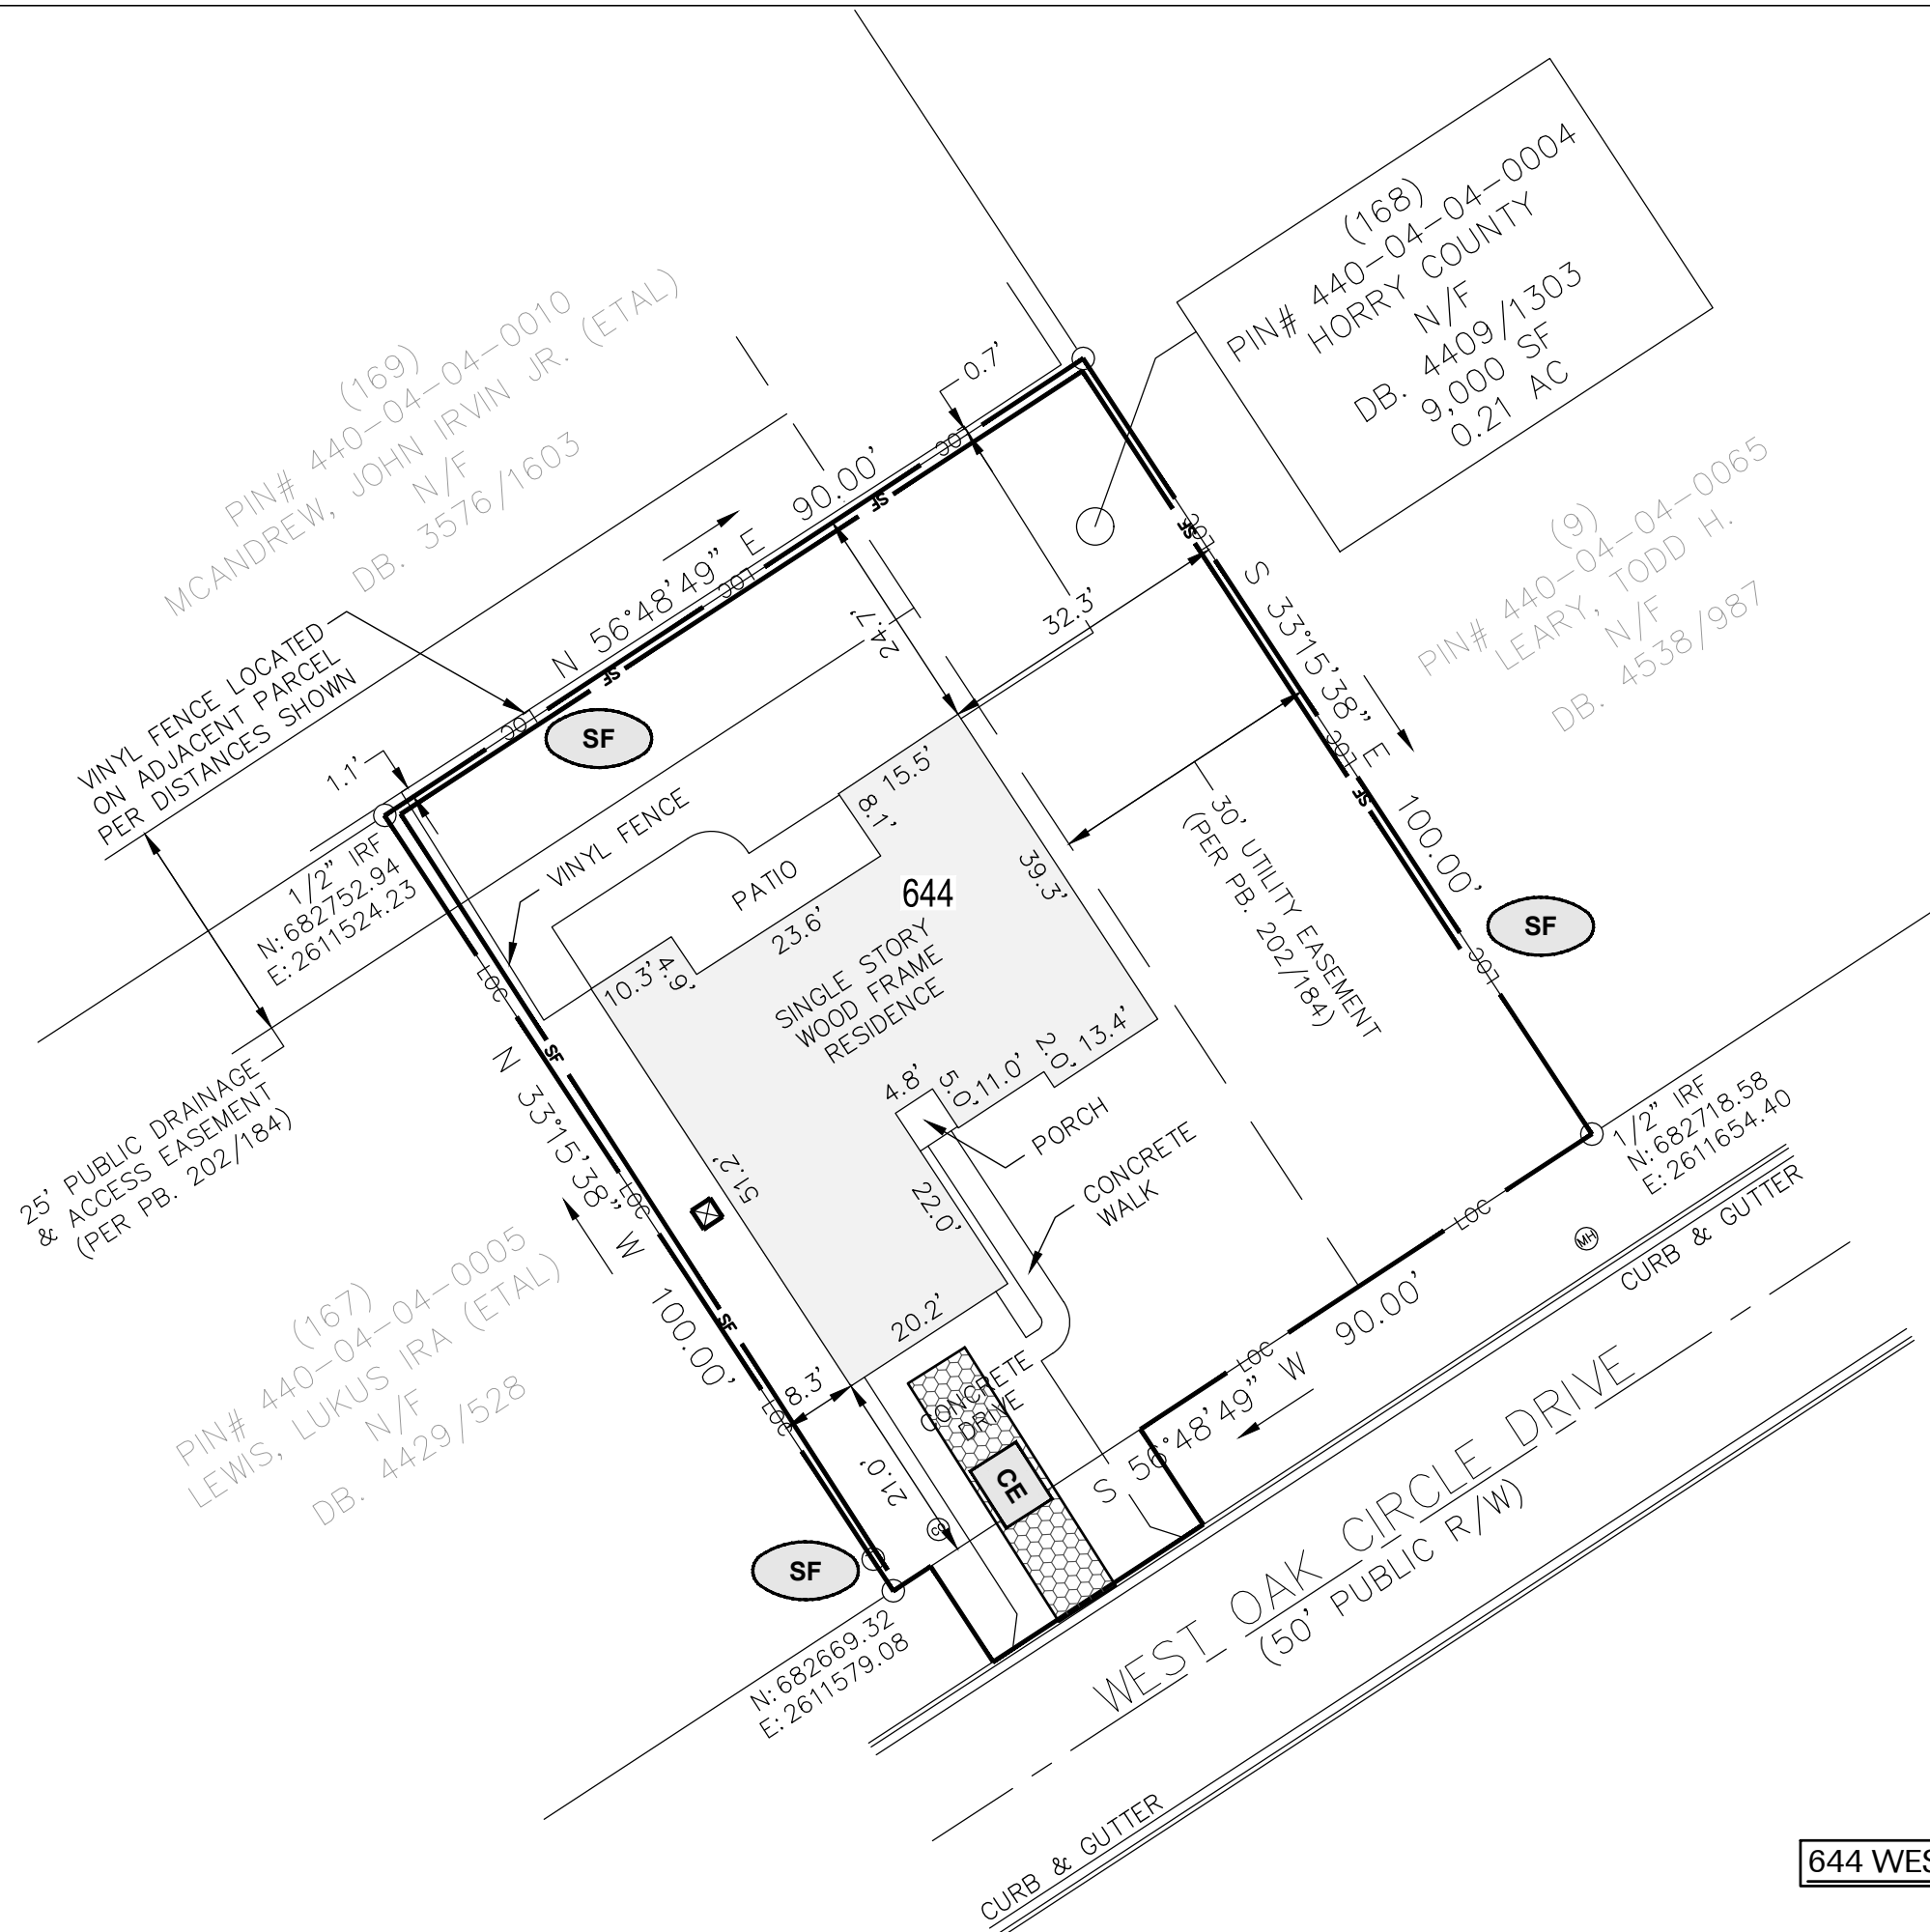


644 WEST OAK CIRCLE

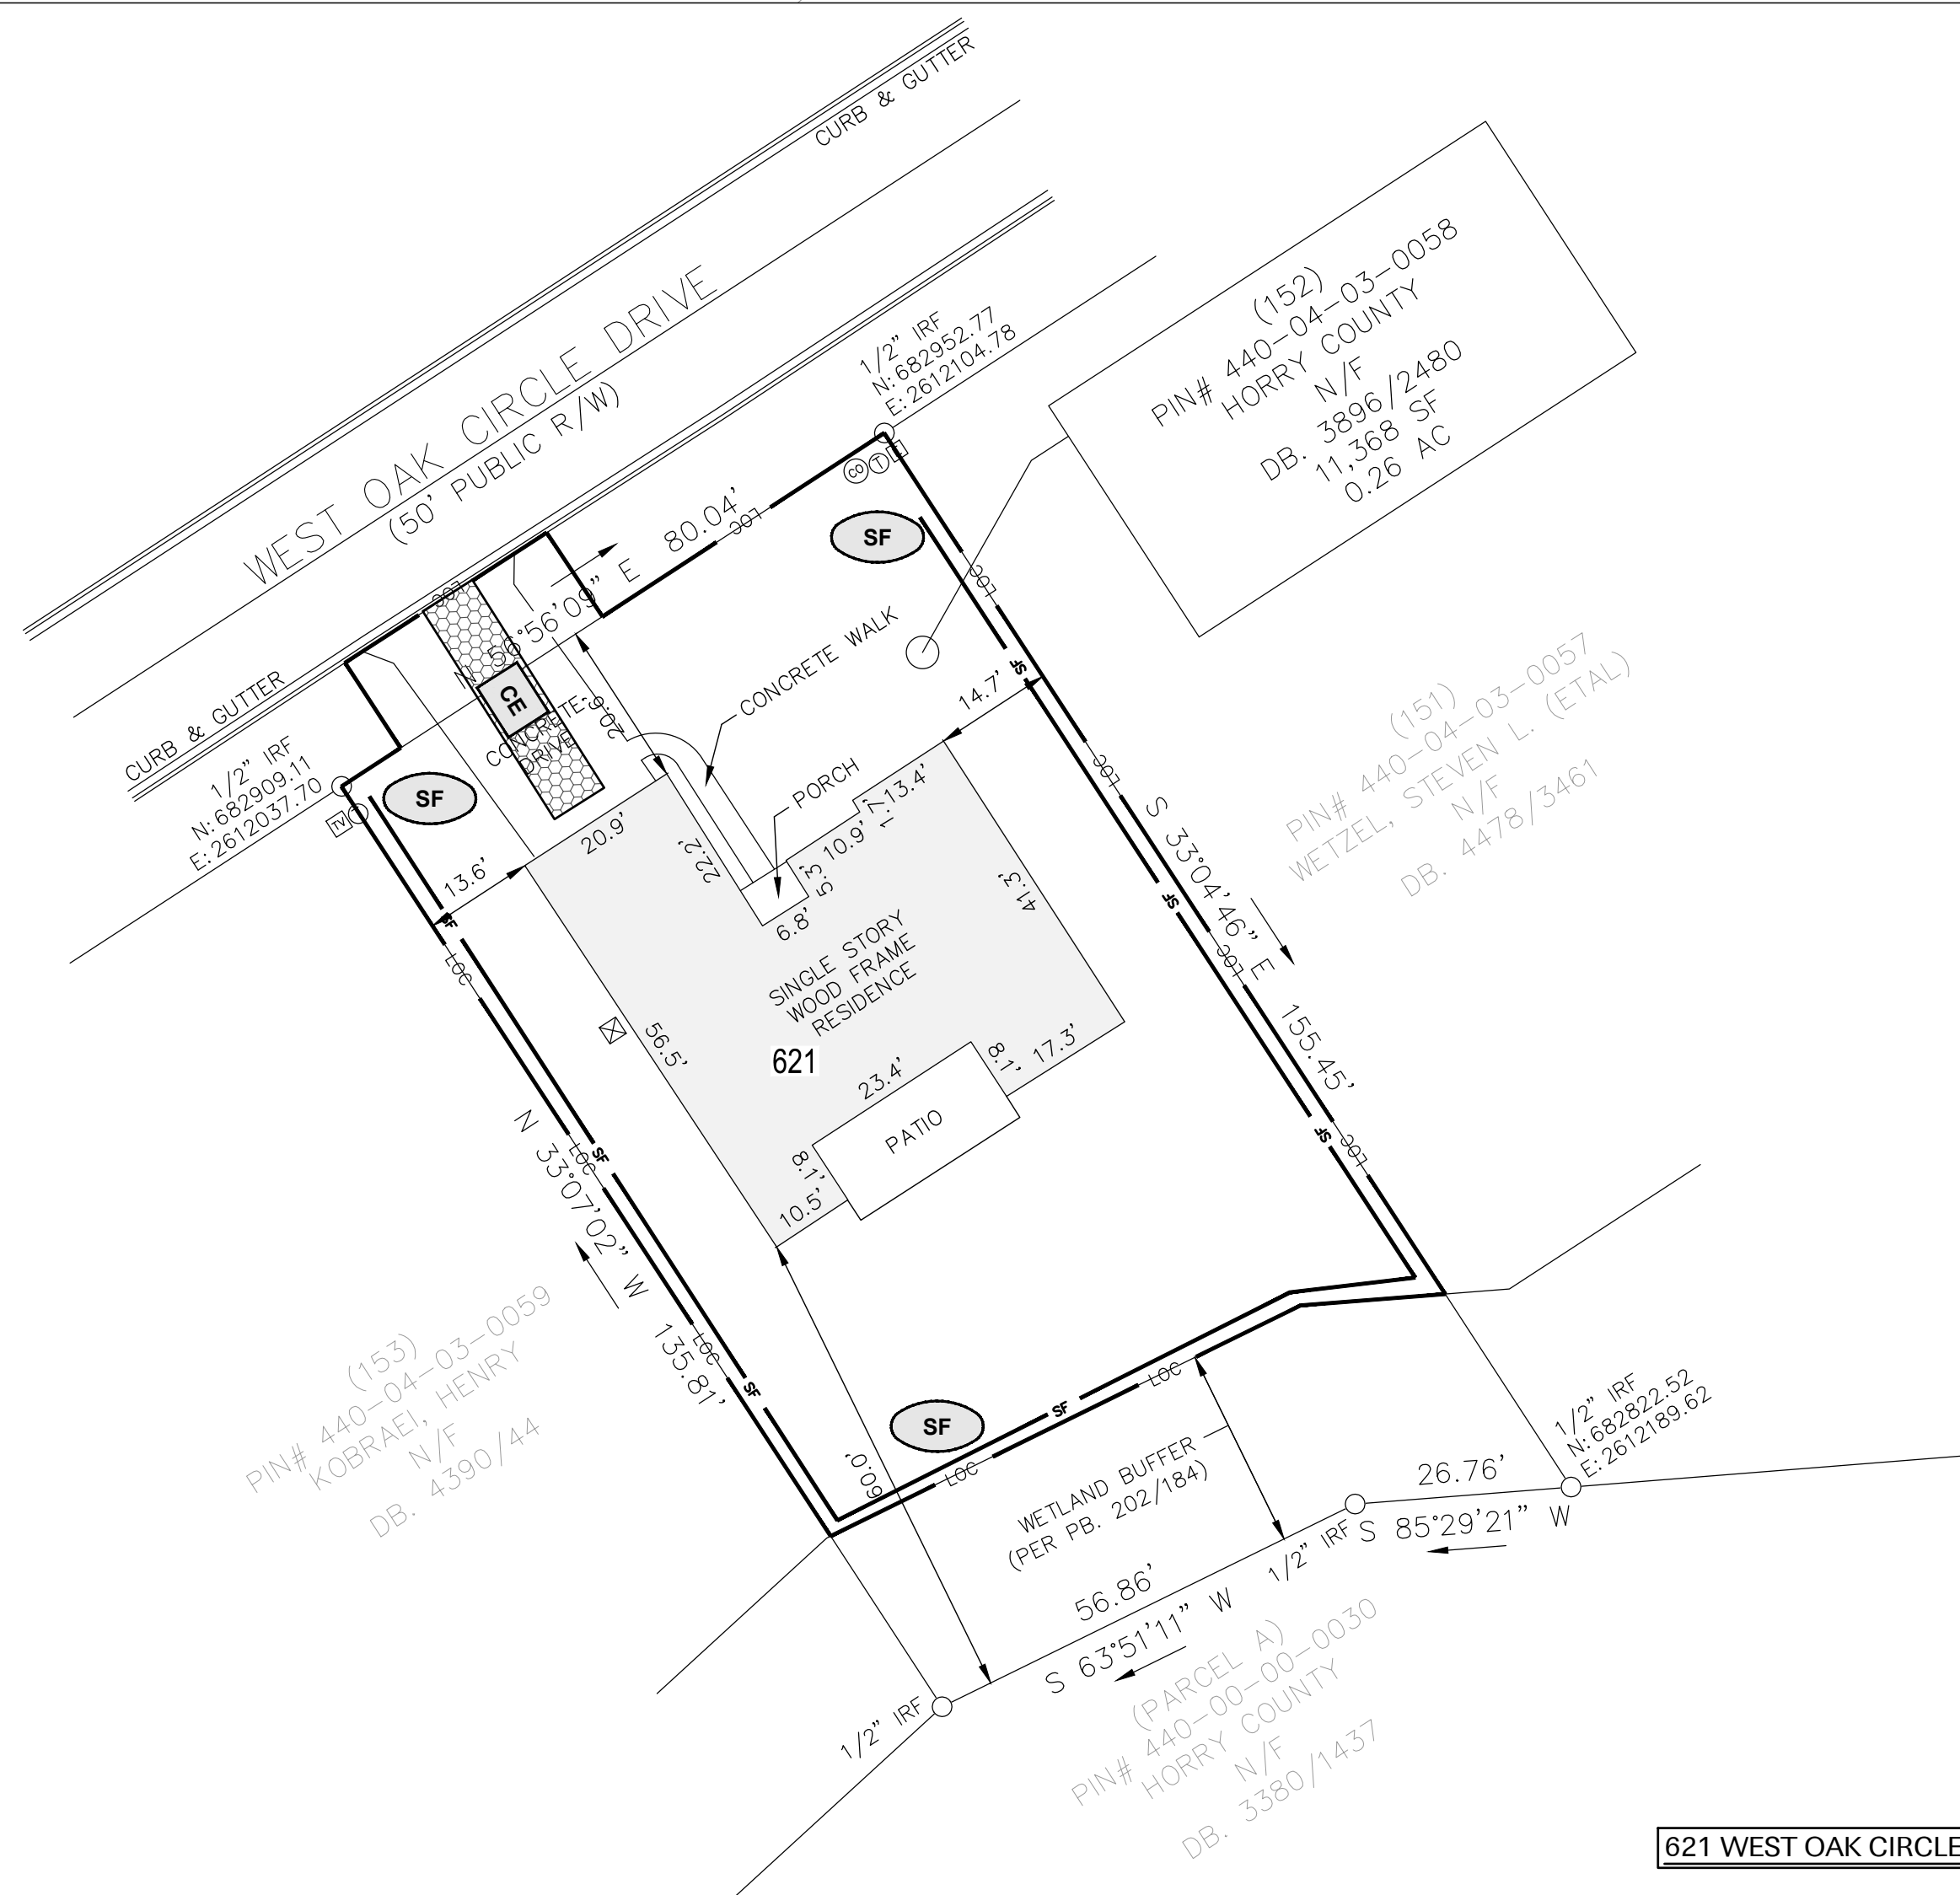

621 WEST OAK CIRCLE

LEGEND

- LOC LIMITS OF DISTURBANCE
- SF SILT FENCE
- CE TEMPORARY CONSTRUCTION ENTRANCE/EXIT
- IPa INLET PROTECTION DET. A
- IPe INLET PROTECTION DET. E
- SEDIMENT TUBES

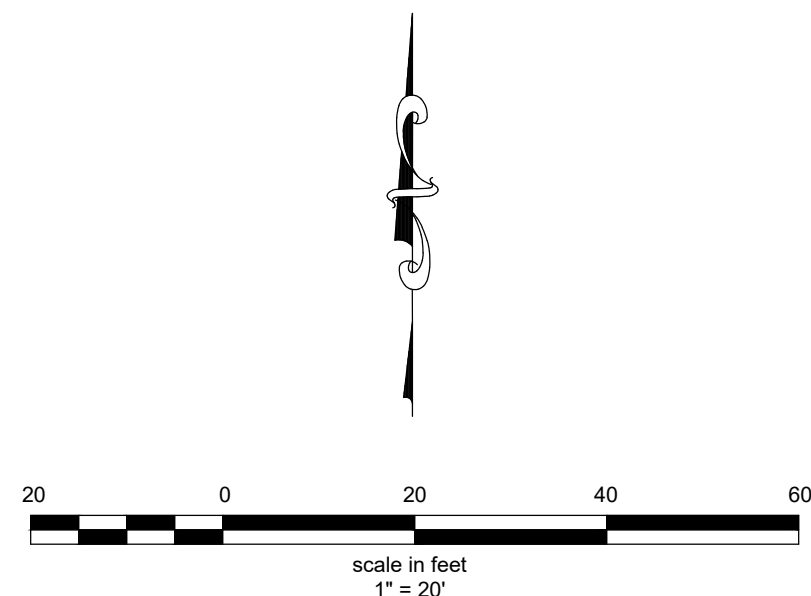

Project Title / Client Information	Revision No.	Name	Date
Drawing Title: DEMOLITION PLAN - PHASE 1	1		
	2		
	3		
	4		
Drawing No.: C2.9	Project No. 030-N027-M	Drawn By: [Signature]	Date: 09/08/23
	Checked By: [Signature]	Date: 09/08/23	Drawn By: [Signature]
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	Drawn By: [Signature]	Date: 09/08/23	Drawn By: [Signature]



CONSTRUCTION SEQUENCE

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ITEMS MUST OCCUR IN THE ORDER LISTED; ITEMS CANNOT OCCUR CONCURRENTLY UNLESS SPECIFICALLY NOTED.

CONTINUE FROM PHASE 1


1. BEGIN BUILDING DEMOLITION.
2. REMOVAL AND CAPPING OF DRIVEWAYS, FENCING, UTILITIES, AND OTHER ITEMS OF DEMOLITION AS INDICATED ON THE PLANS.
3. GRADING OF THE SITE IN THE AREAS OF PAVEMENT REMOVAL AND HOUSE DEMOLITION.
4. PERMANENT/ FINAL STABILIZATION (IN 0.8 AC. INCREMENTS).
5. REMOVAL OF TEMPORARY SEDIMENT & EROSION CONTROL MEASURES AFTER 0.8 AC. SET OF SITES AREA IS FINALLY STABILIZED (WILL REQUIRE APPROVAL FROM HORRY COUNTY, SCOR, OCRM/SCDHEC PRIOR TO REMOVAL). SITE MUST BE 80% STABILIZED BEFORE BMP REMOVAL.
6. SUBMIT NOTICE OF TERMINATION (NOT) TO THE COUNTY AND OCRM/SCDHEC ONCE ALL 33 LOTS ARE COMPLETED AND STABILIZED.

DISTURBED AREA IS 8.5 AC TOTAL, NO MORE THAN 0.8 AC DISTURBED AT ONE TIME DURING DEMOLITION.



PROJECT START DATE 01/01/2024, PROJECT TERMINATION DATE 05/01/2024.

LEGEND

HOUSES TO BE DEMOLISHED

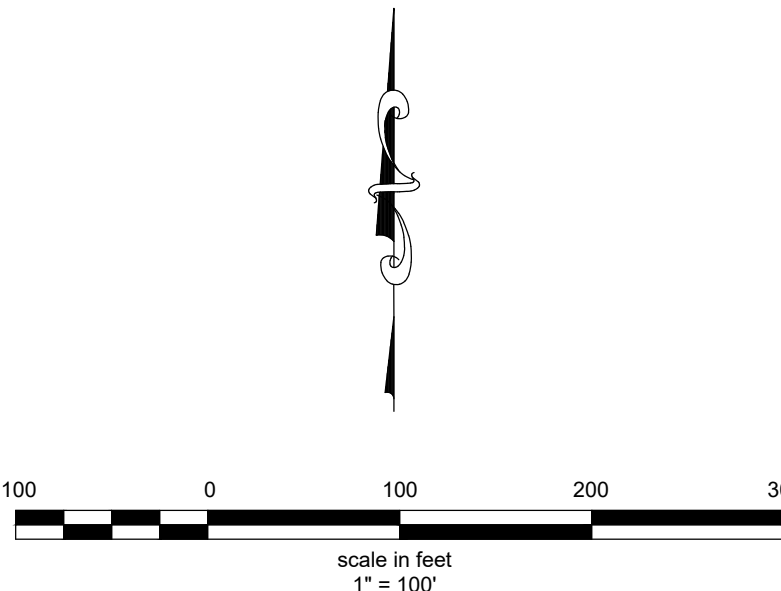

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ENGINEERING
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Columbia, SC 29201
Phone: (803) 400-6031
www.elrobinsonengineering.com

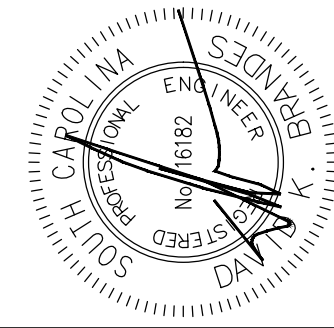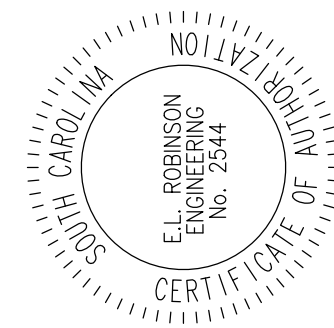

**HORRY COUNTY BUYOUT
DEMOLITION**

SOUTH CAROLINA OFFICE OF RESILIENCE
HORRY COUNTY, SOUTH CAROLINA





Project Title / Client Information

Drawing Information	Revisions
Project No. C30-N027-M	No. Name Date
Drawn by	
Date	
Checked by	
DWG	
Date	
Approved by	
DWG	

**OVERALL
DEMOLITION
LAYOUT
PHASE 2**

Drawing No.

C3.0

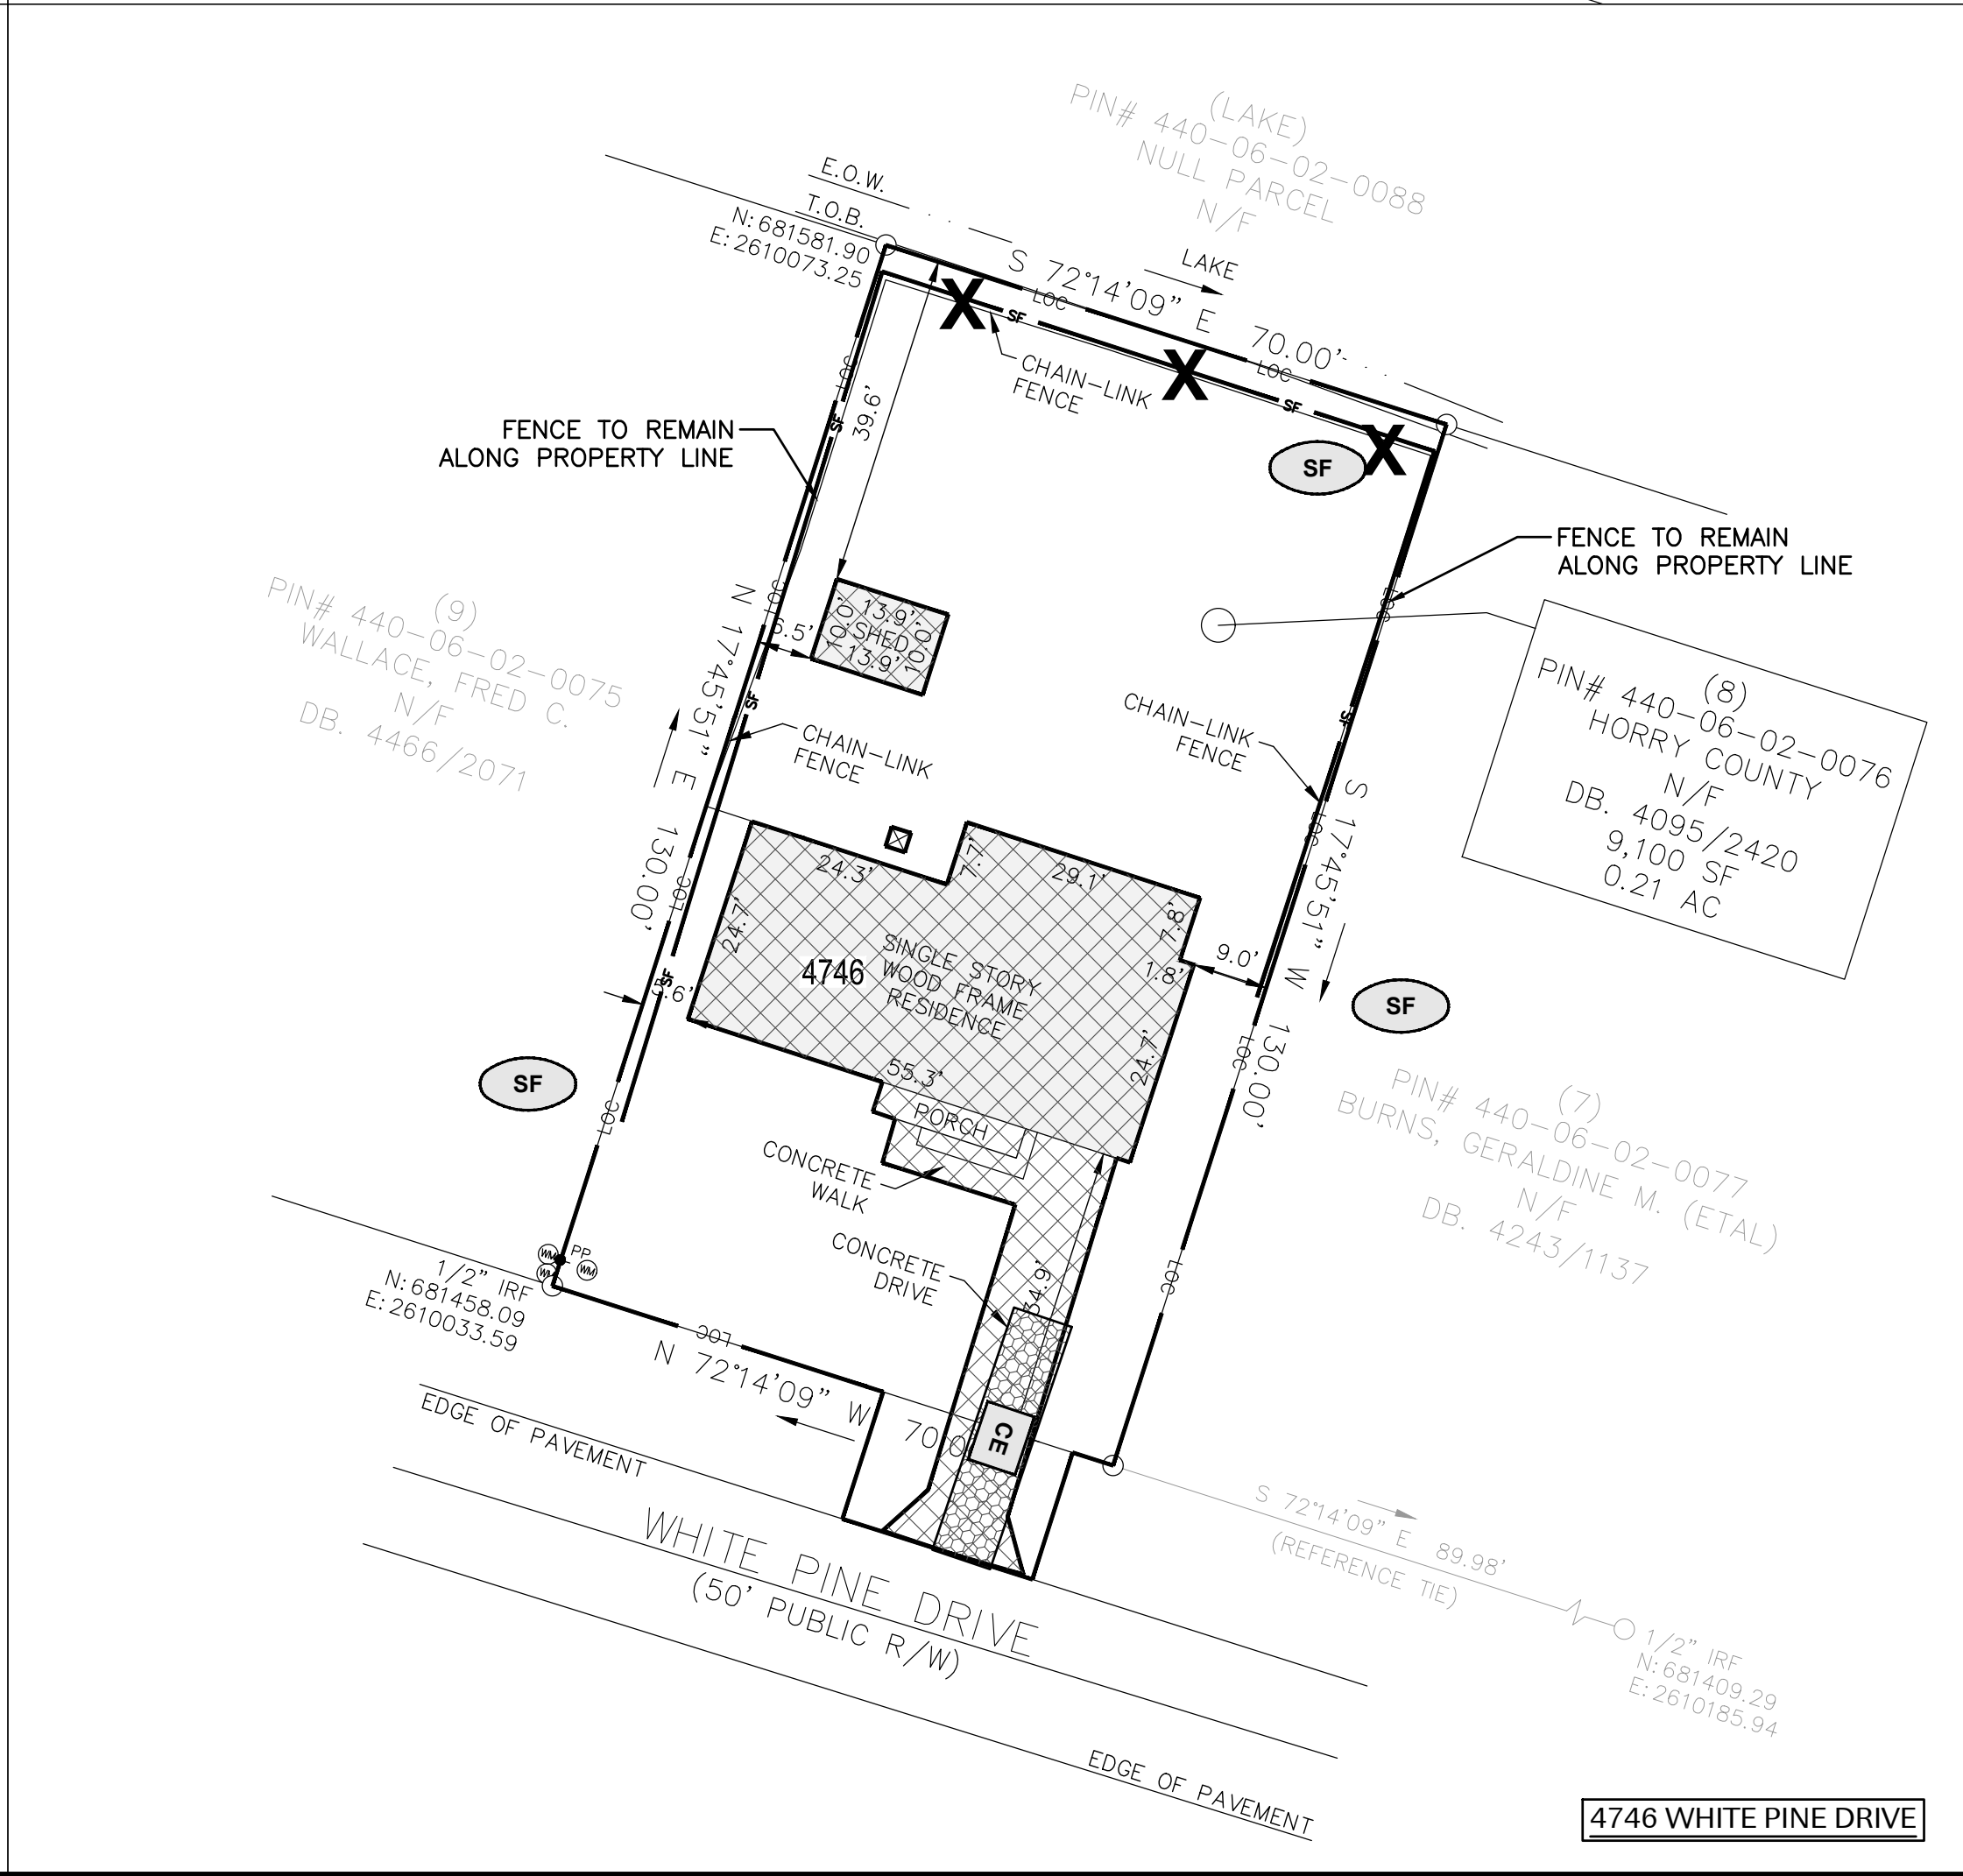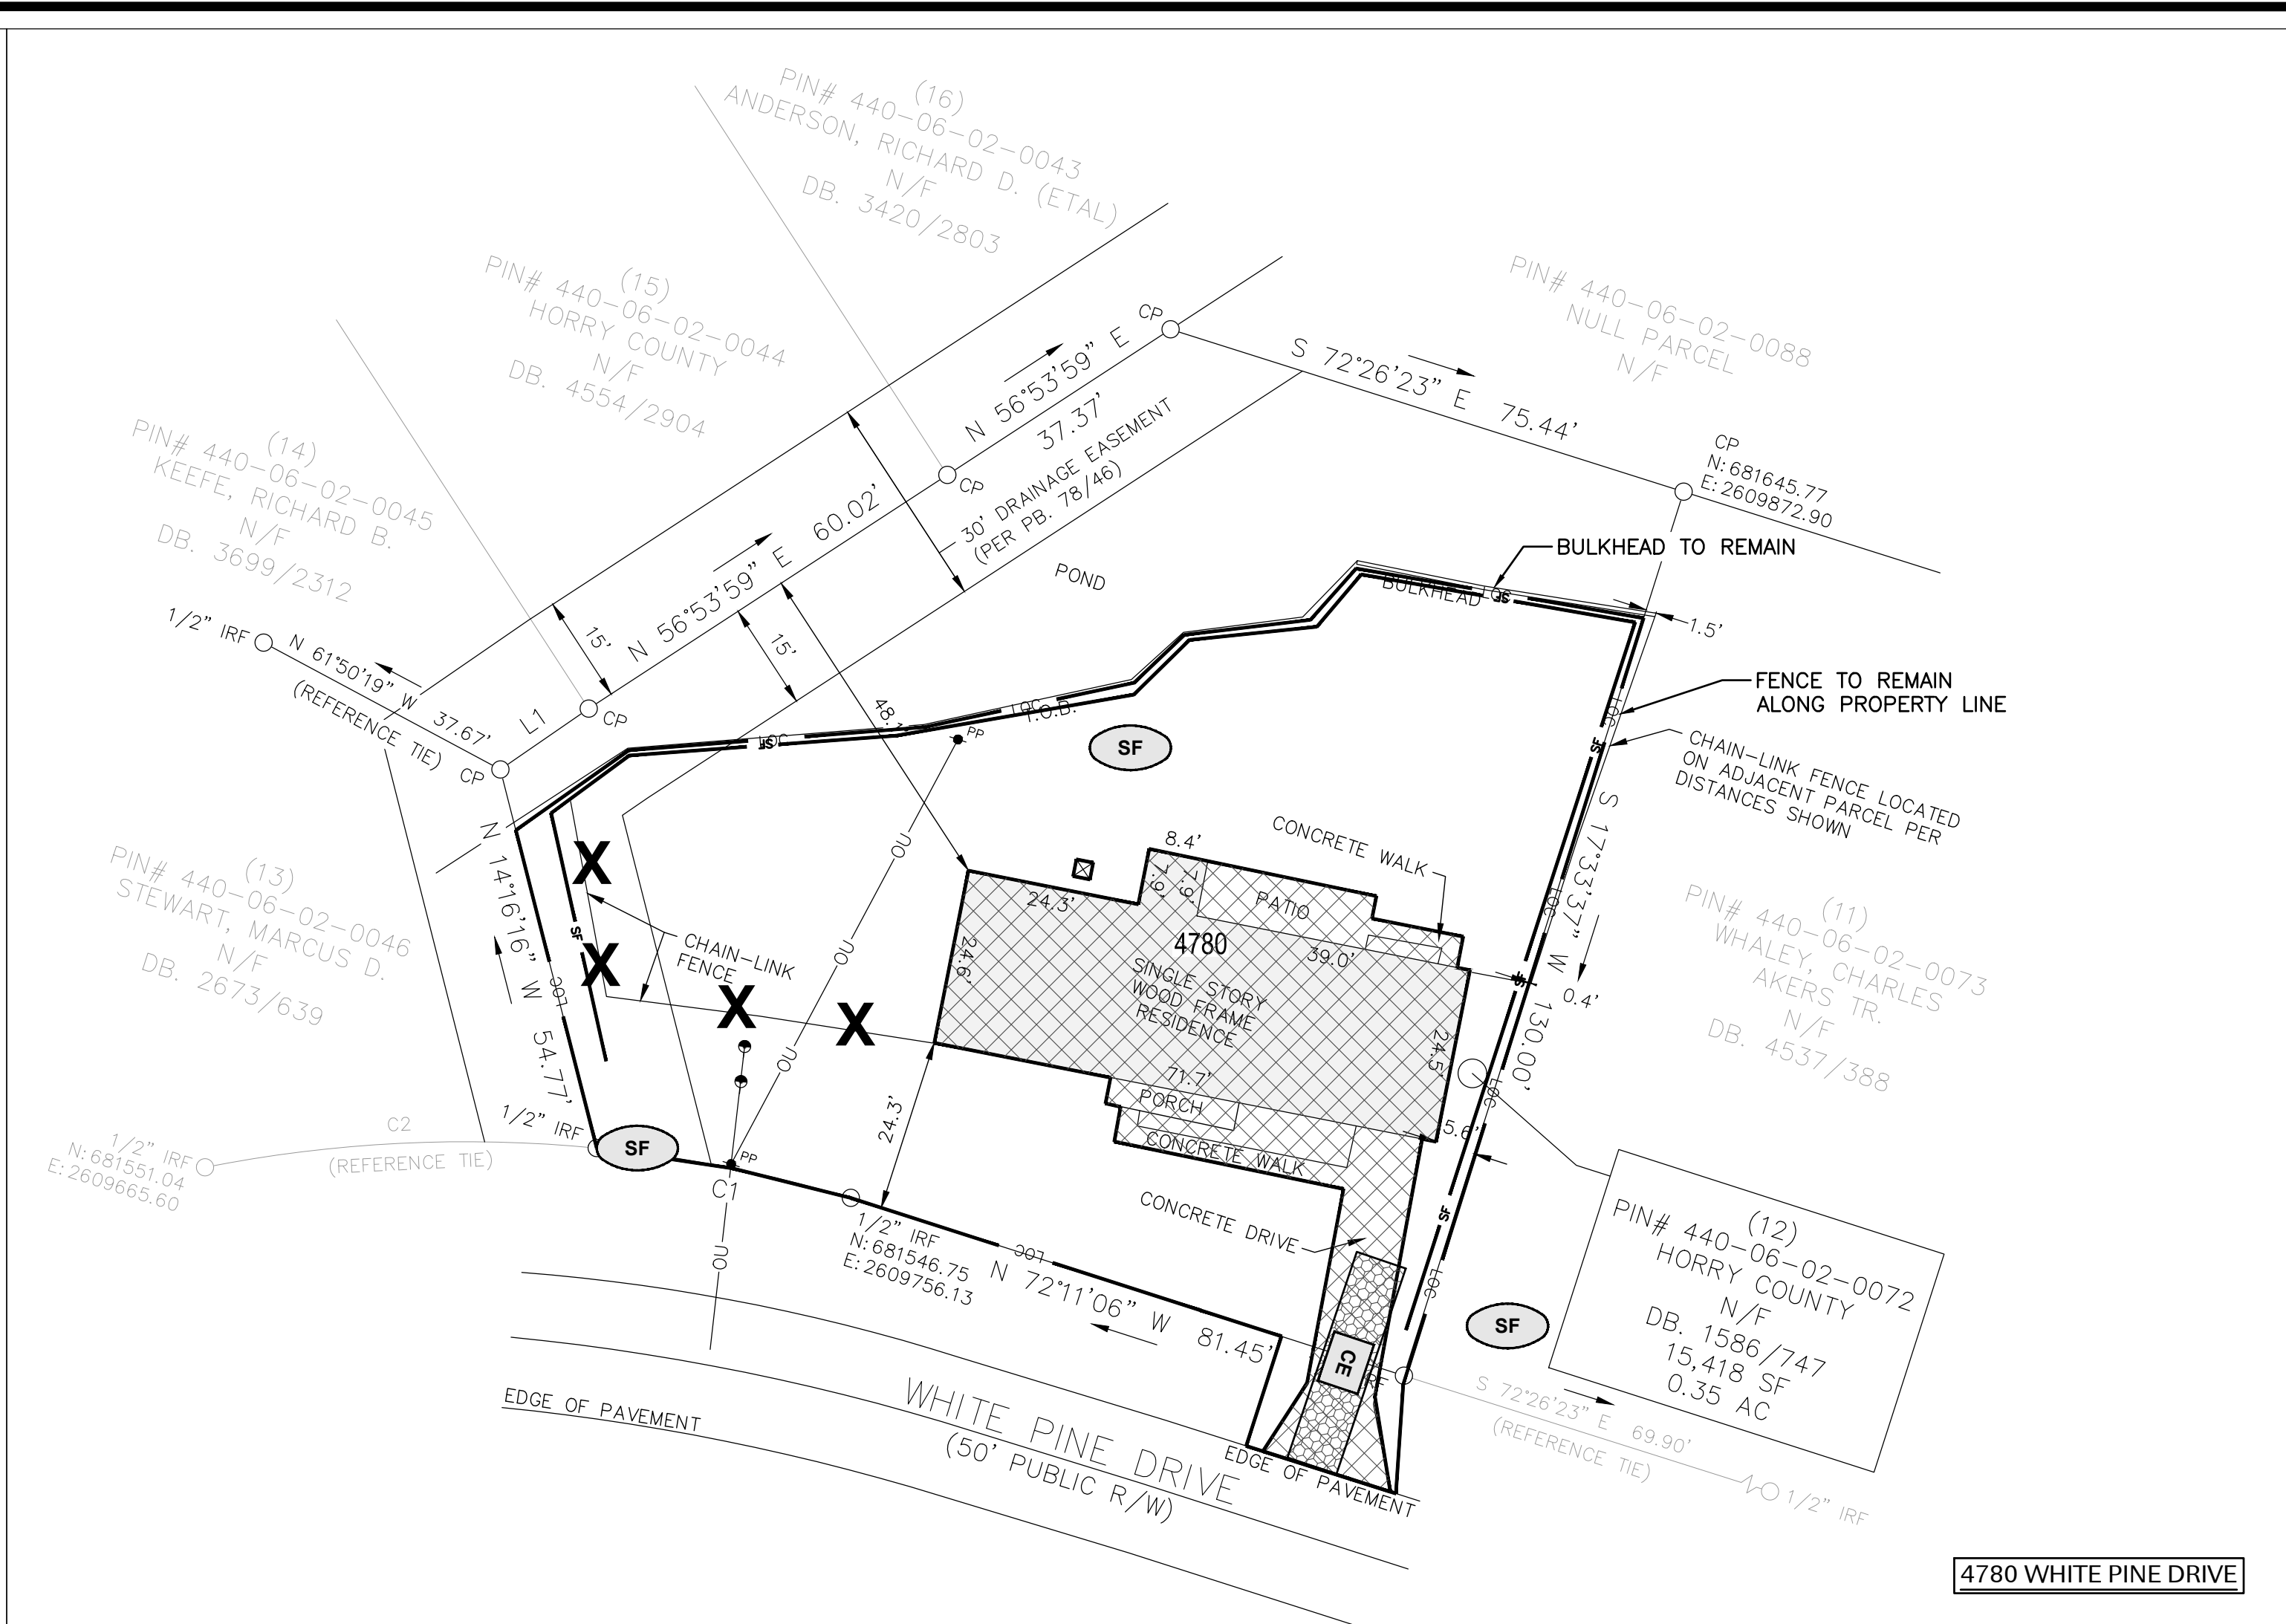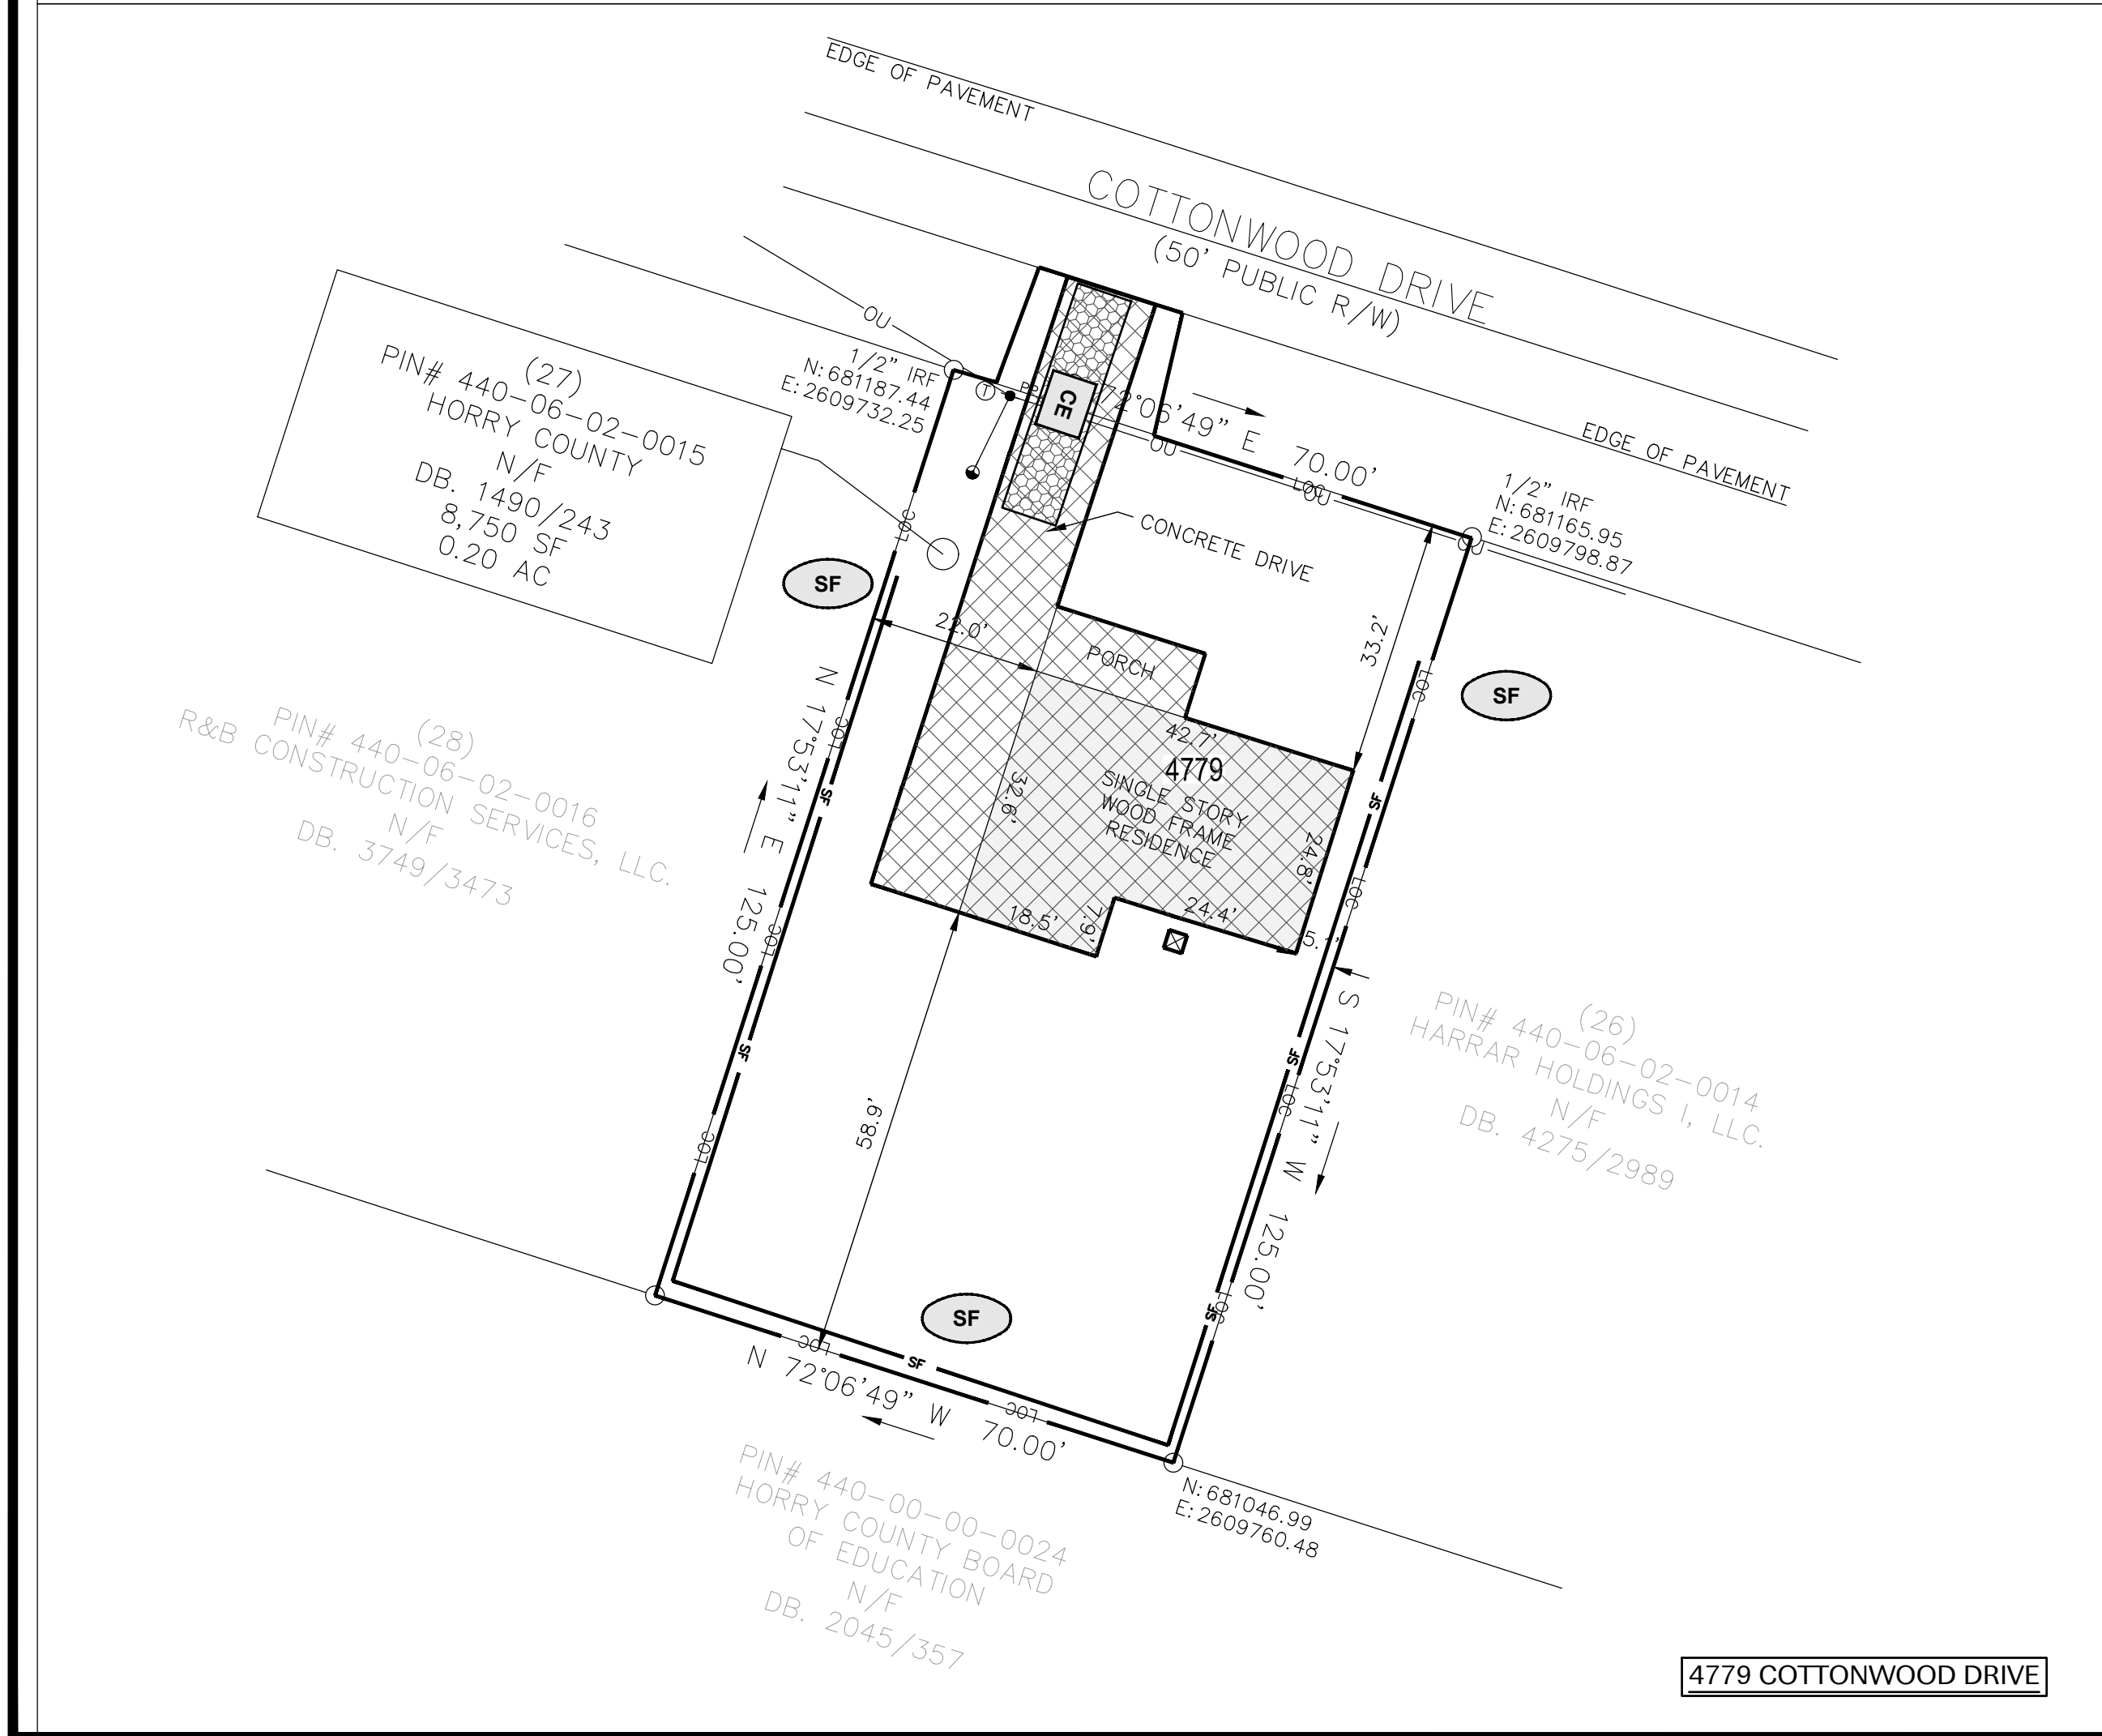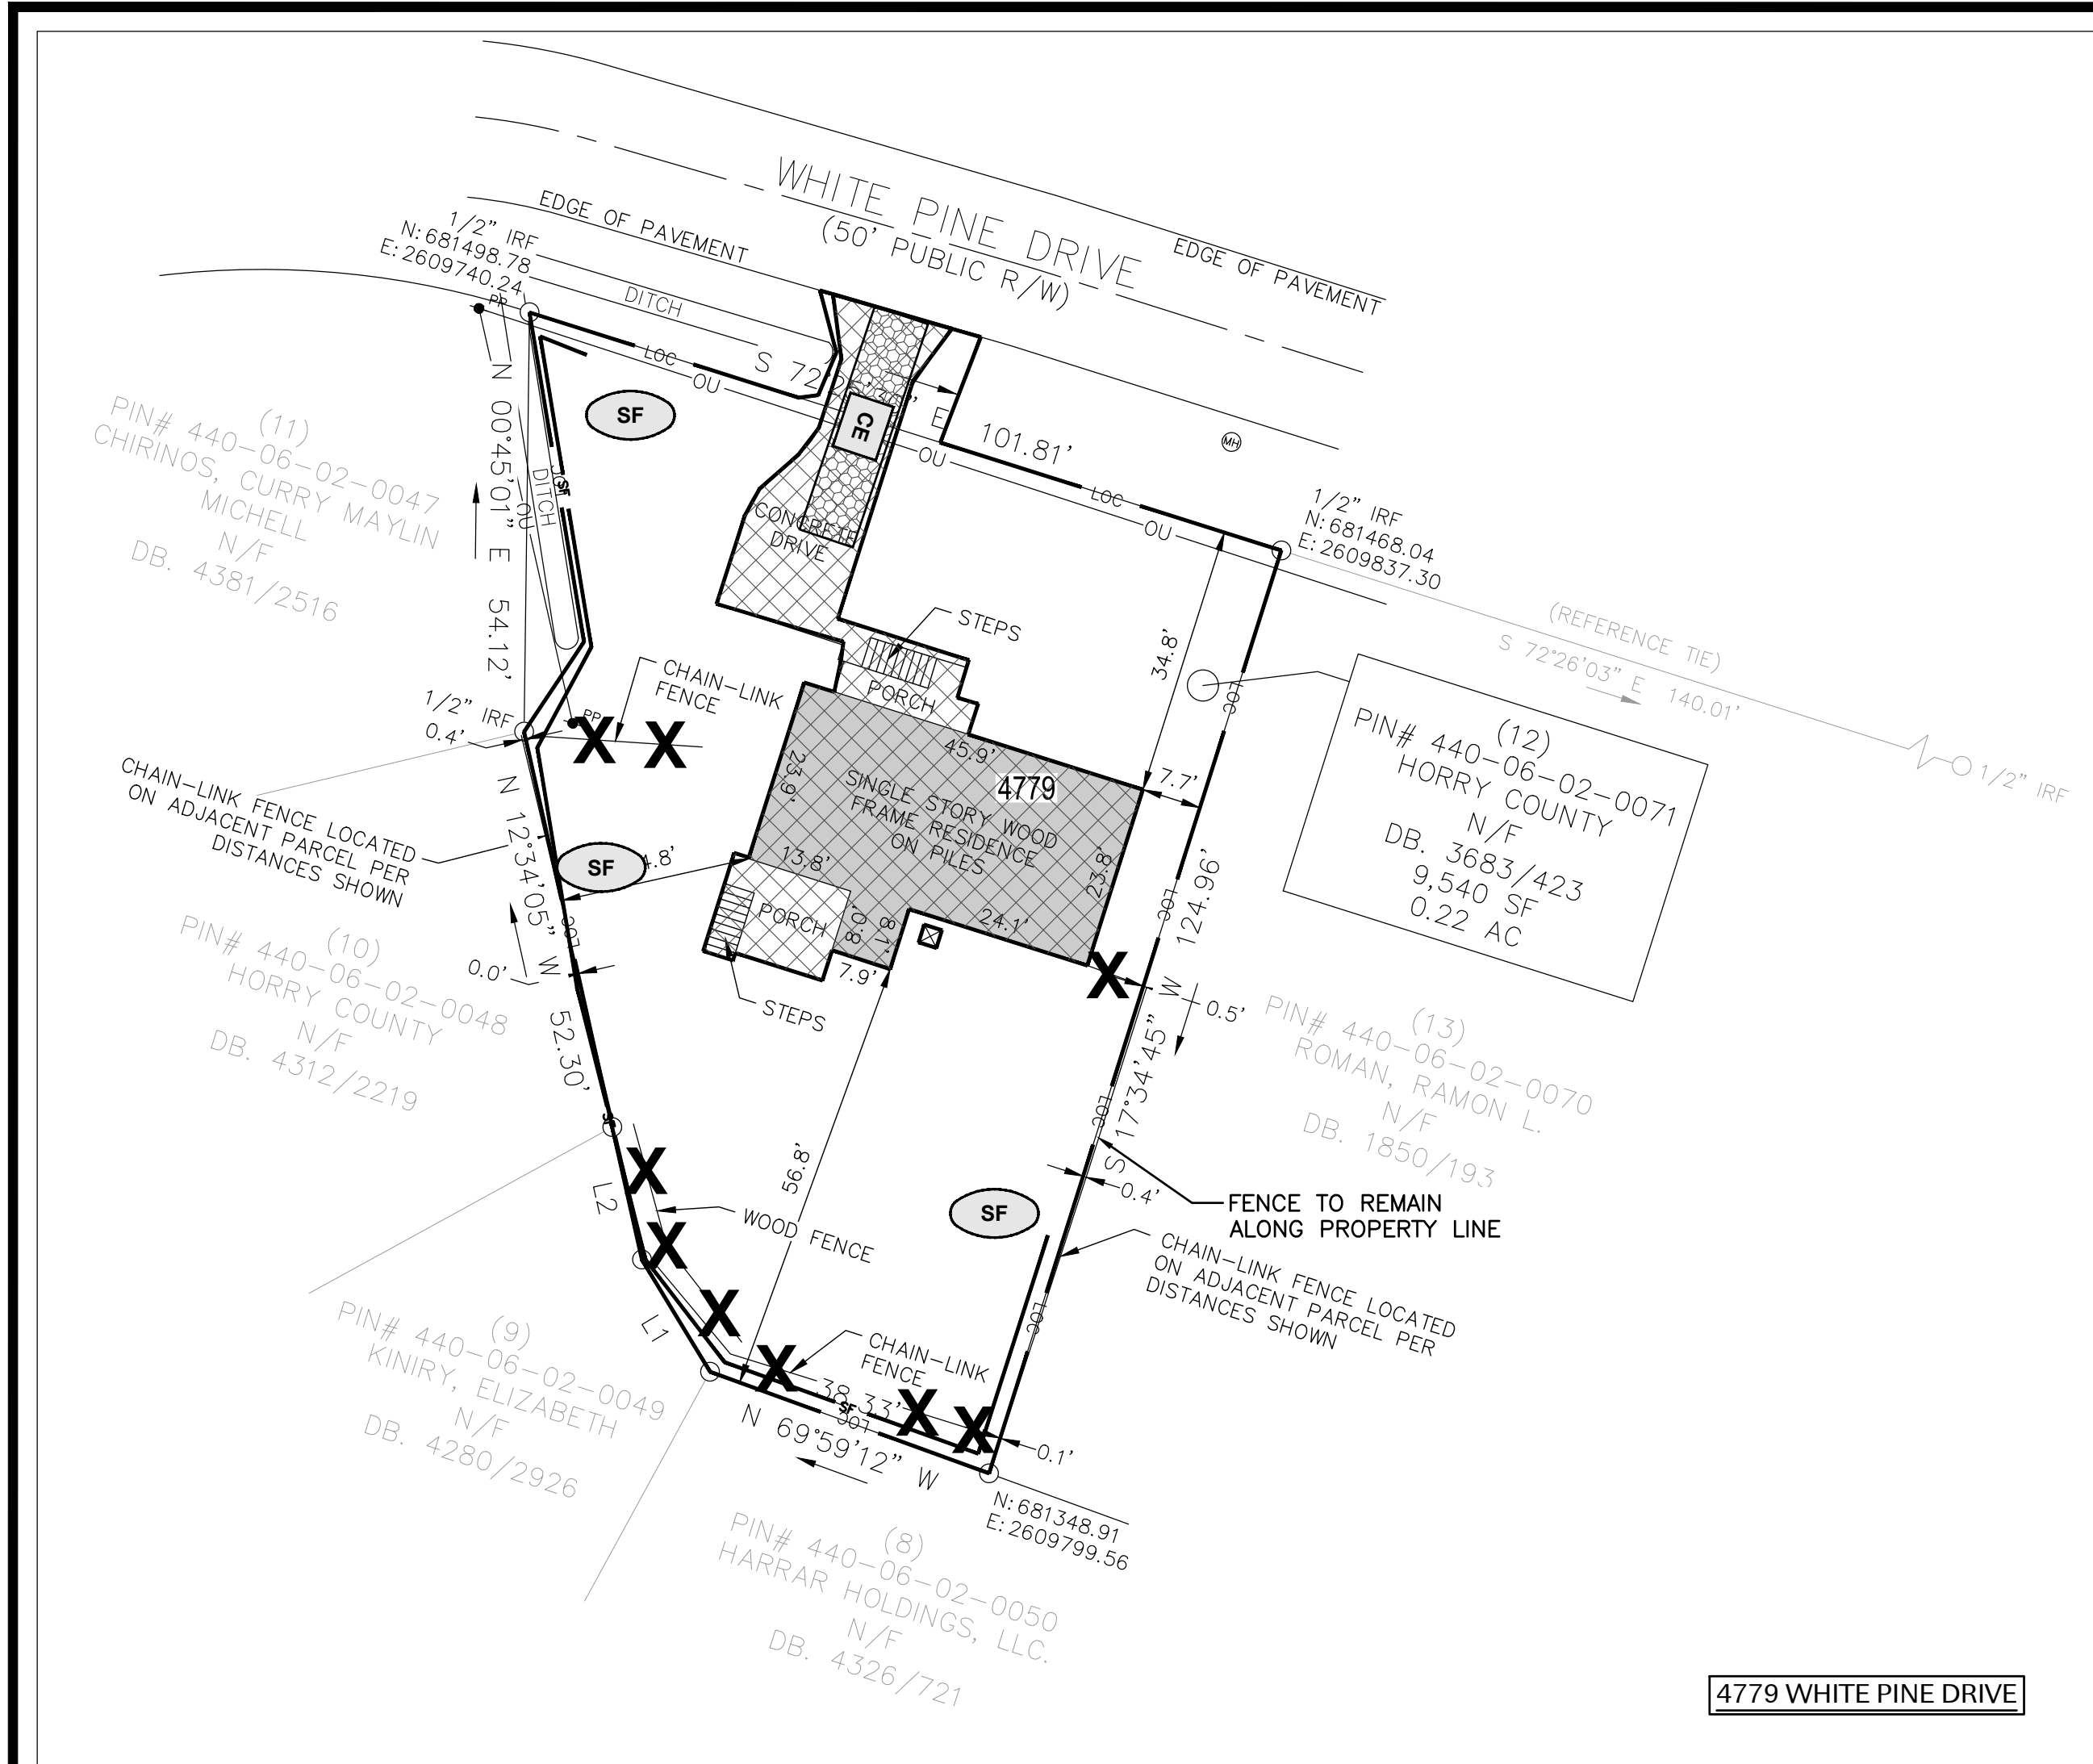

LEGEND

- LOC LIMITS OF DISTURBANCE
- SF SILT FENCE
- CE TEMPORARY CONSTRUCTION ENTRANCE/EXIT
- IPa INLET PROTECTION DET. A
- IPe INLET PROTECTION DET. E
- SEDIMENT TUBES
- X ITEMS TO BE DEMOLISHED
- GENERAL DEMOLITION AREA


E.L. ROBINSON ENGINEERING
1301 Cervais St., Suite 450
Columbia, SC 29201
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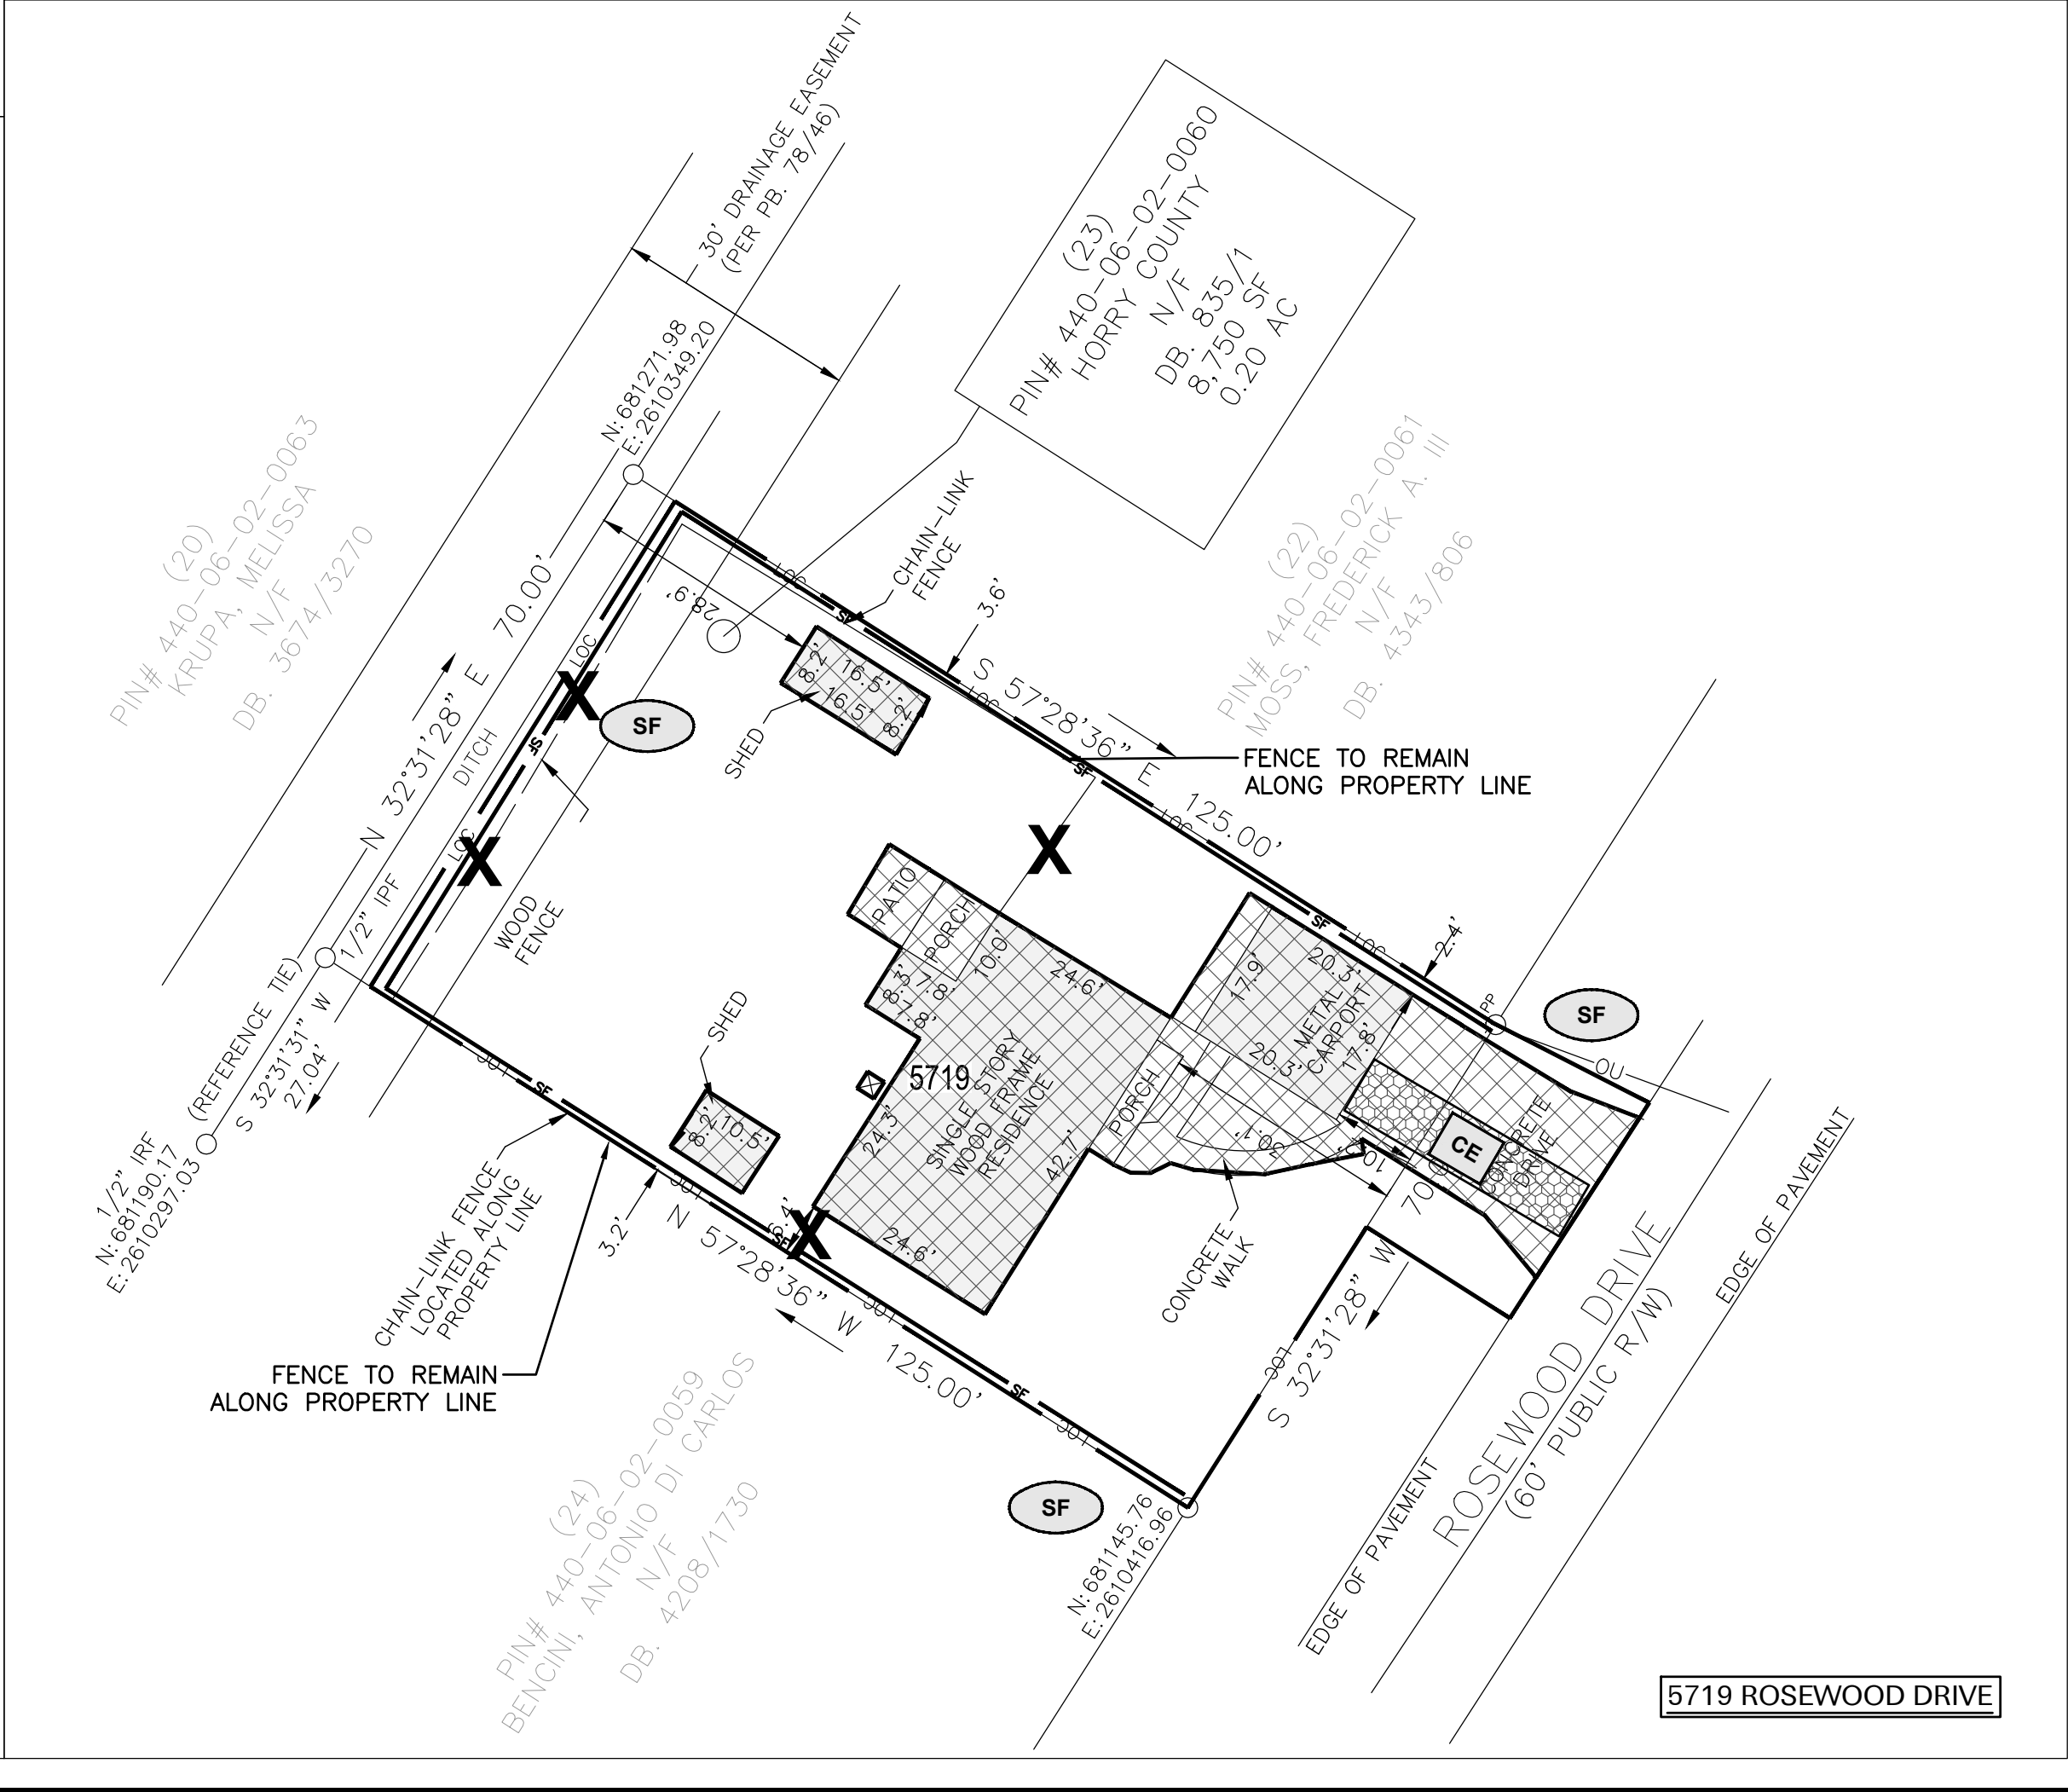
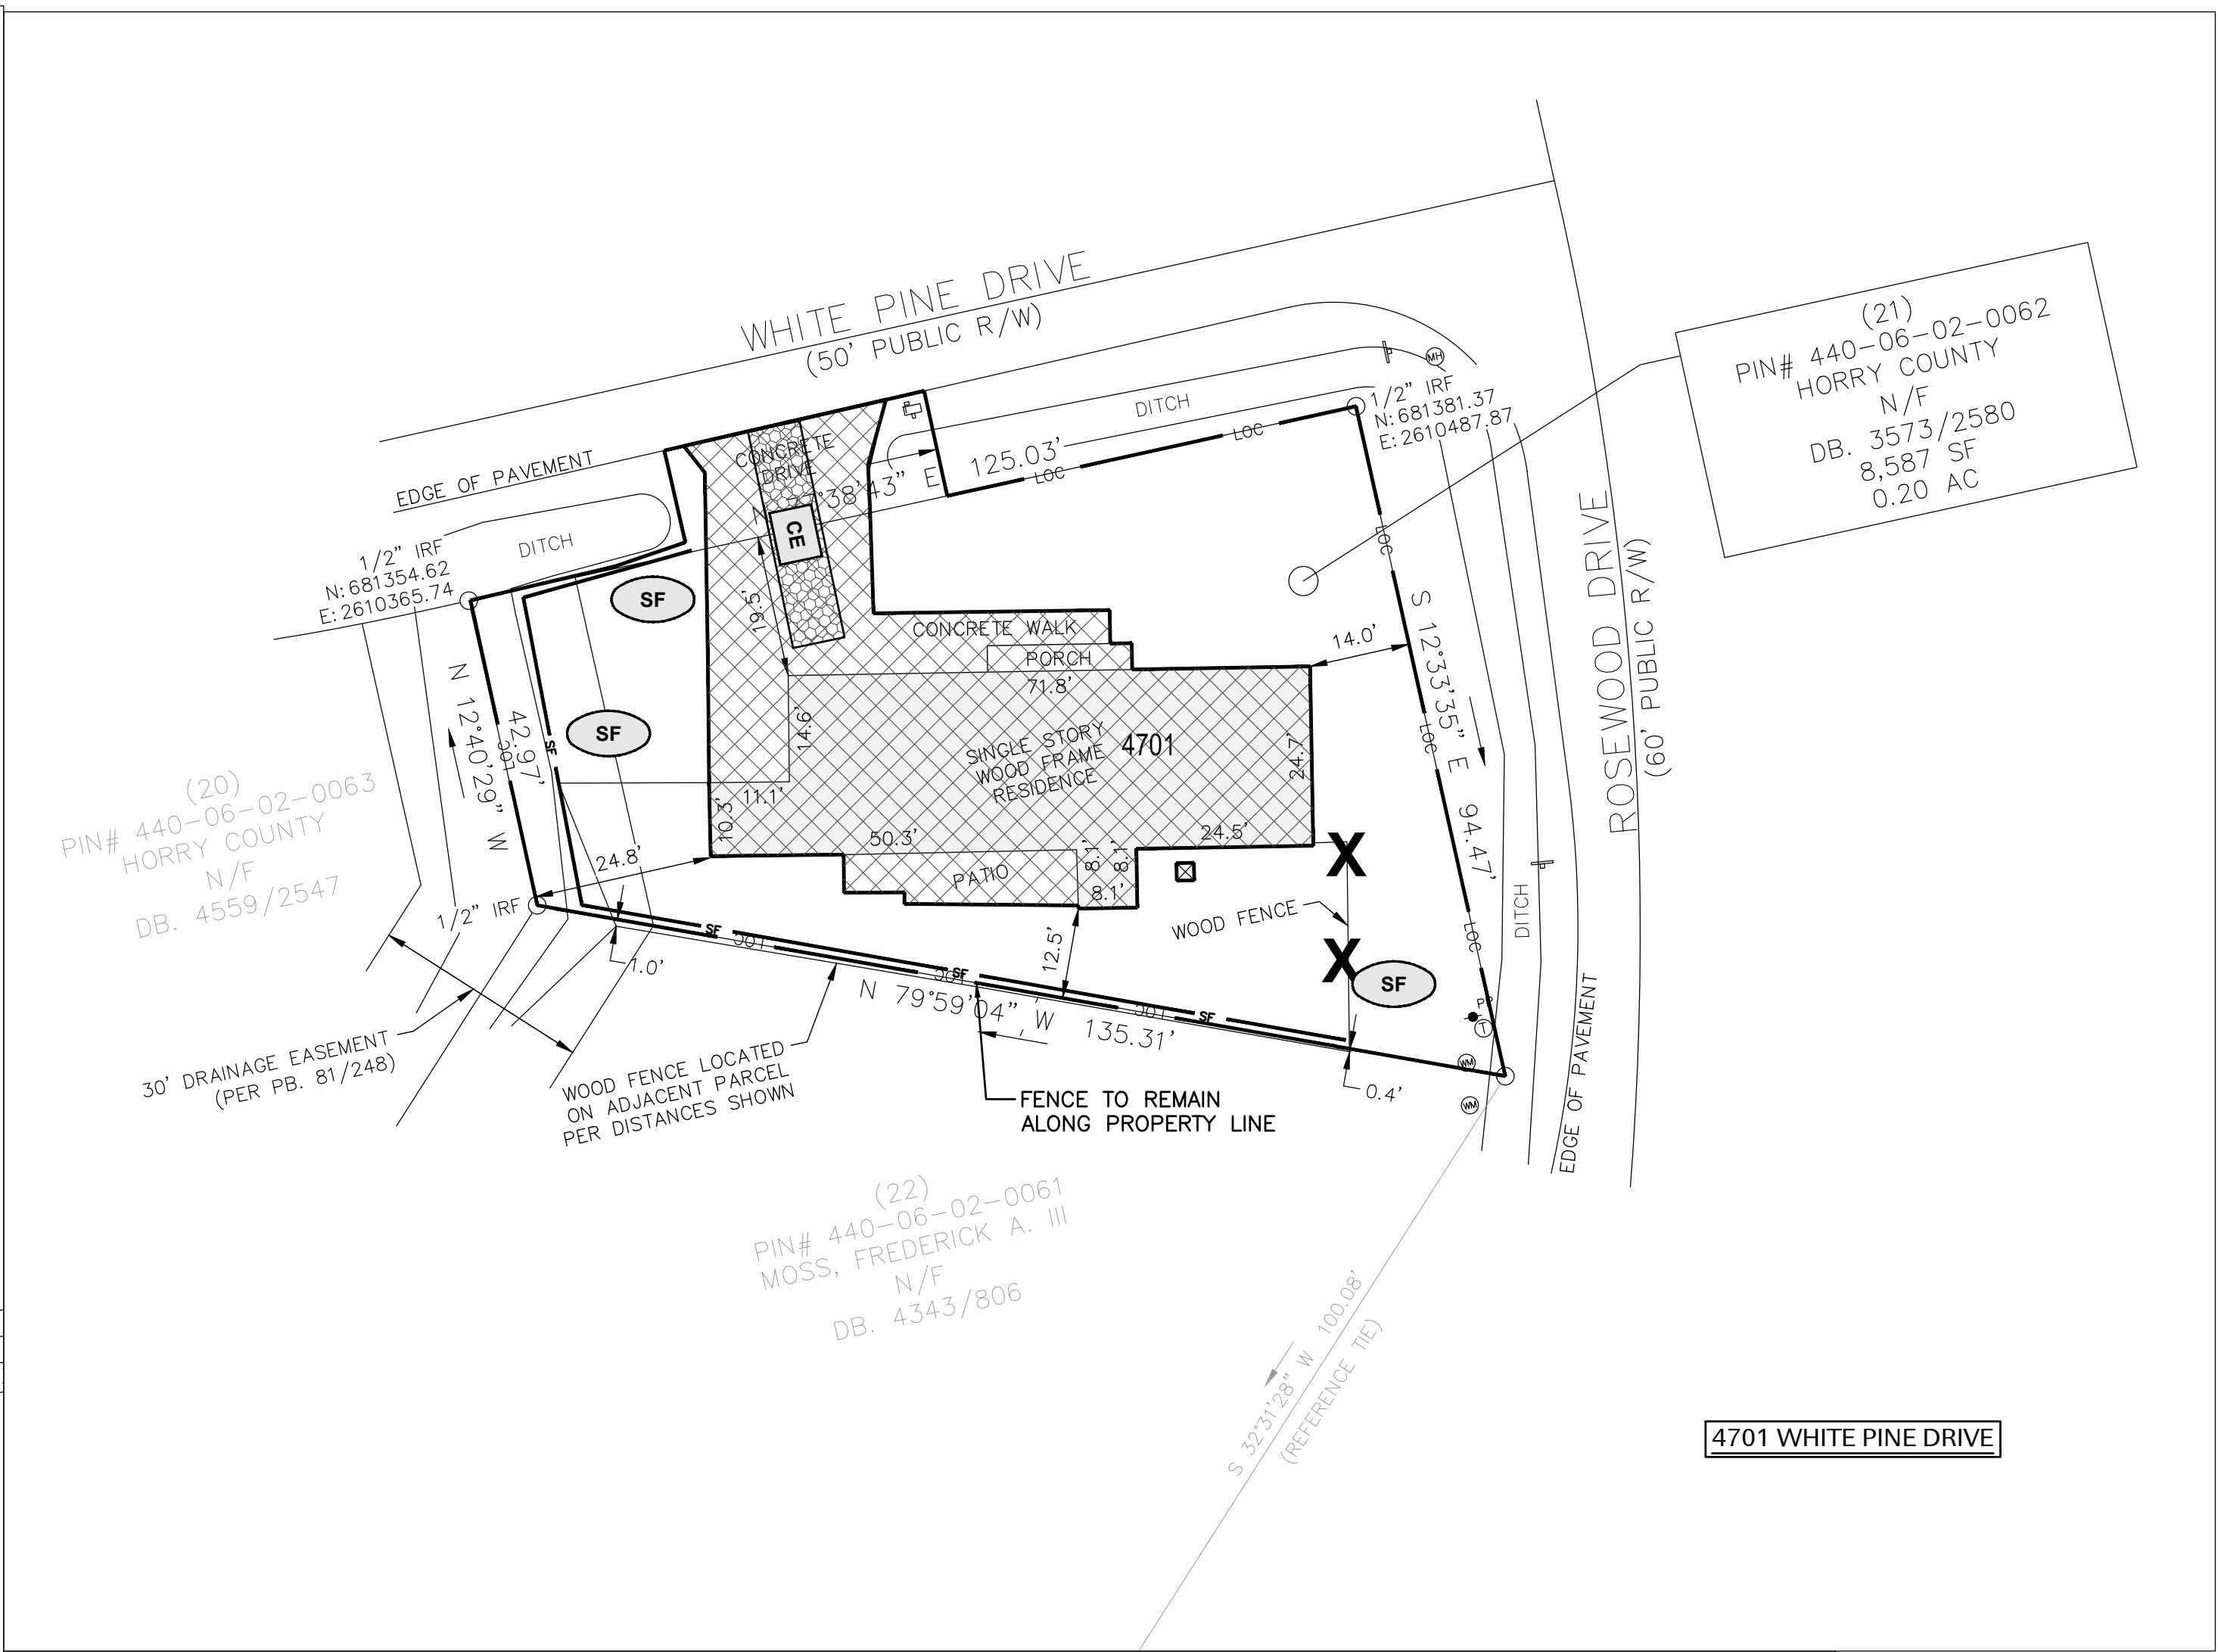
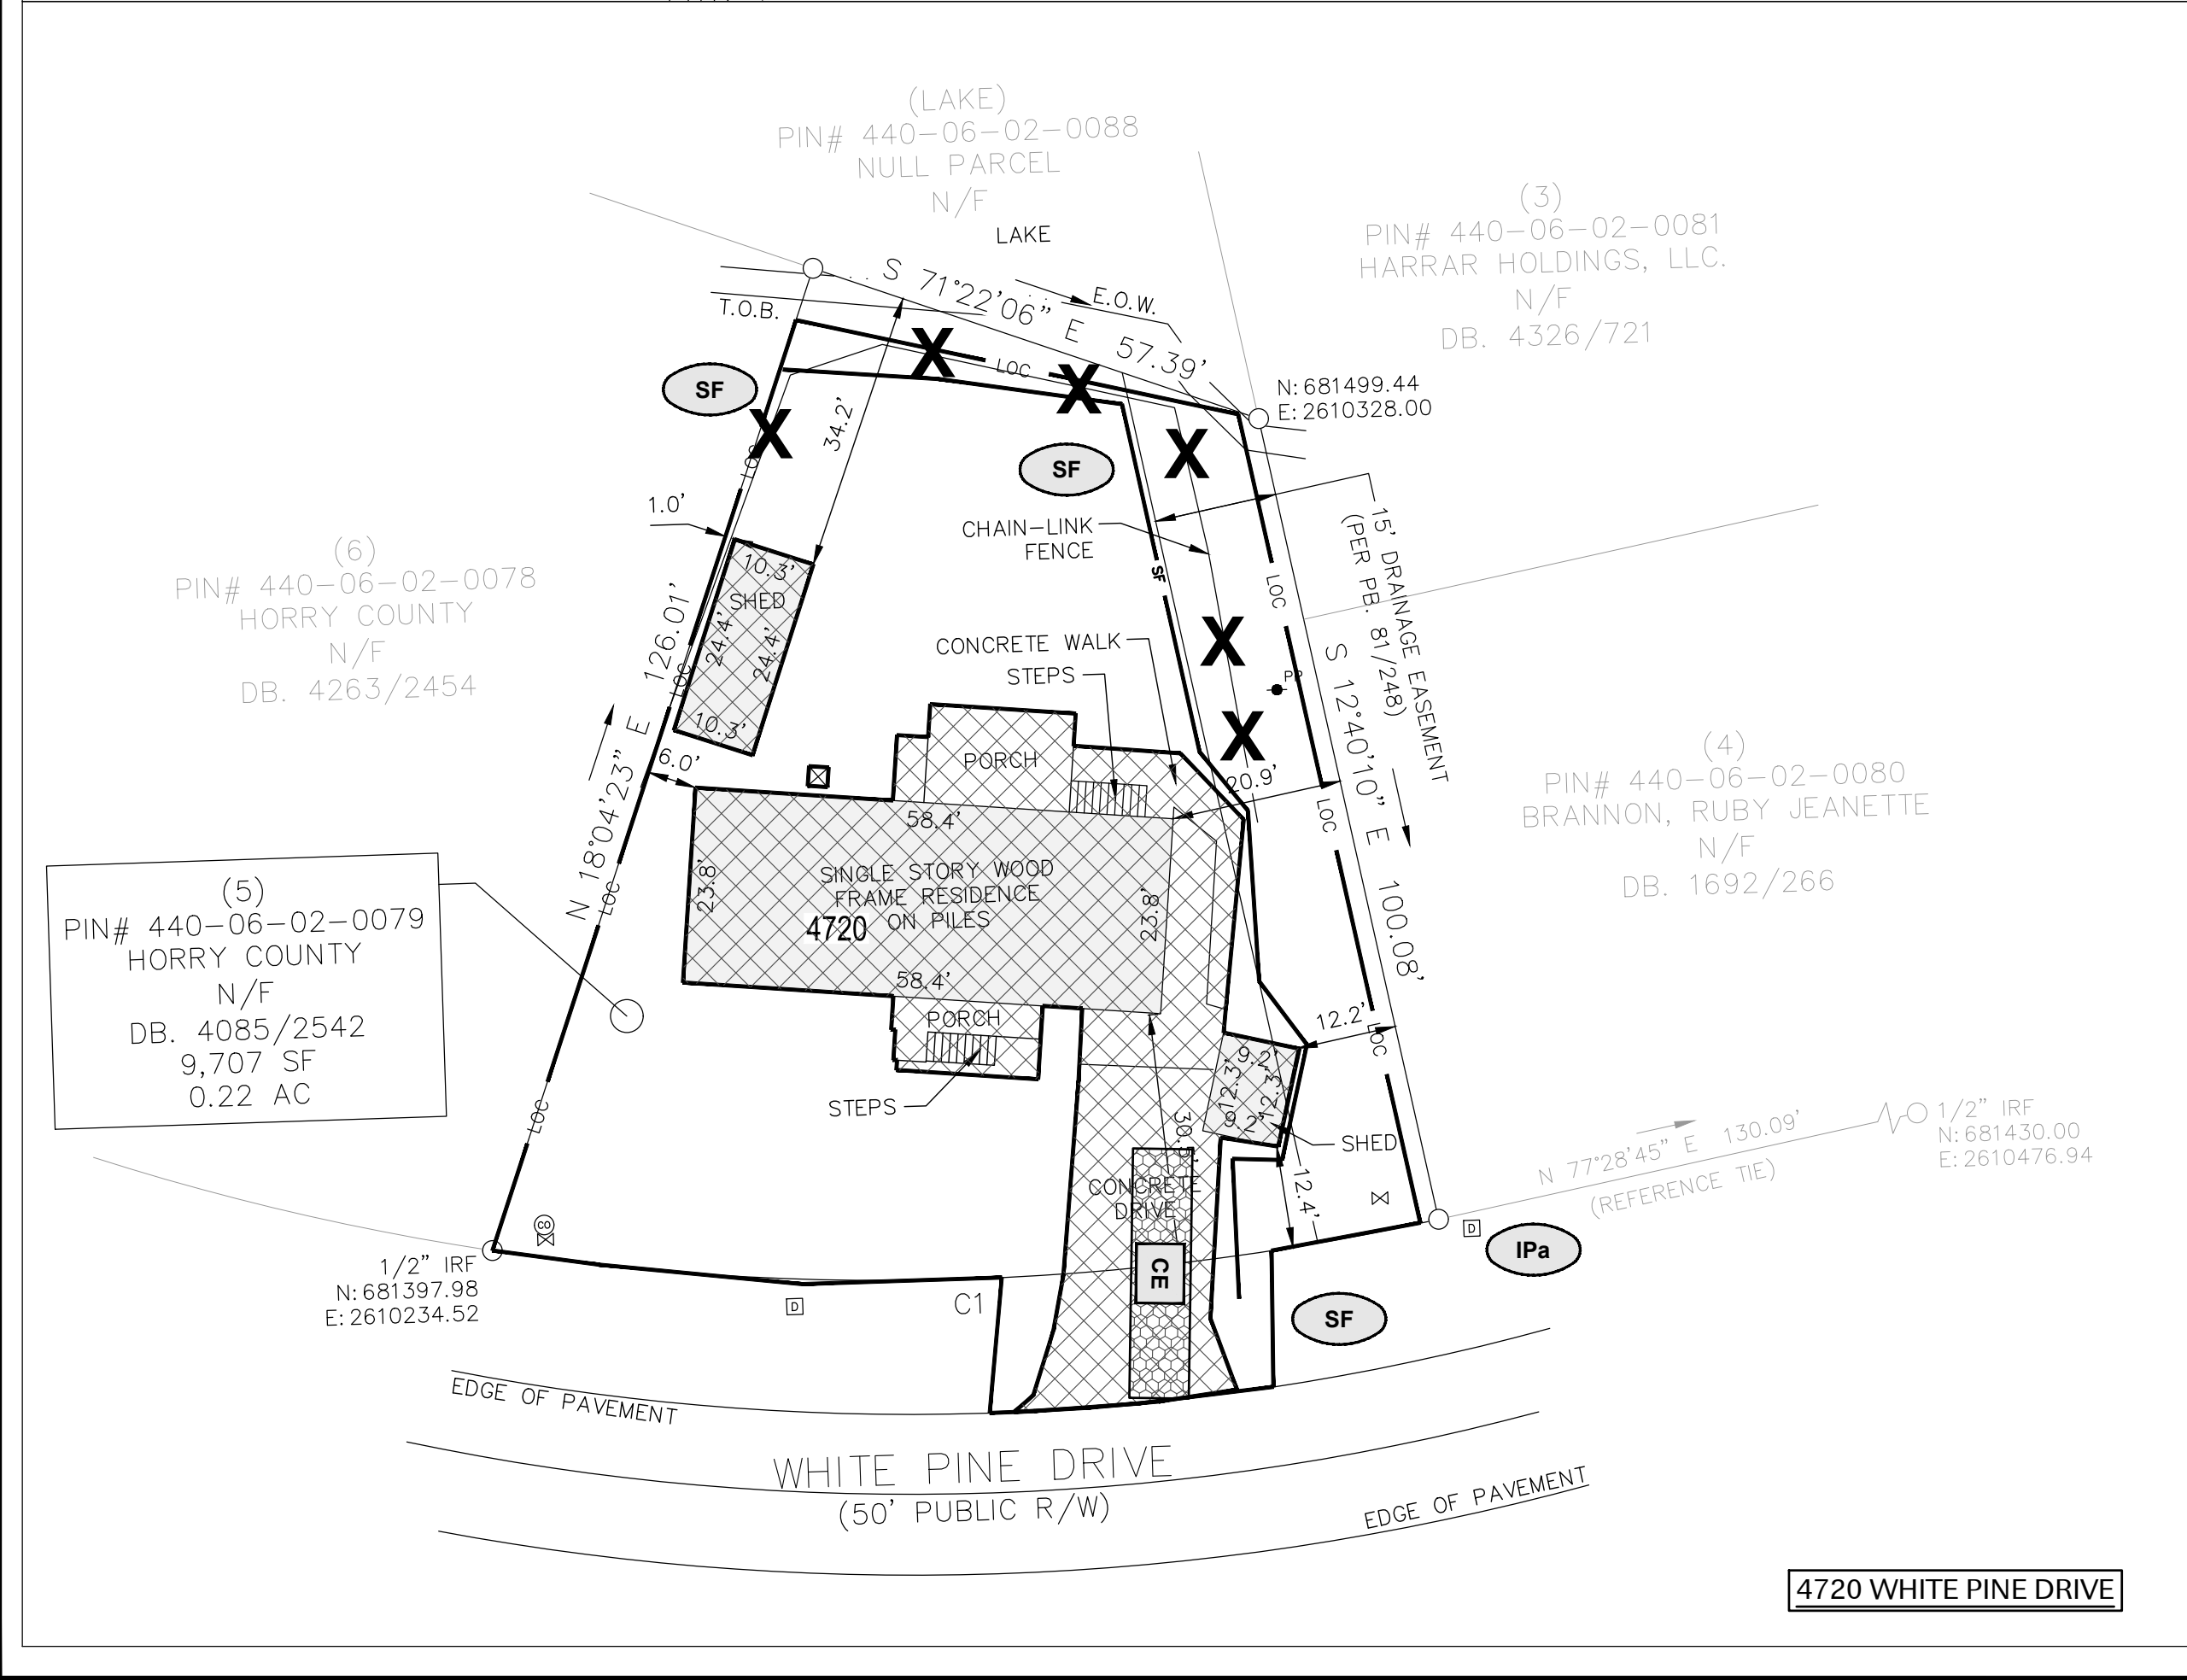
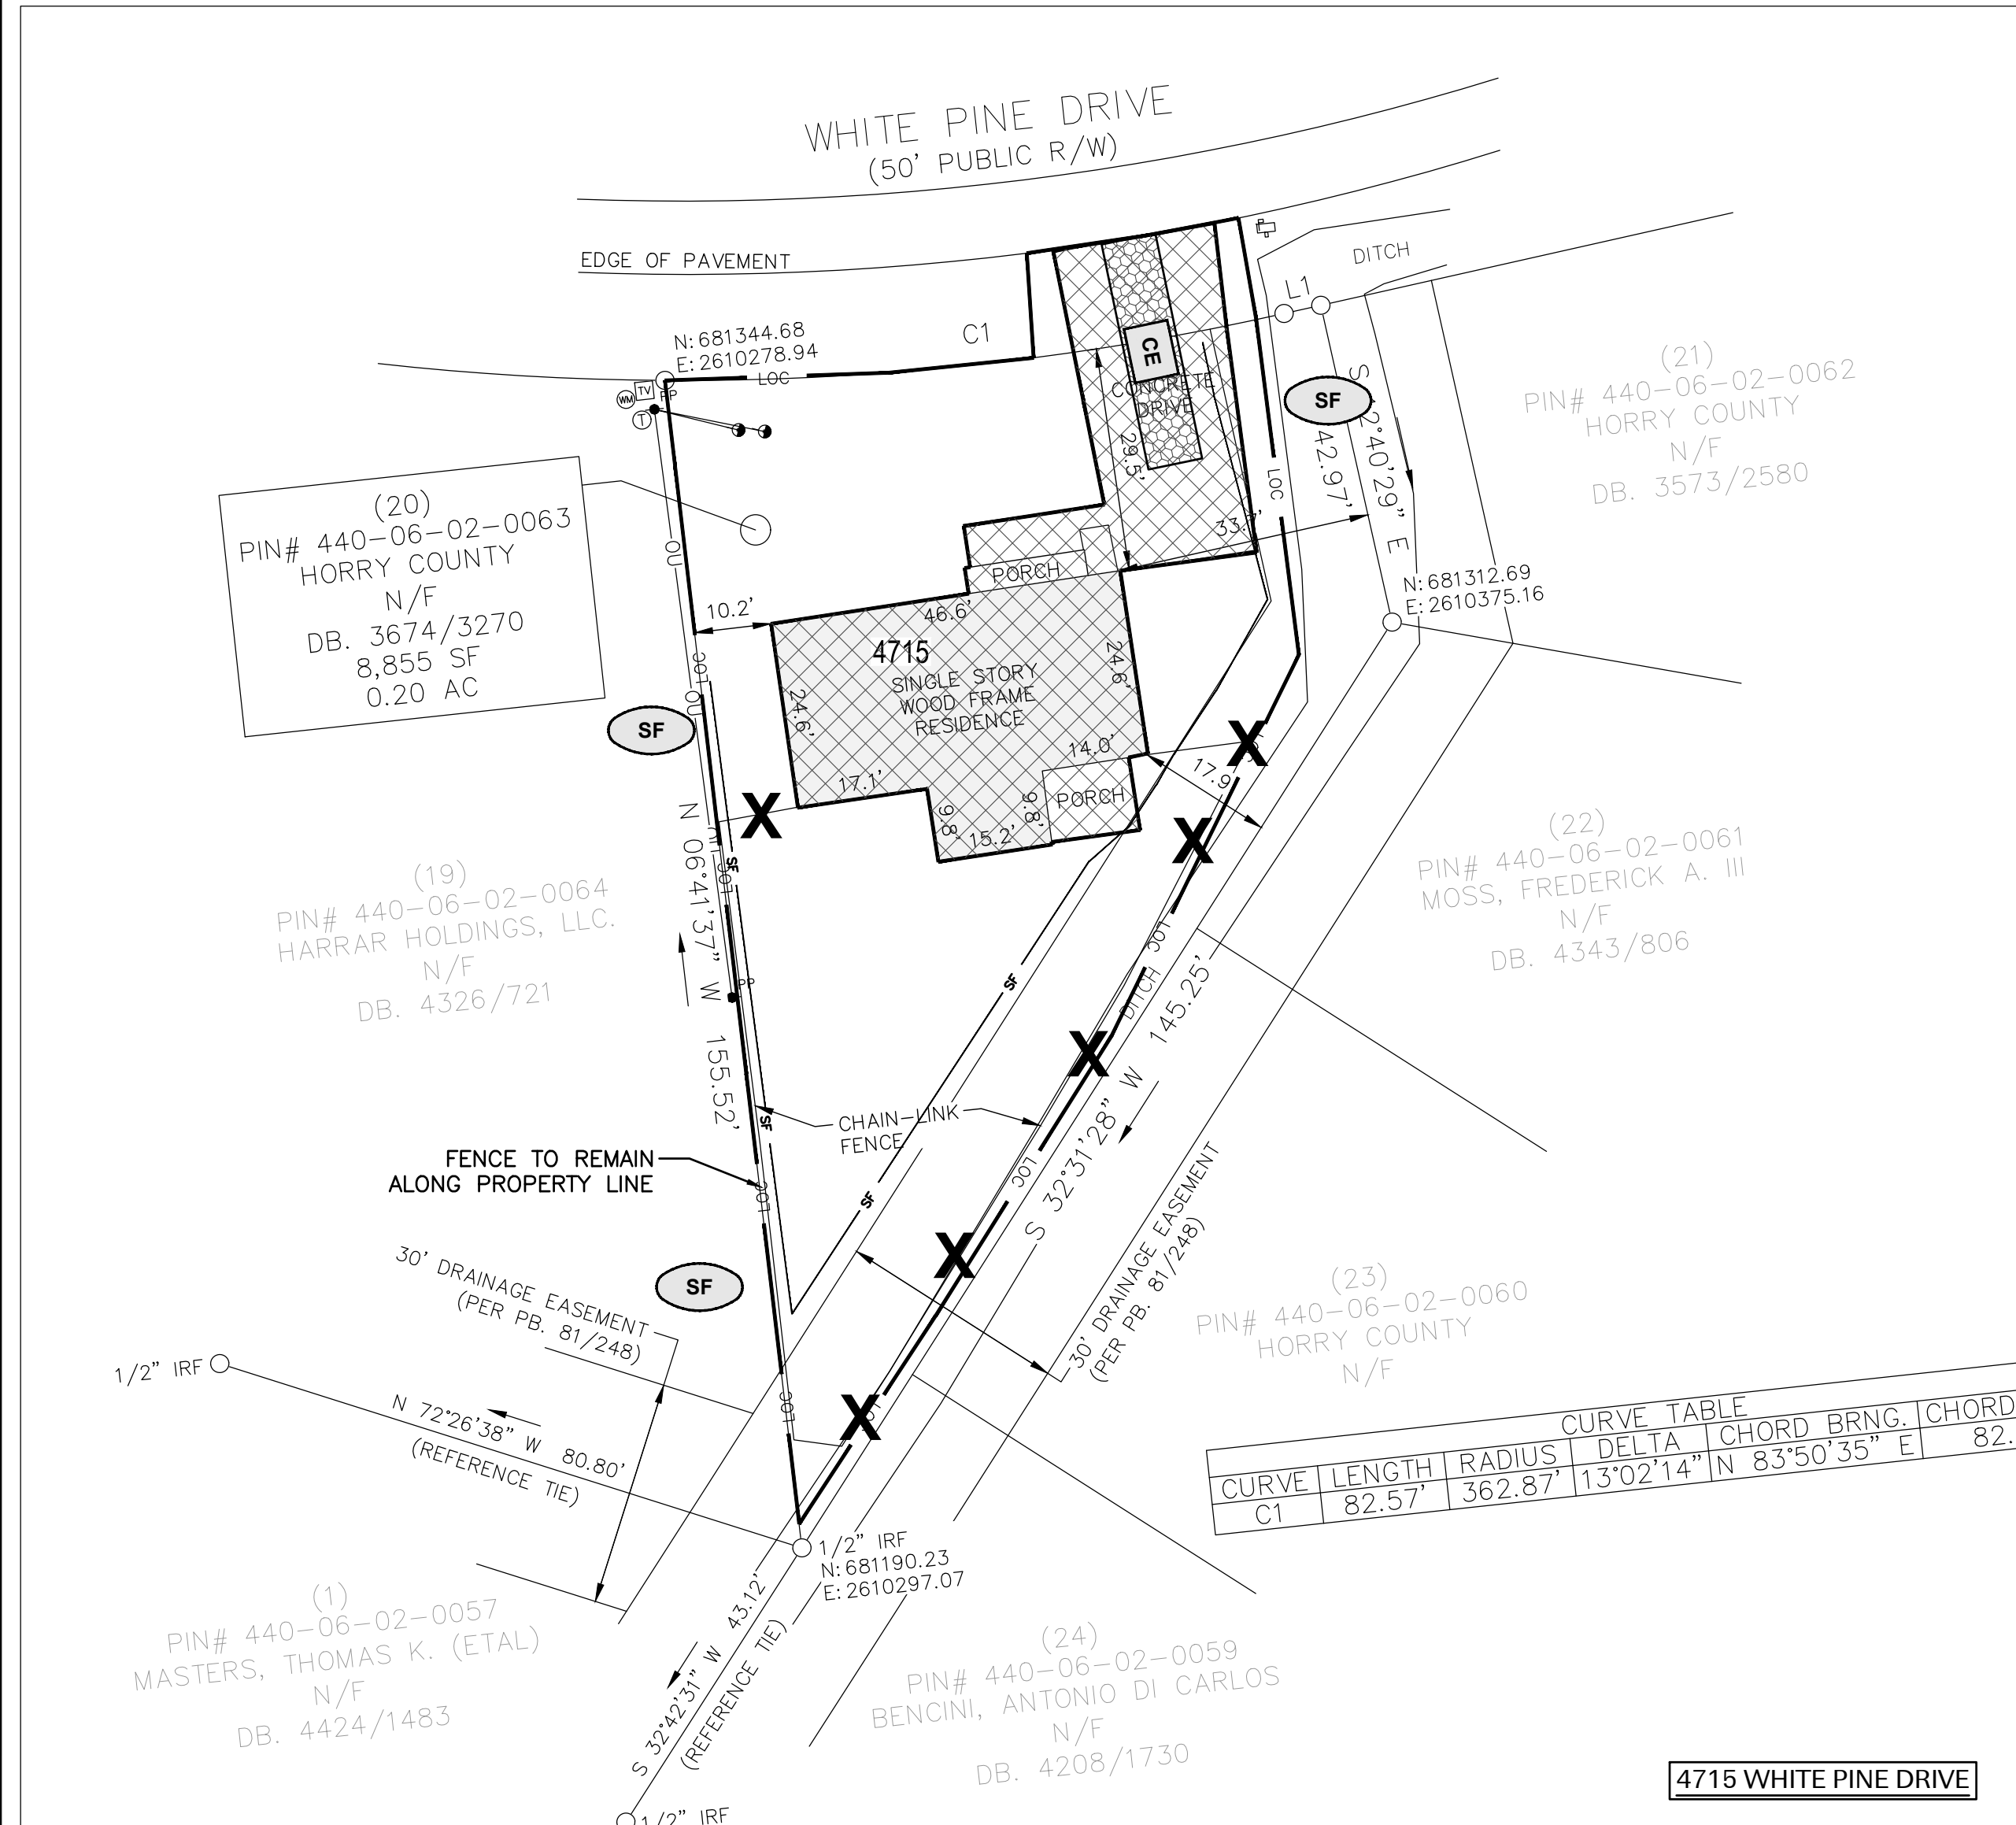
HORRY COUNTY BUYOUT DEMOLITION PLAN - PHASE 2S

SOUTH CAROLINA OFFICE OF RESILIENCE
HORRY COUNTY, SOUTH CAROLINA

Project Title / Client Information	Date	Revisions	Drawn By	Project No.	Checked By	Date	Approved By
DEMOLITION PLAN - PHASE 2							

Drawing No. **C3.2**



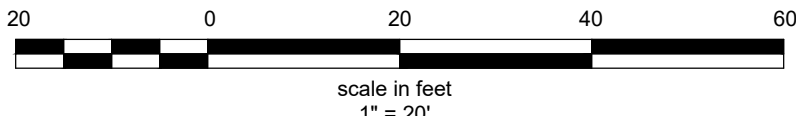

LEGEND

— LOC — LIMITS OF DISTURBANCE
— SF — SILT FENCE (SF)


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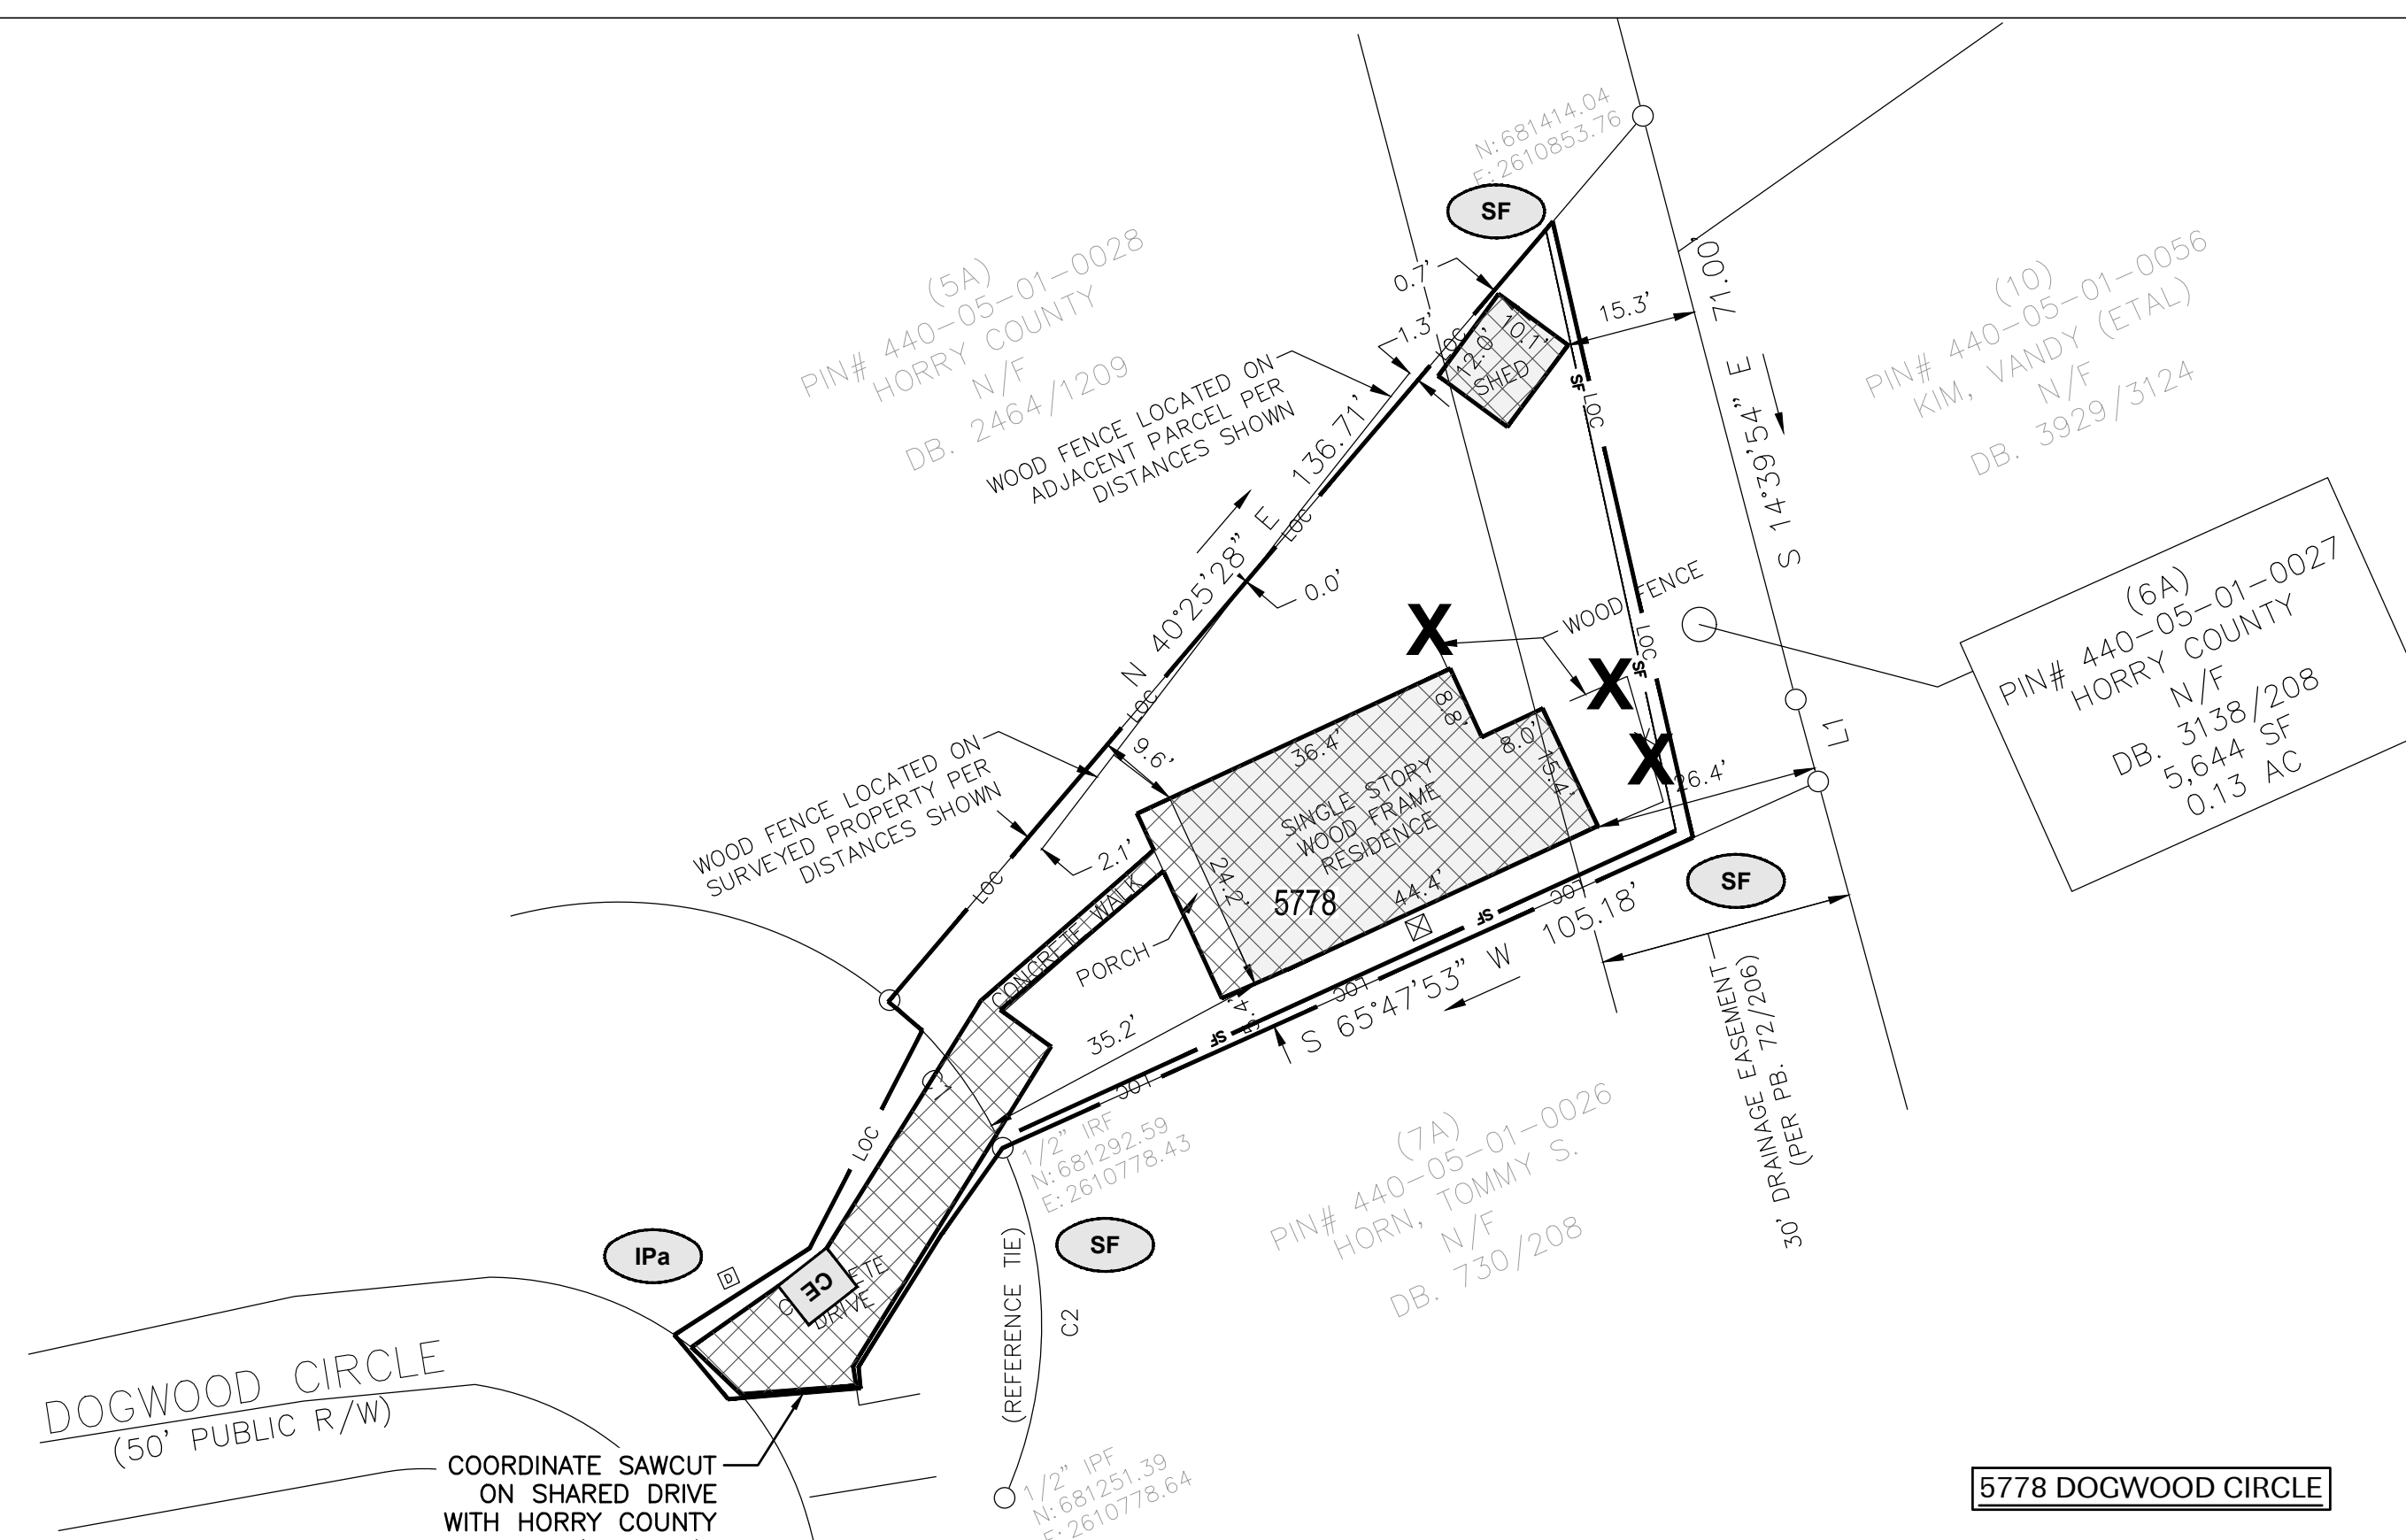
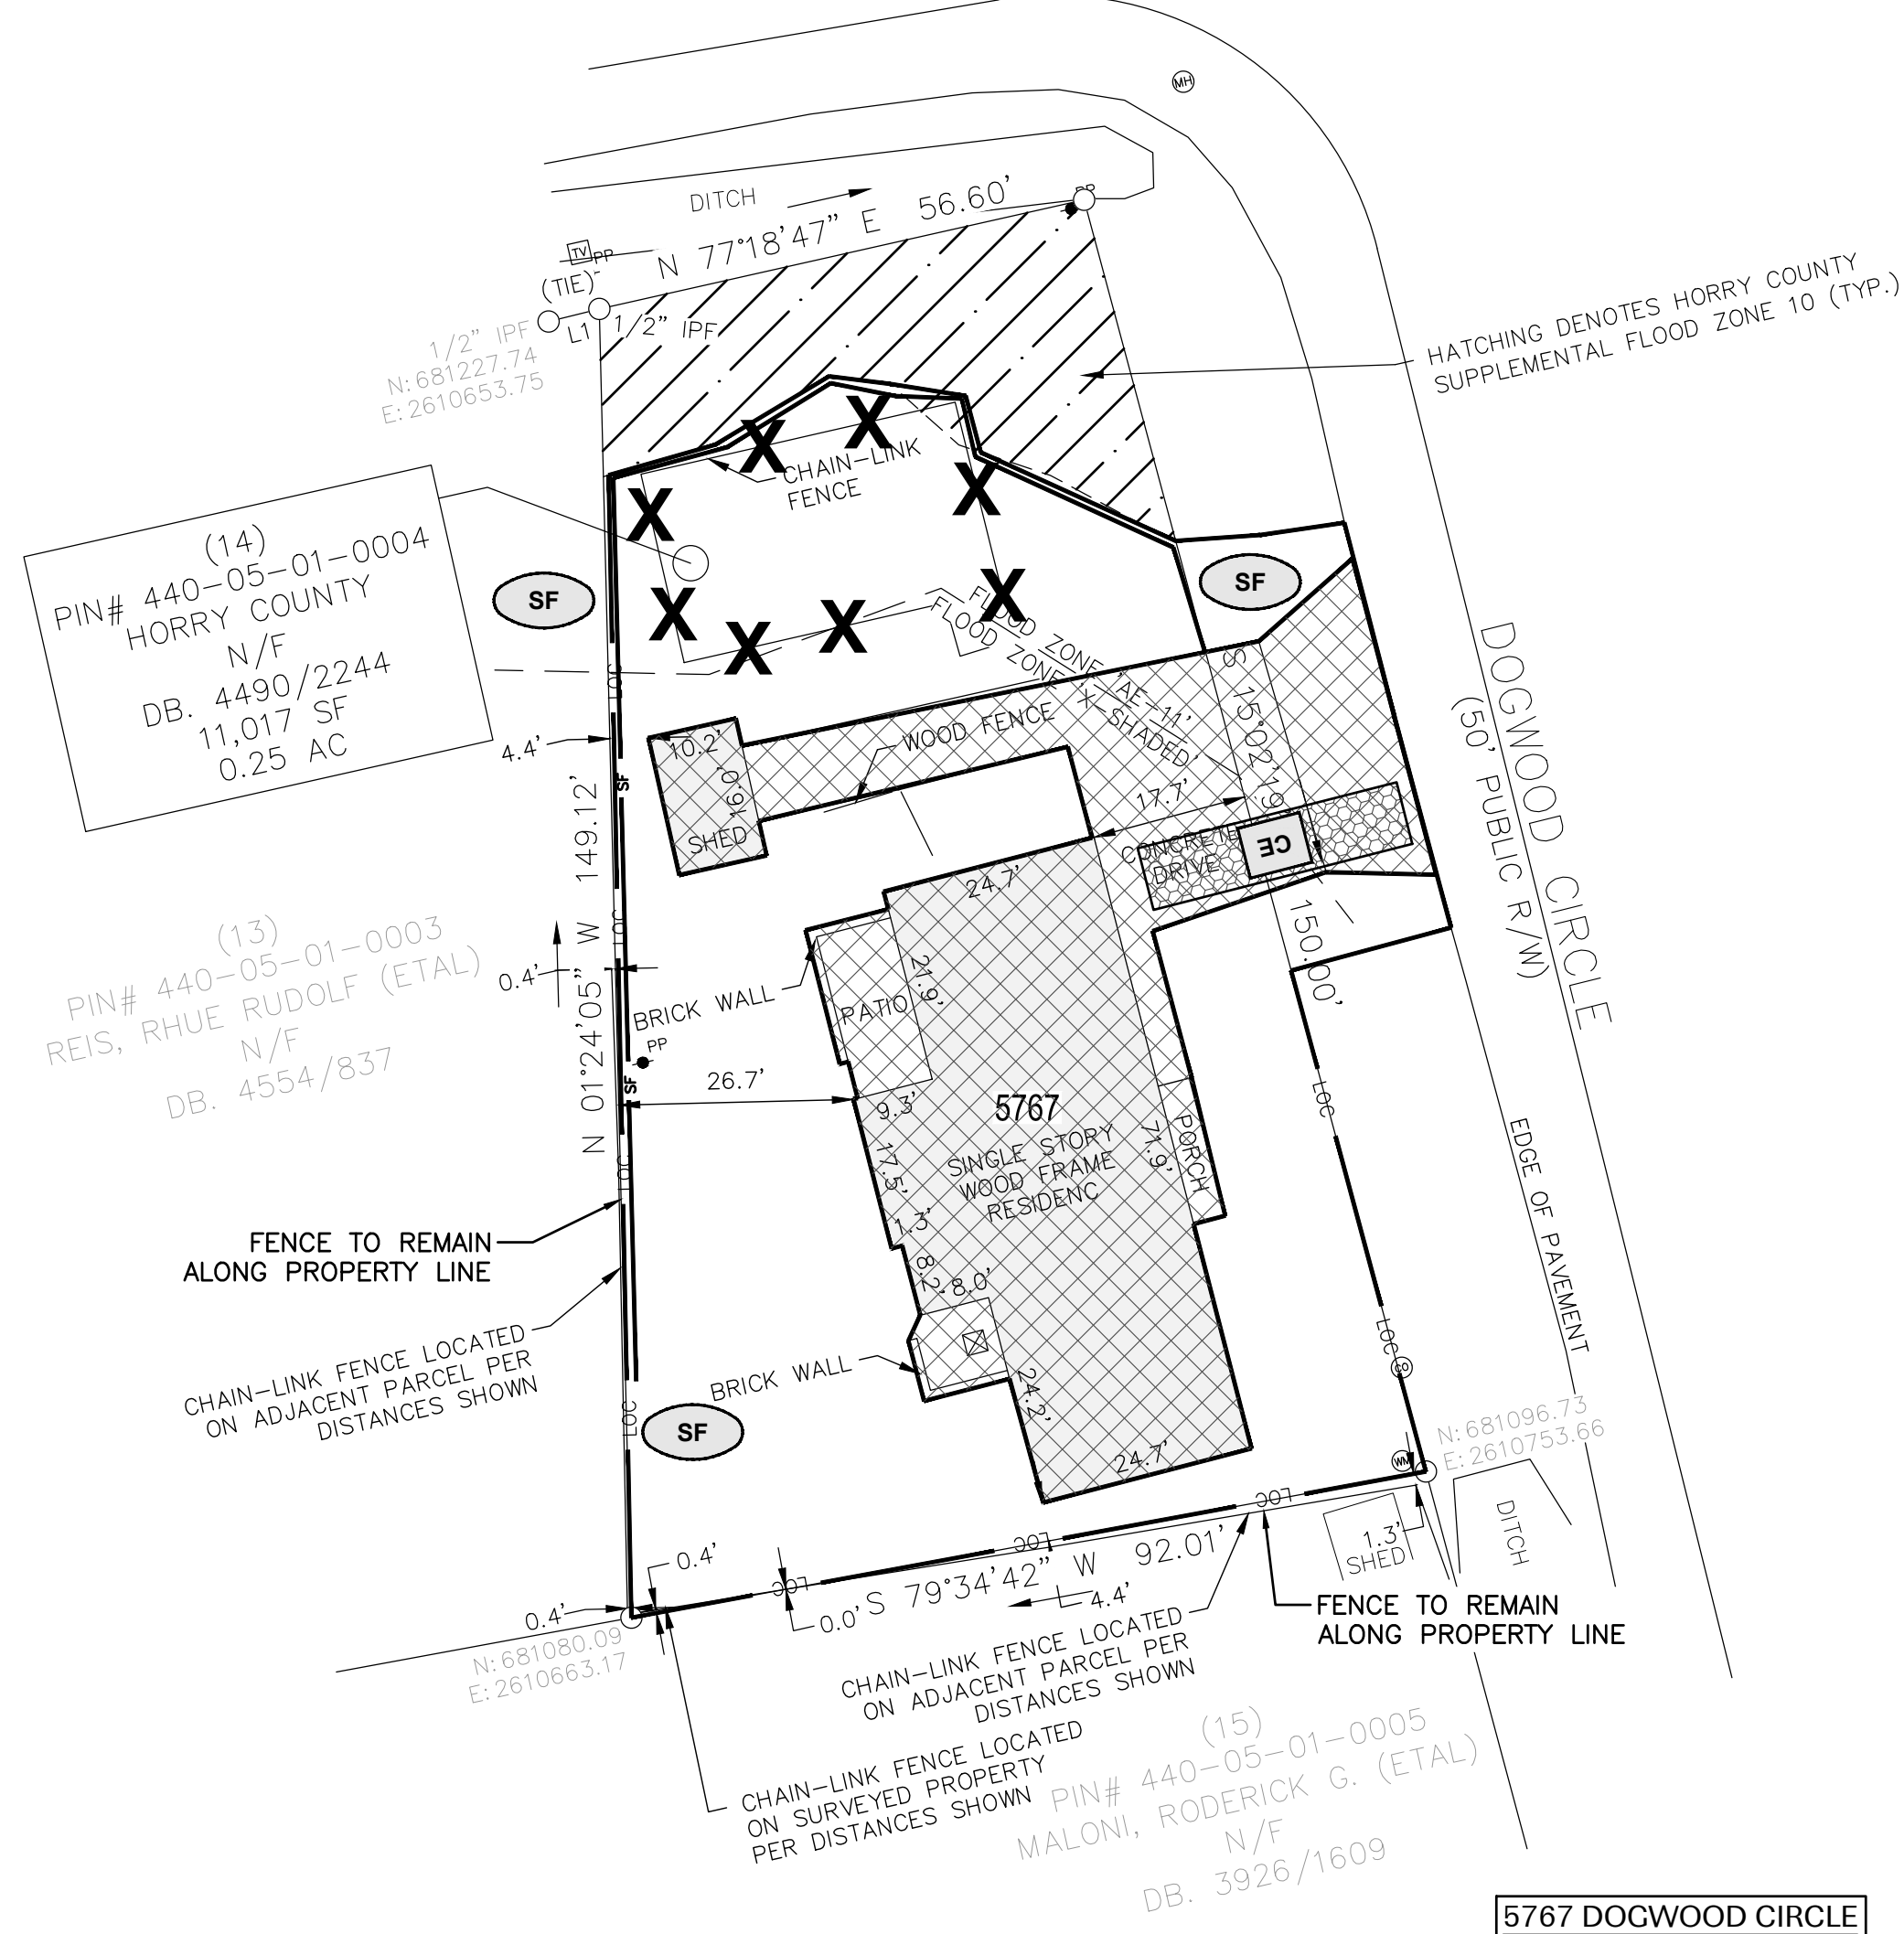
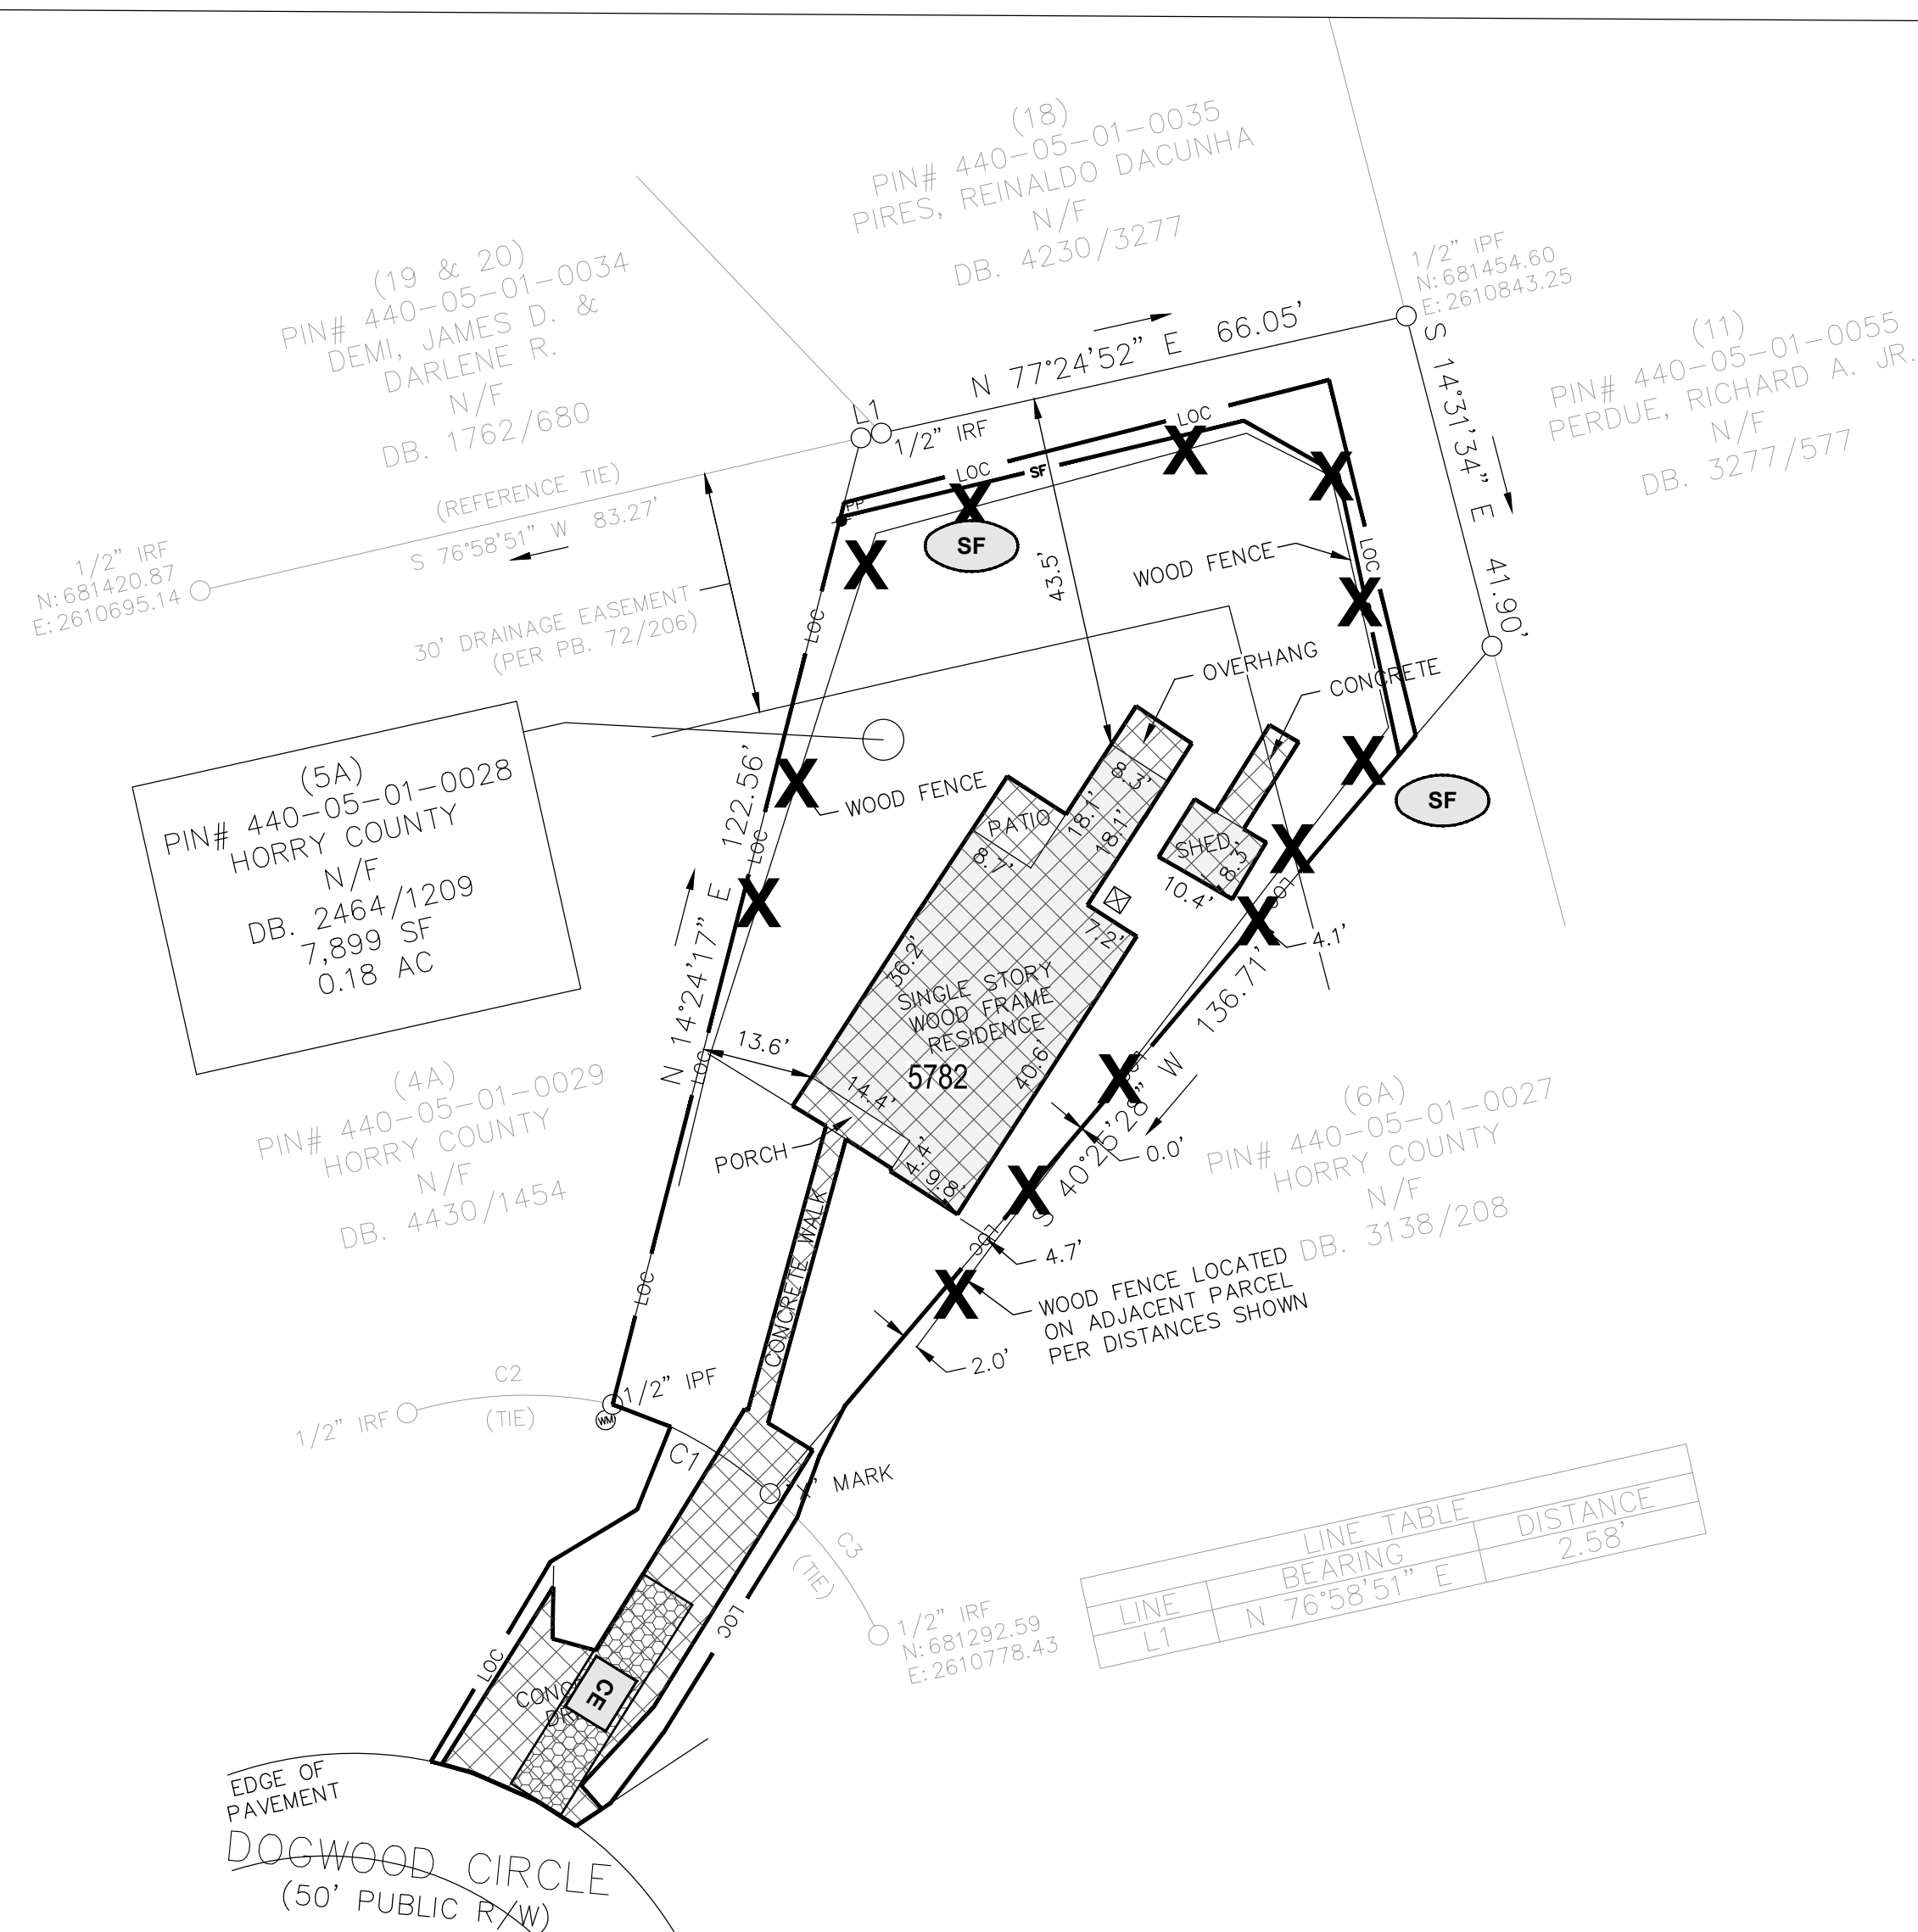
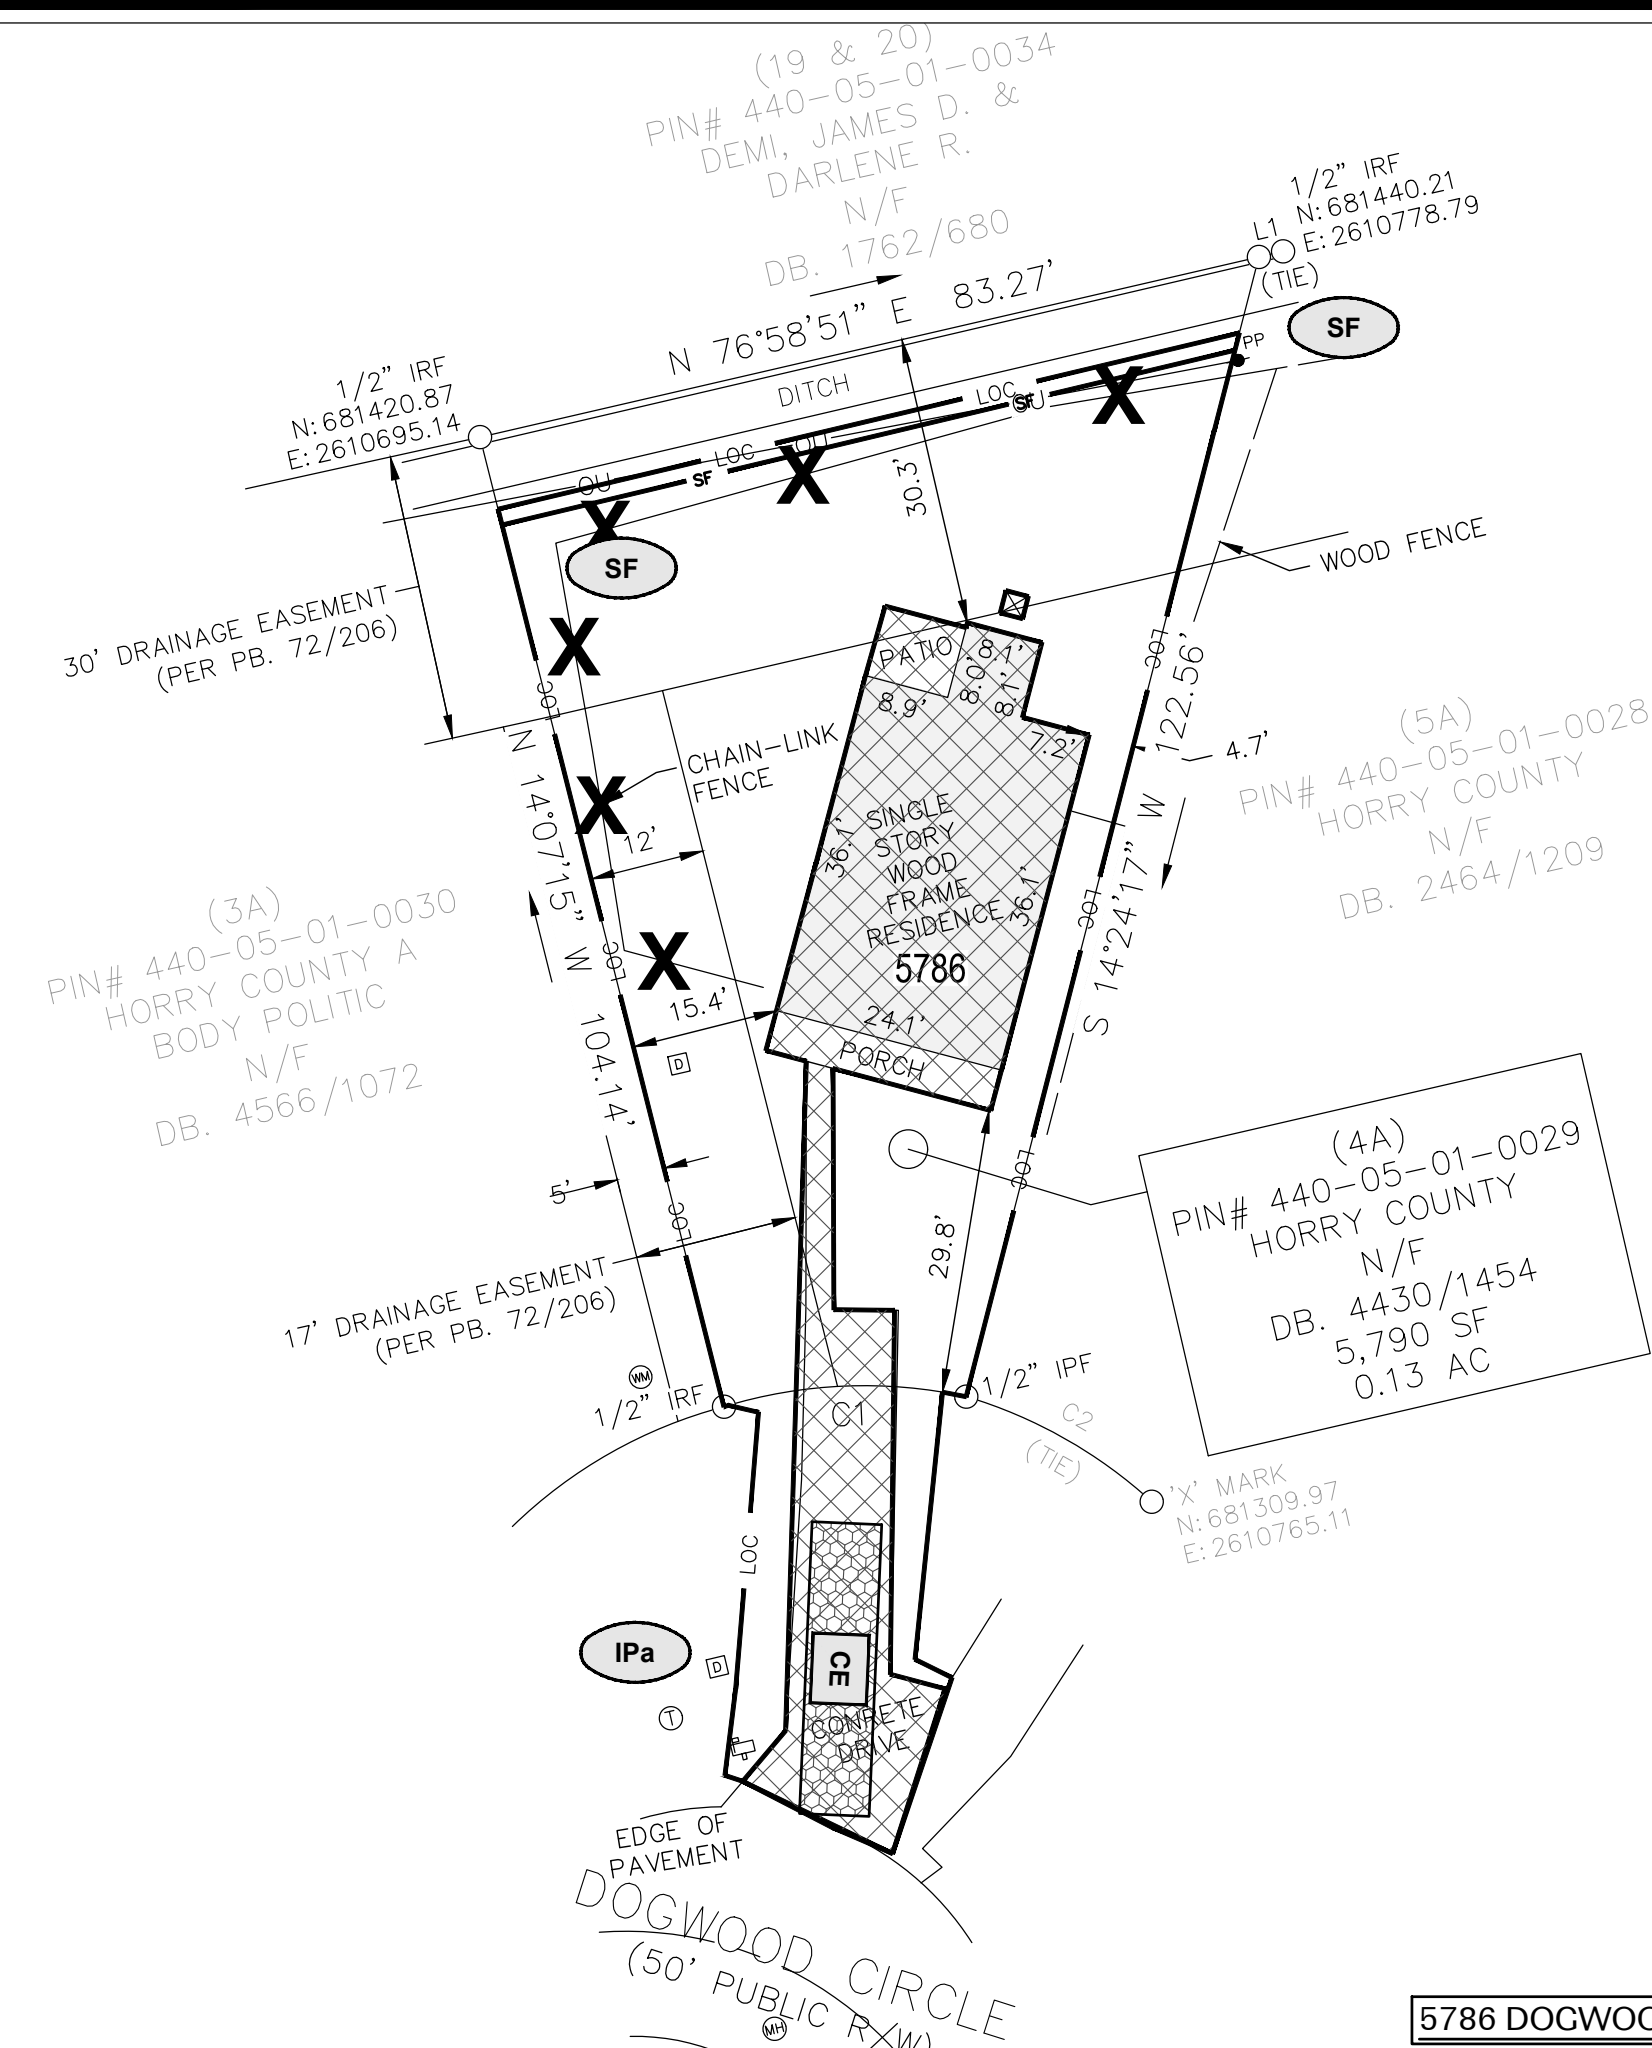
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SEDIMENT TUBES







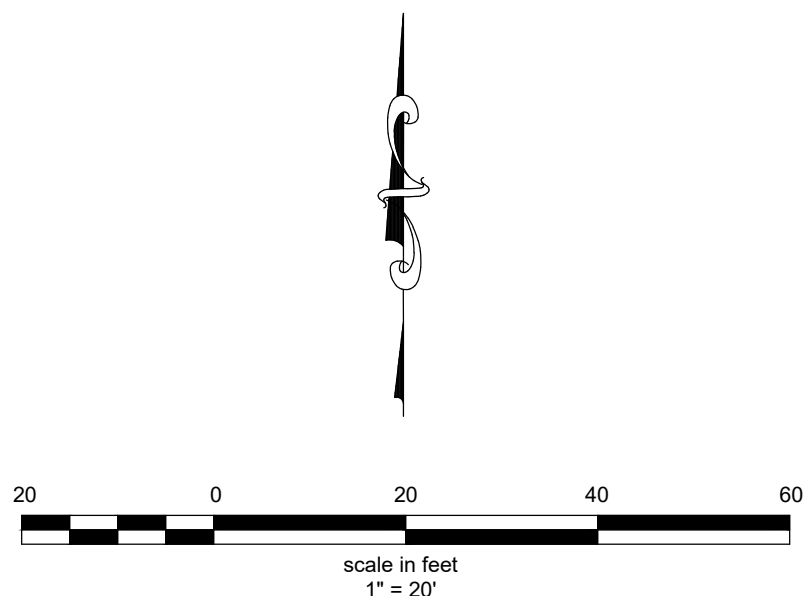


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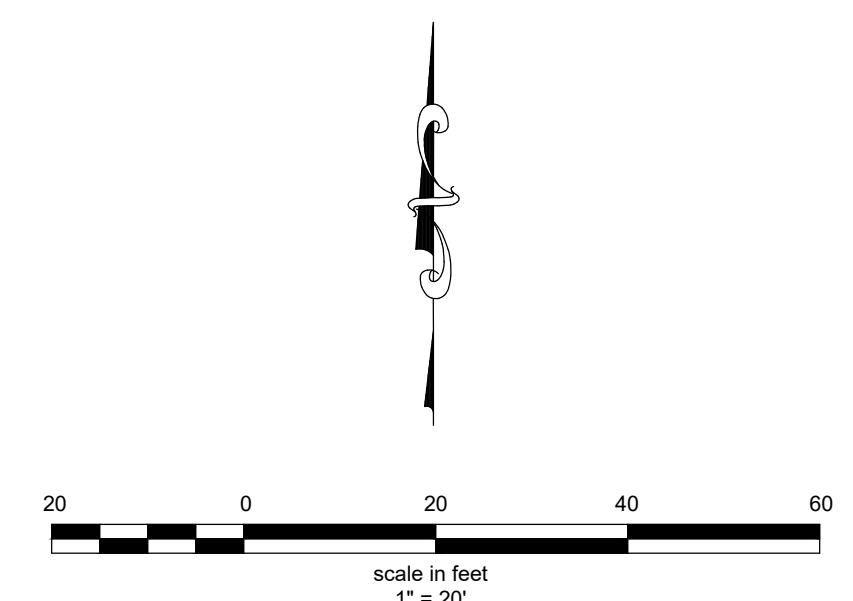
GENERAL DEMOLITION AREA








LEGEND

	LIMITS OF DISTURBANCE
	SILT FENCE
	
	TEMPORARY CONSTRUCTION ENTRANCE/EXIT
	INLET PROTECTION DET. A
	INLET PROTECTION DET. E
	SEDIMENT TUBES
	ITEMS TO BE DEMOLISHED
	GENERAL DEMOLITION AREA



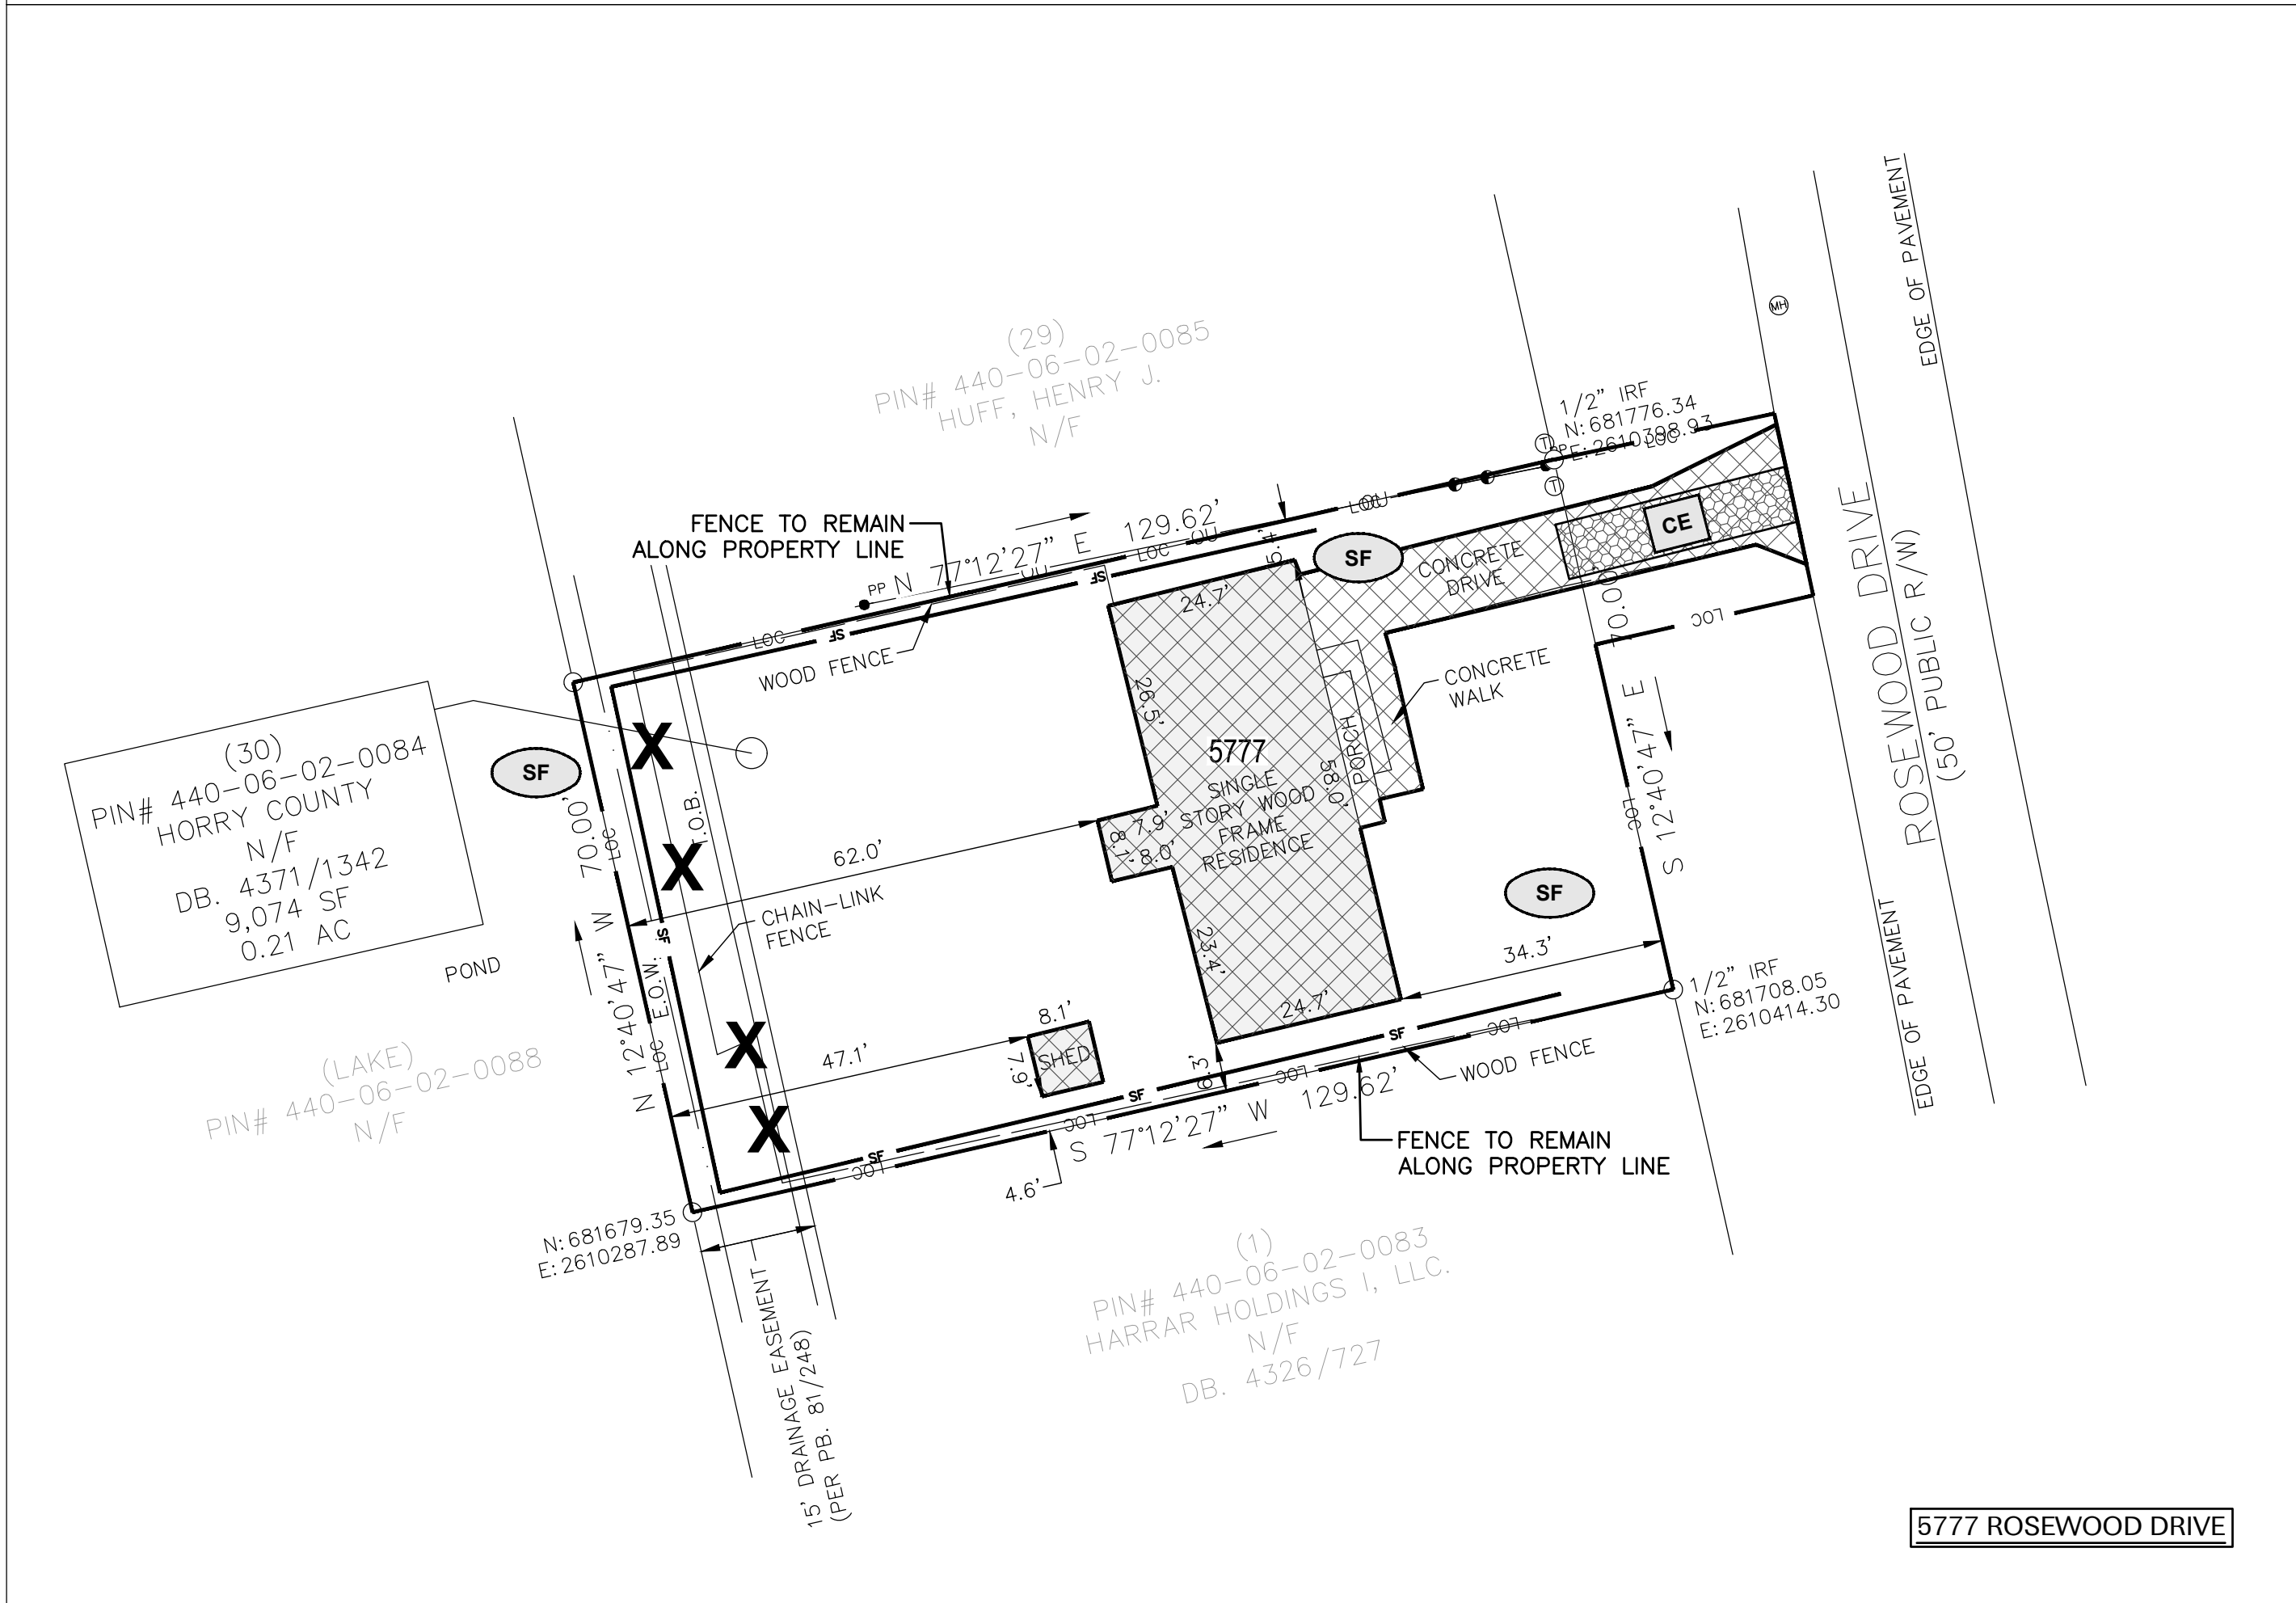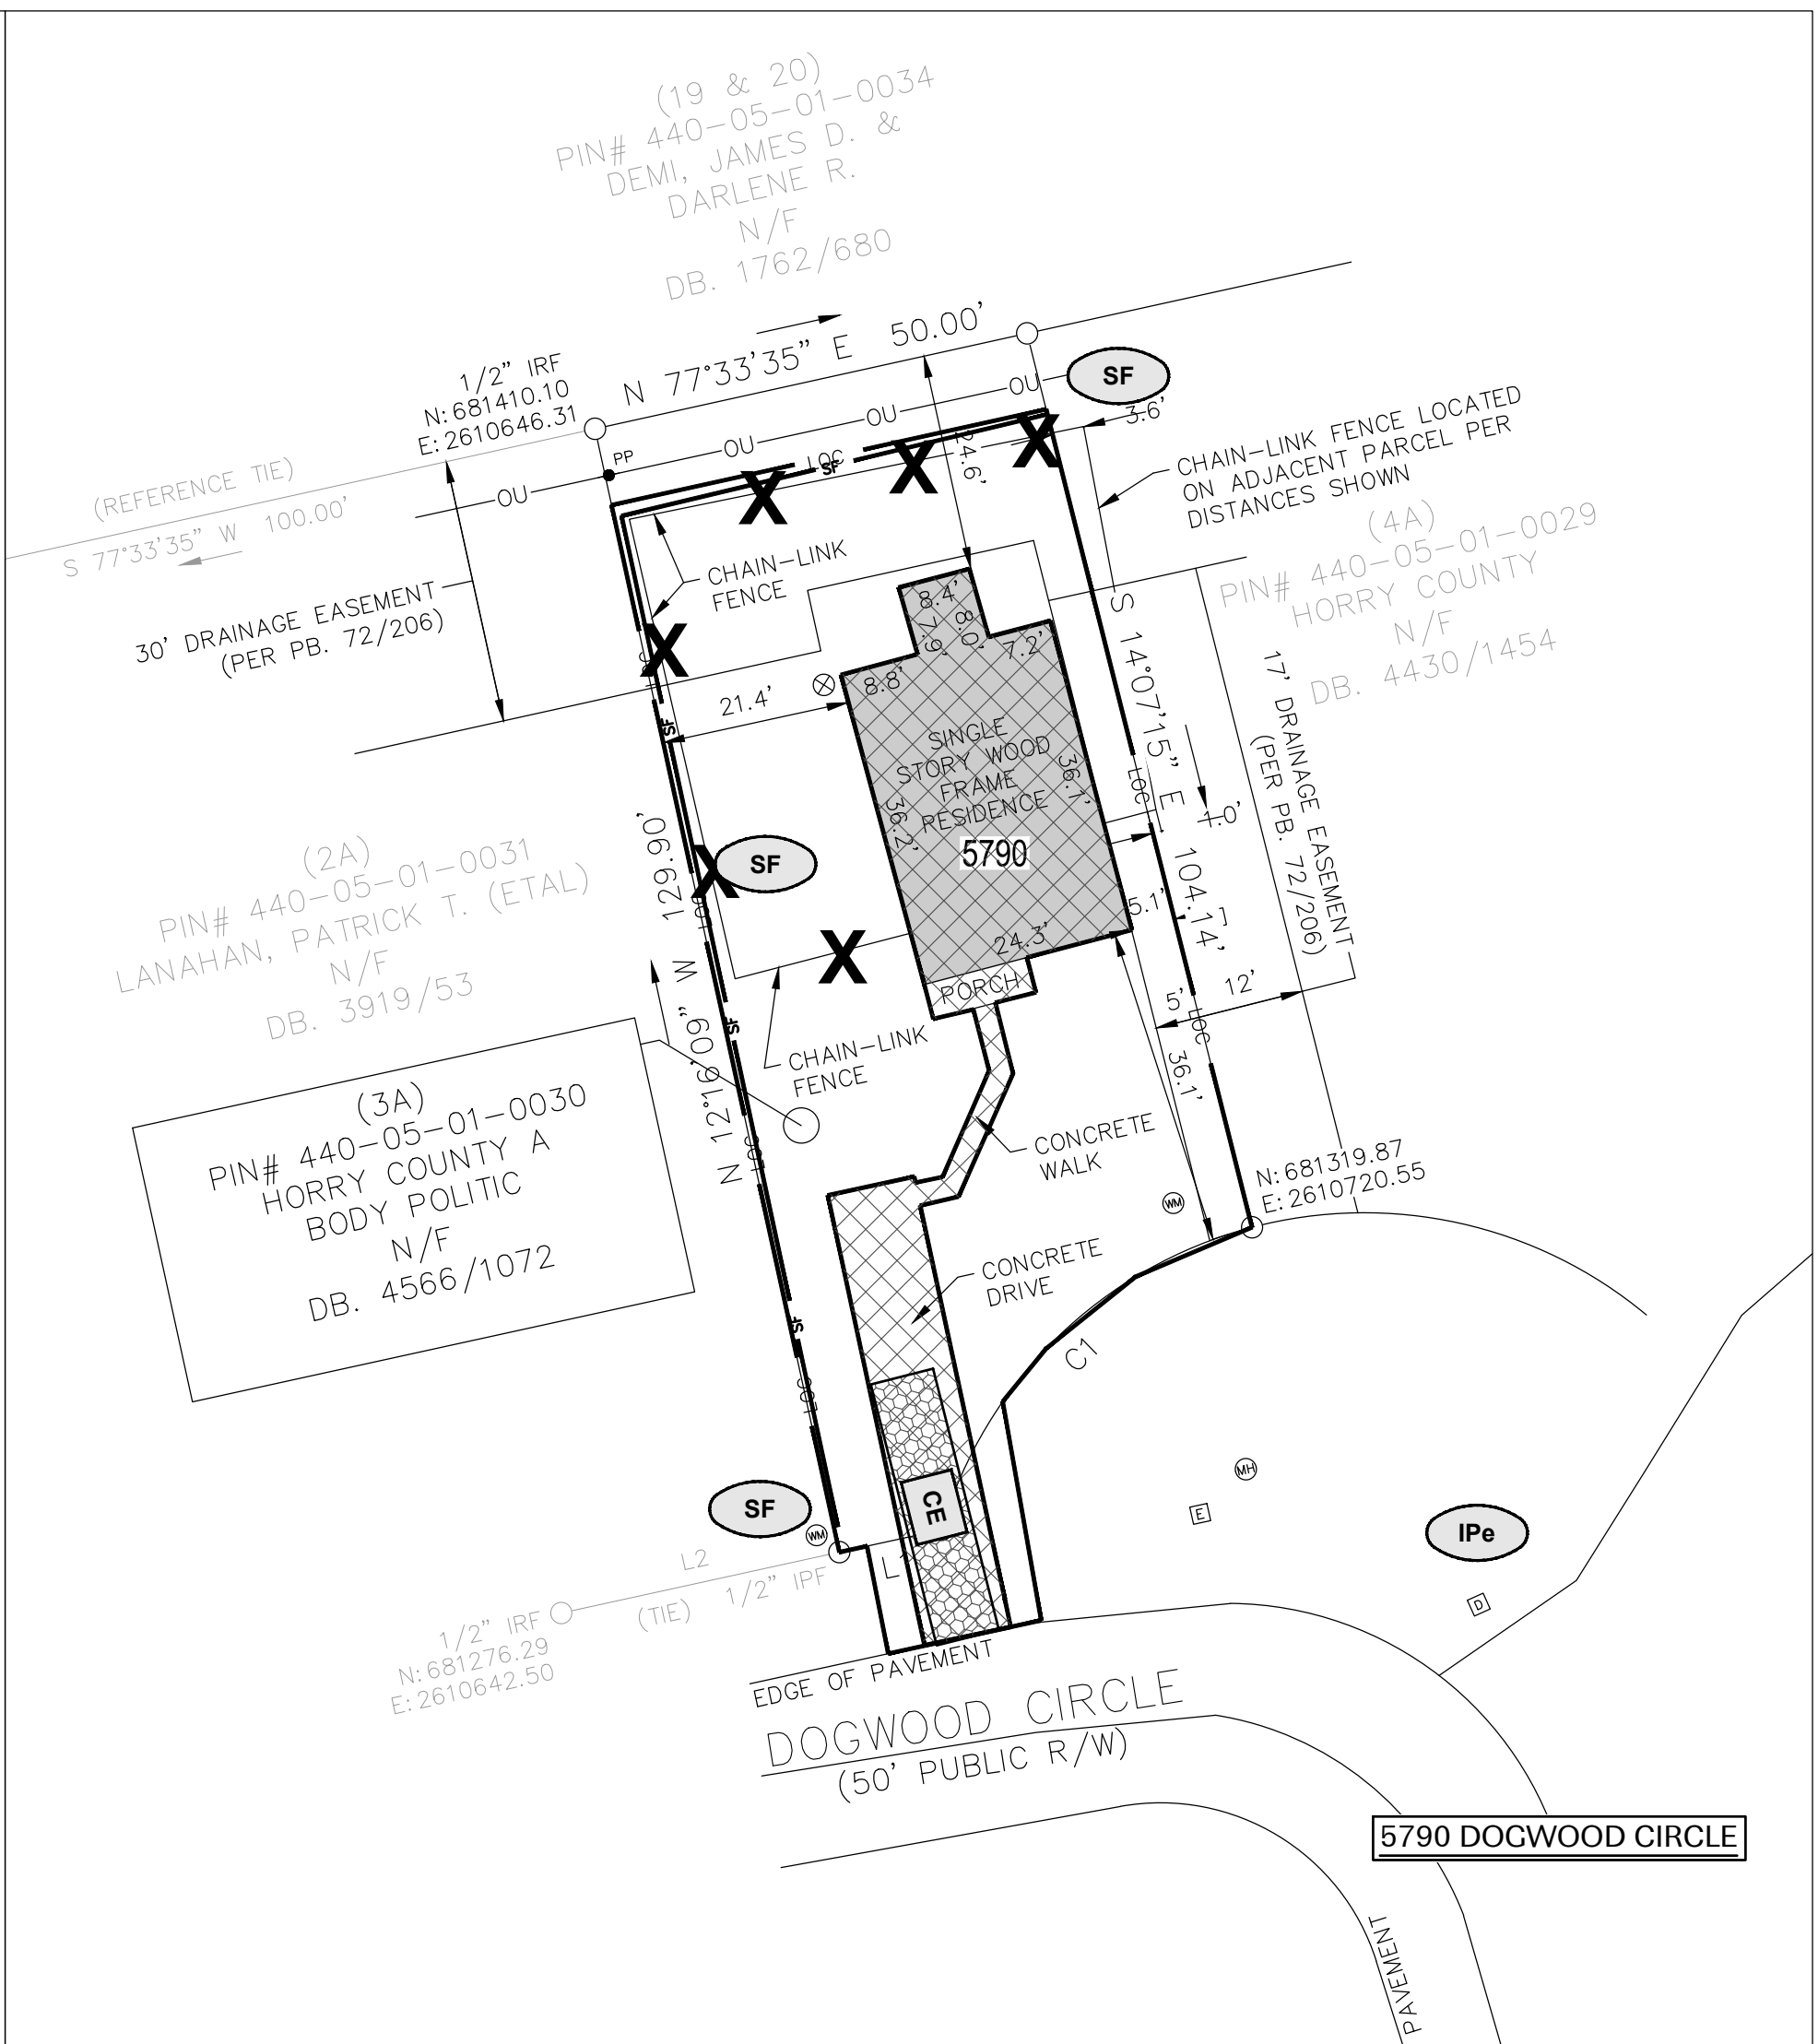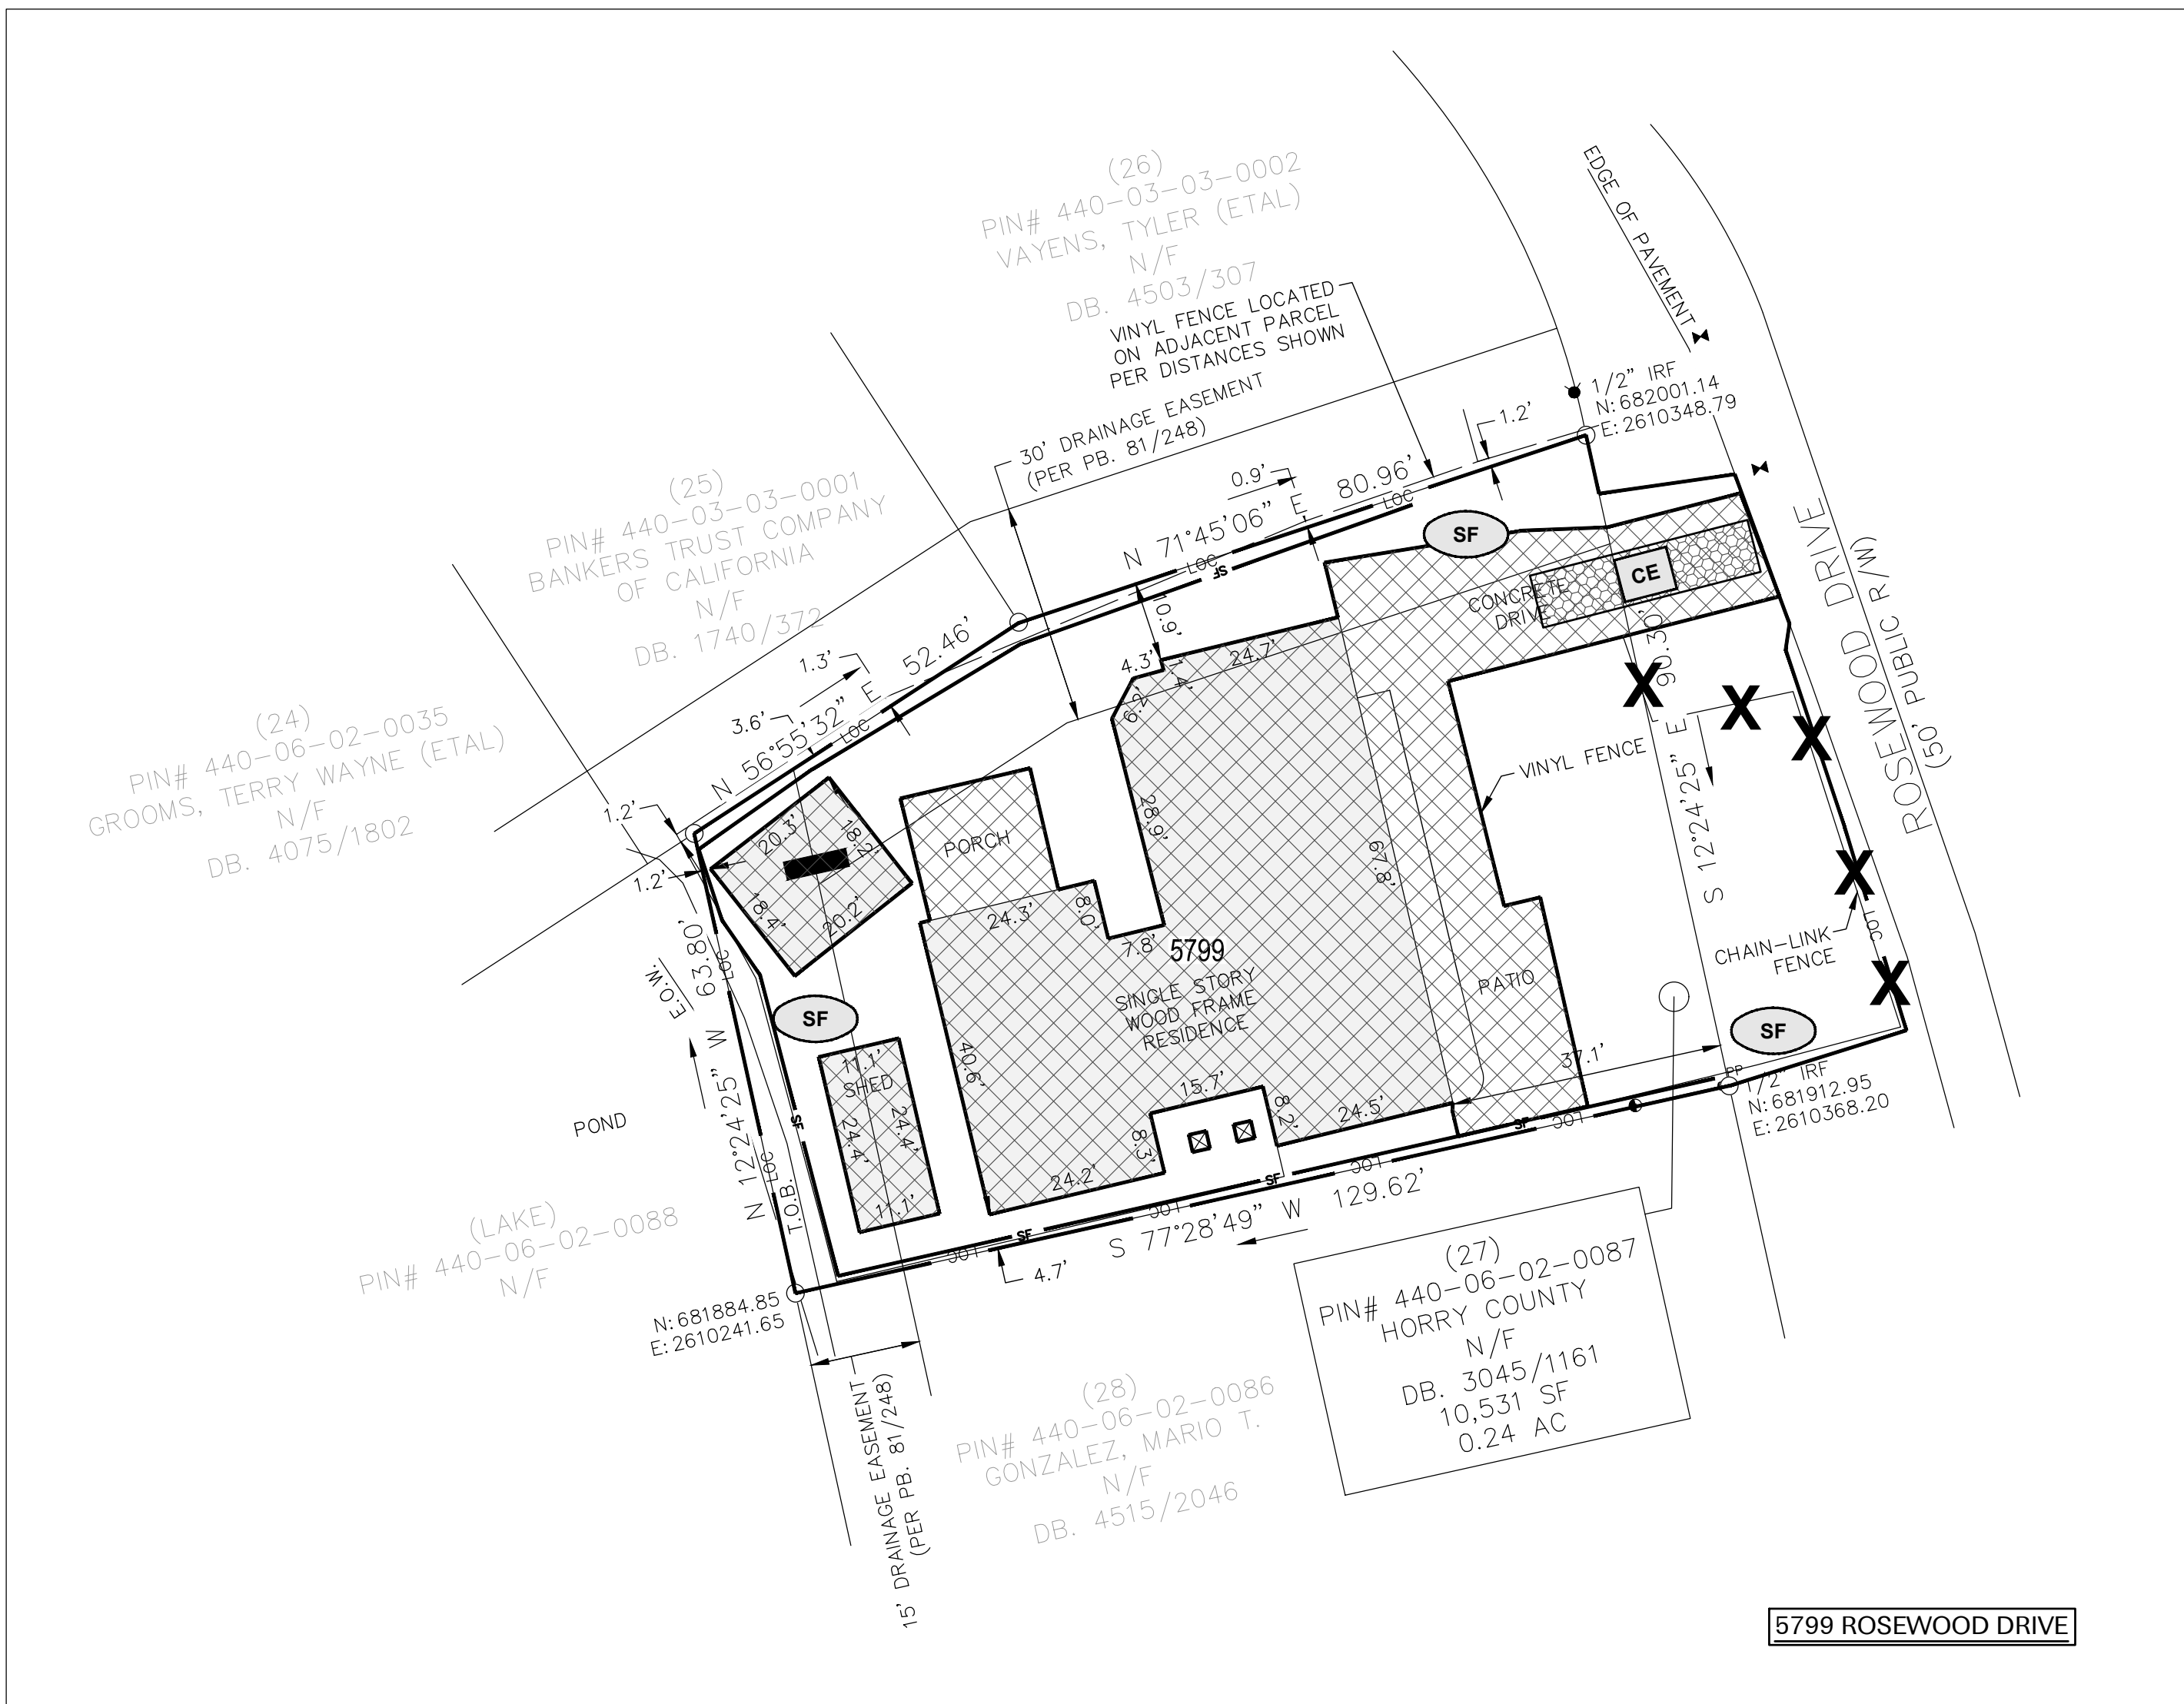

LEGEND

- LOC LIMITS OF DISTURBANCE
- SF SILT FENCE
- CE TEMPORARY CONSTRUCTION ENTRANCE/EXIT
- IPa INLET PROTECTION DET. A
- IPe INLET PROTECTION DET. E
- SEDIMENT TUBES
- X ITEMS TO BE DEMOLISHED
- GENERAL DEMOLITION AREA

20 0 20 40 60
scale in feet
1" = 20'

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**HORRY COUNTY BUYOUT
DEMOLITION PLAN - PHASE 2S**




SOUTH CAROLINA OFFICE OF RESILIENCE
HORRY COUNTY, SOUTH CAROLINA

Revisions	No.	Name	Date

Drawing Information	
Project No. 230-N027-M	
Drawn by	
Date	
Checked by	
Date	
Approved by	
Date	

DEMOLITION PLAN - PHASE 2

Drawing No. **C3.6**

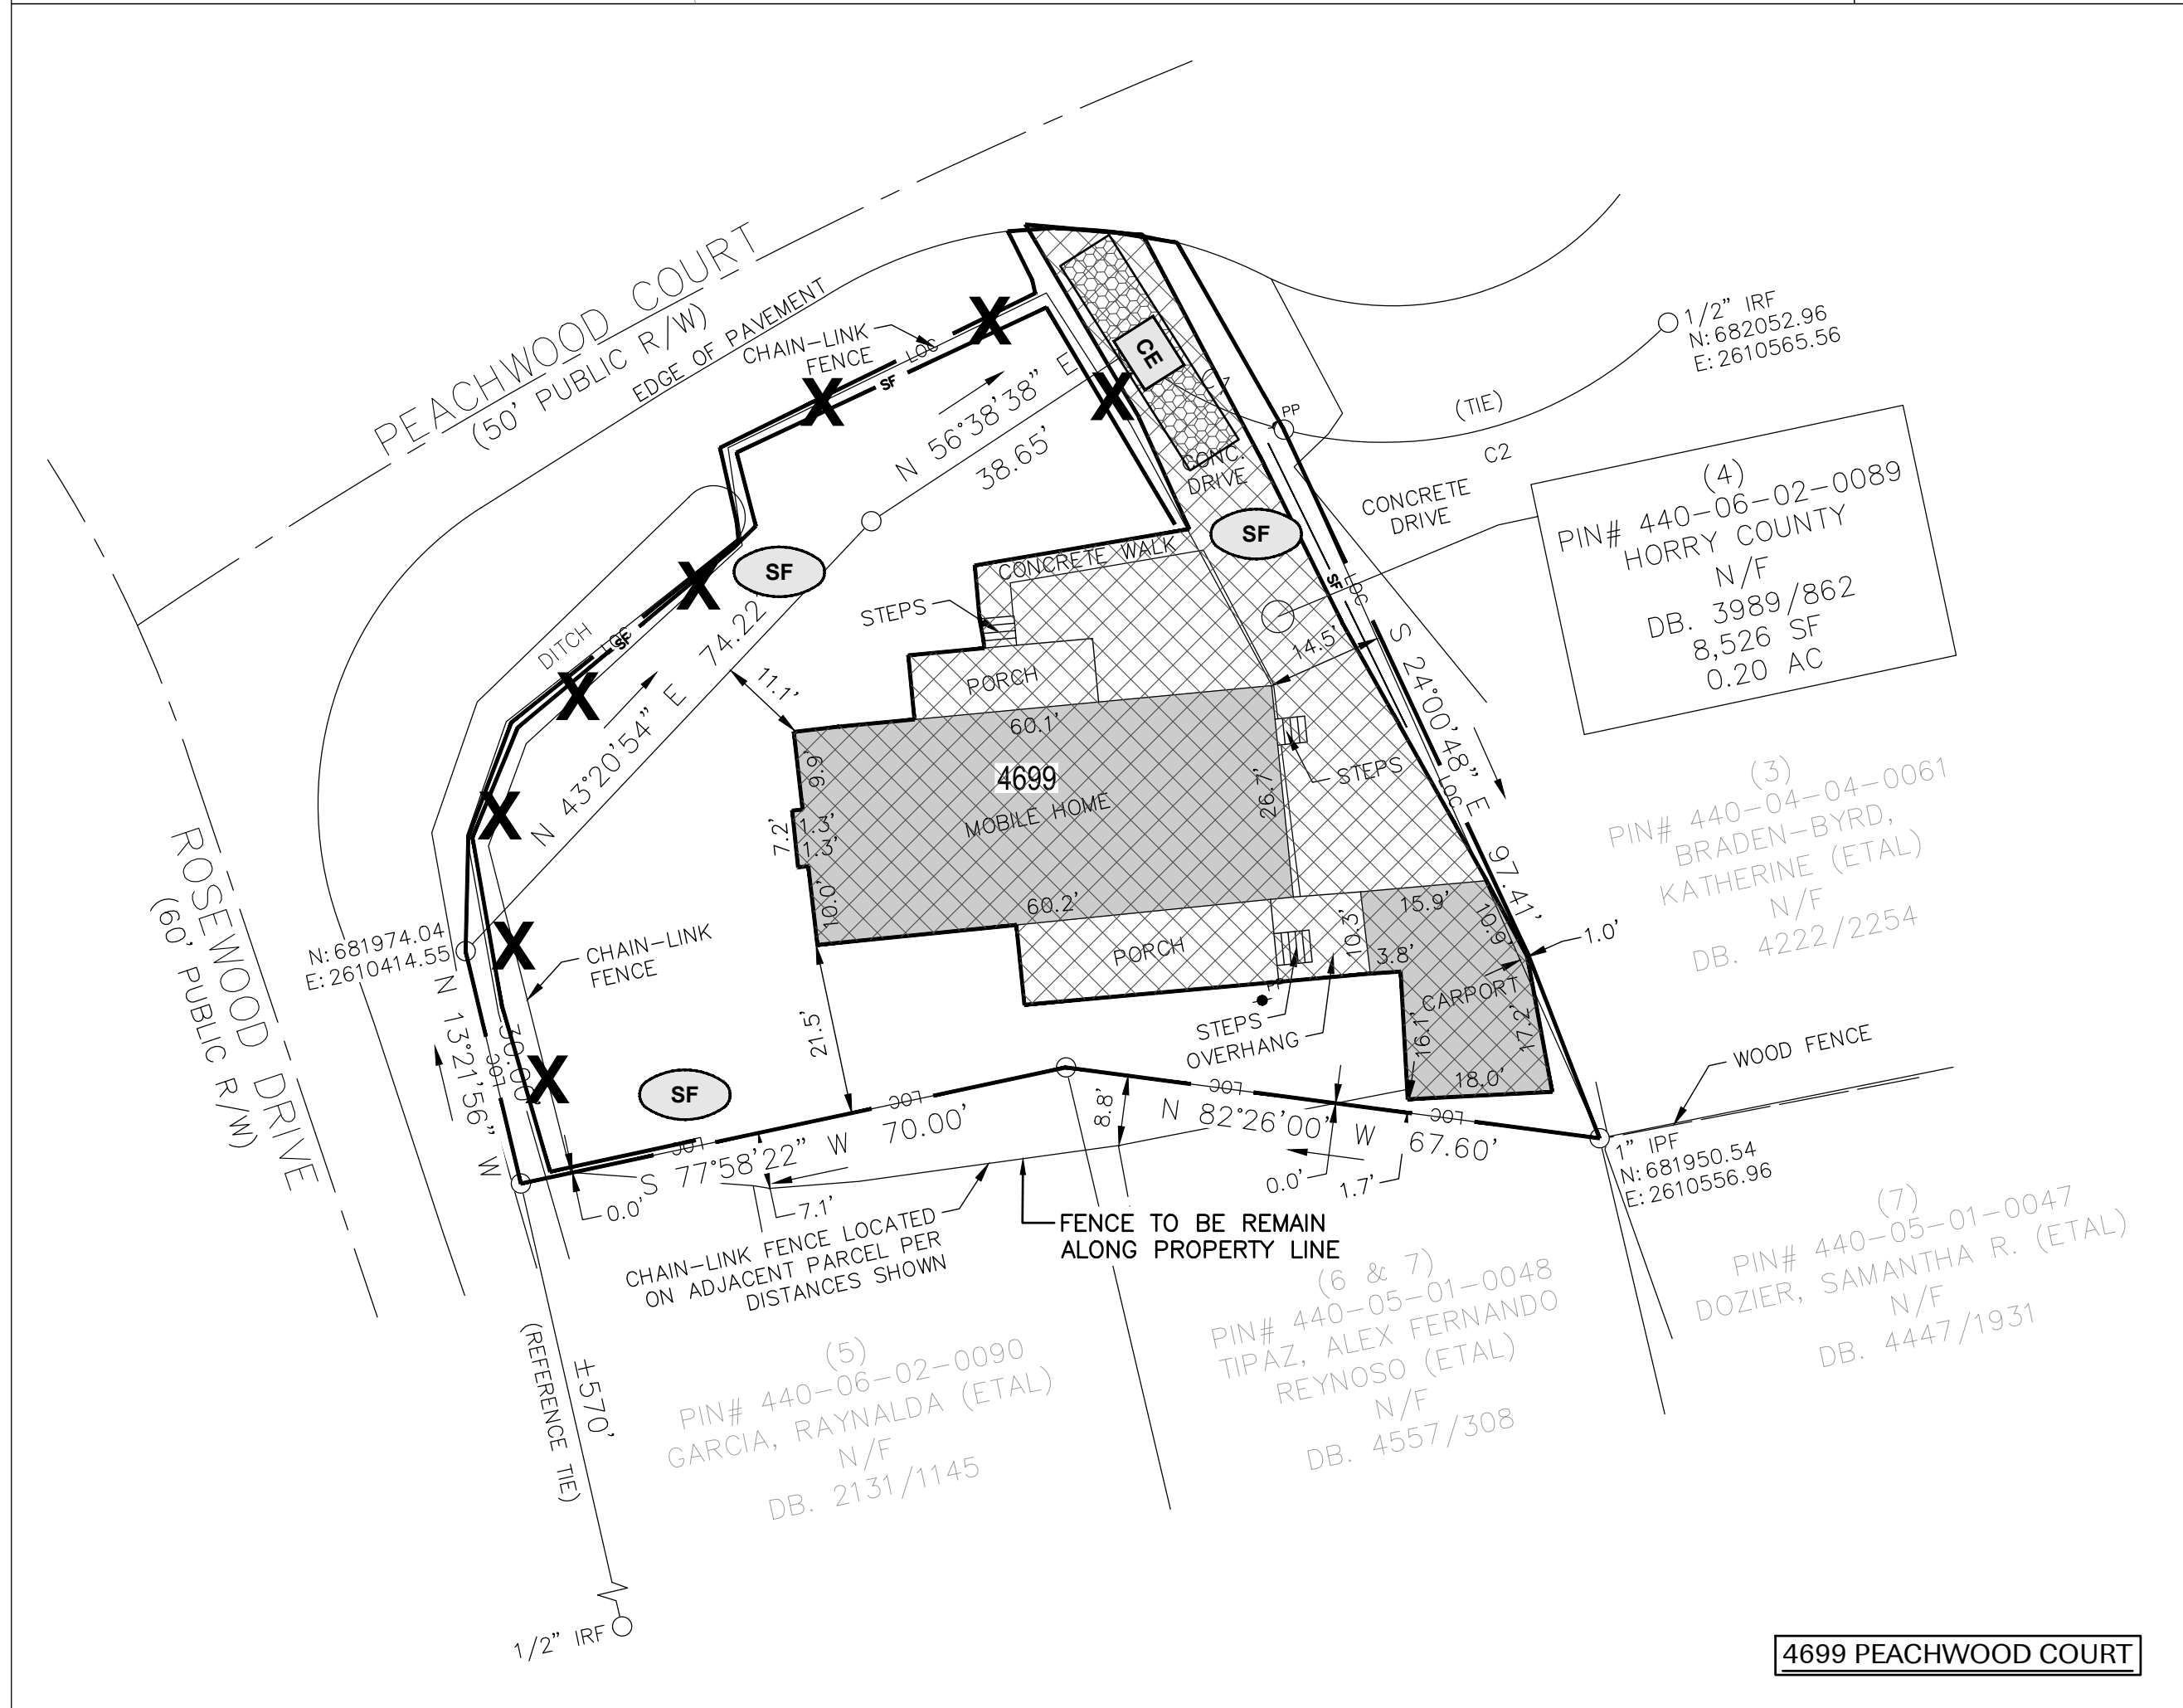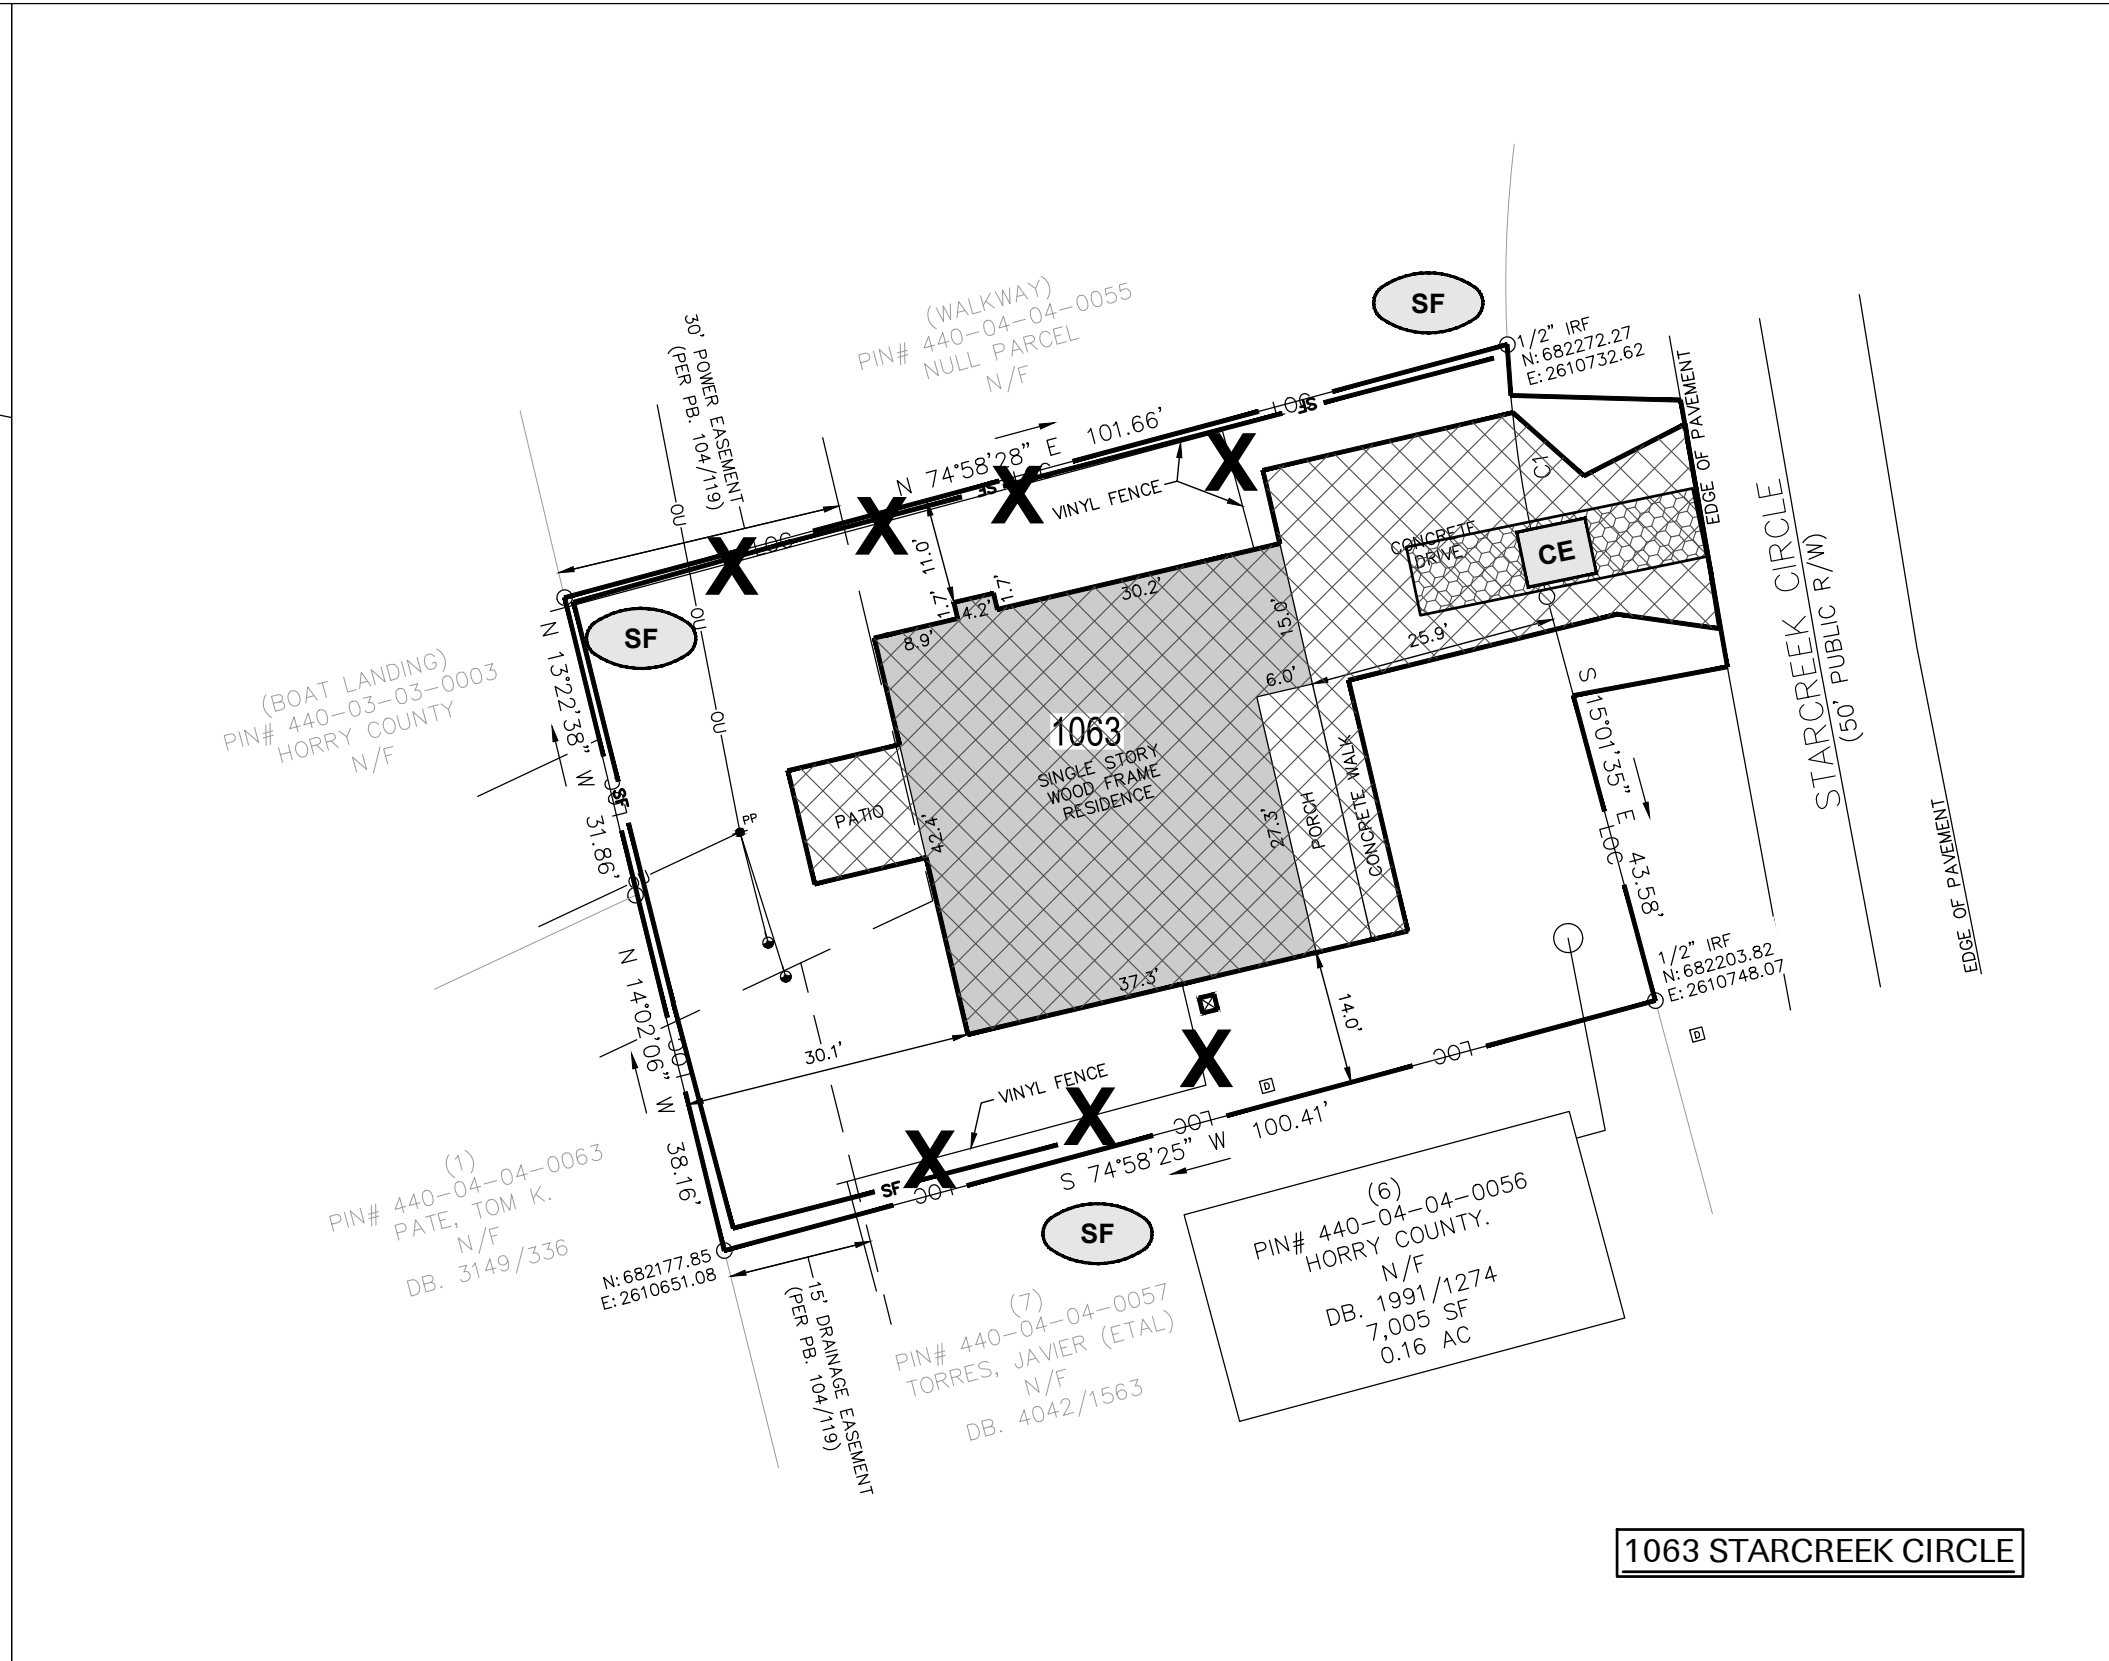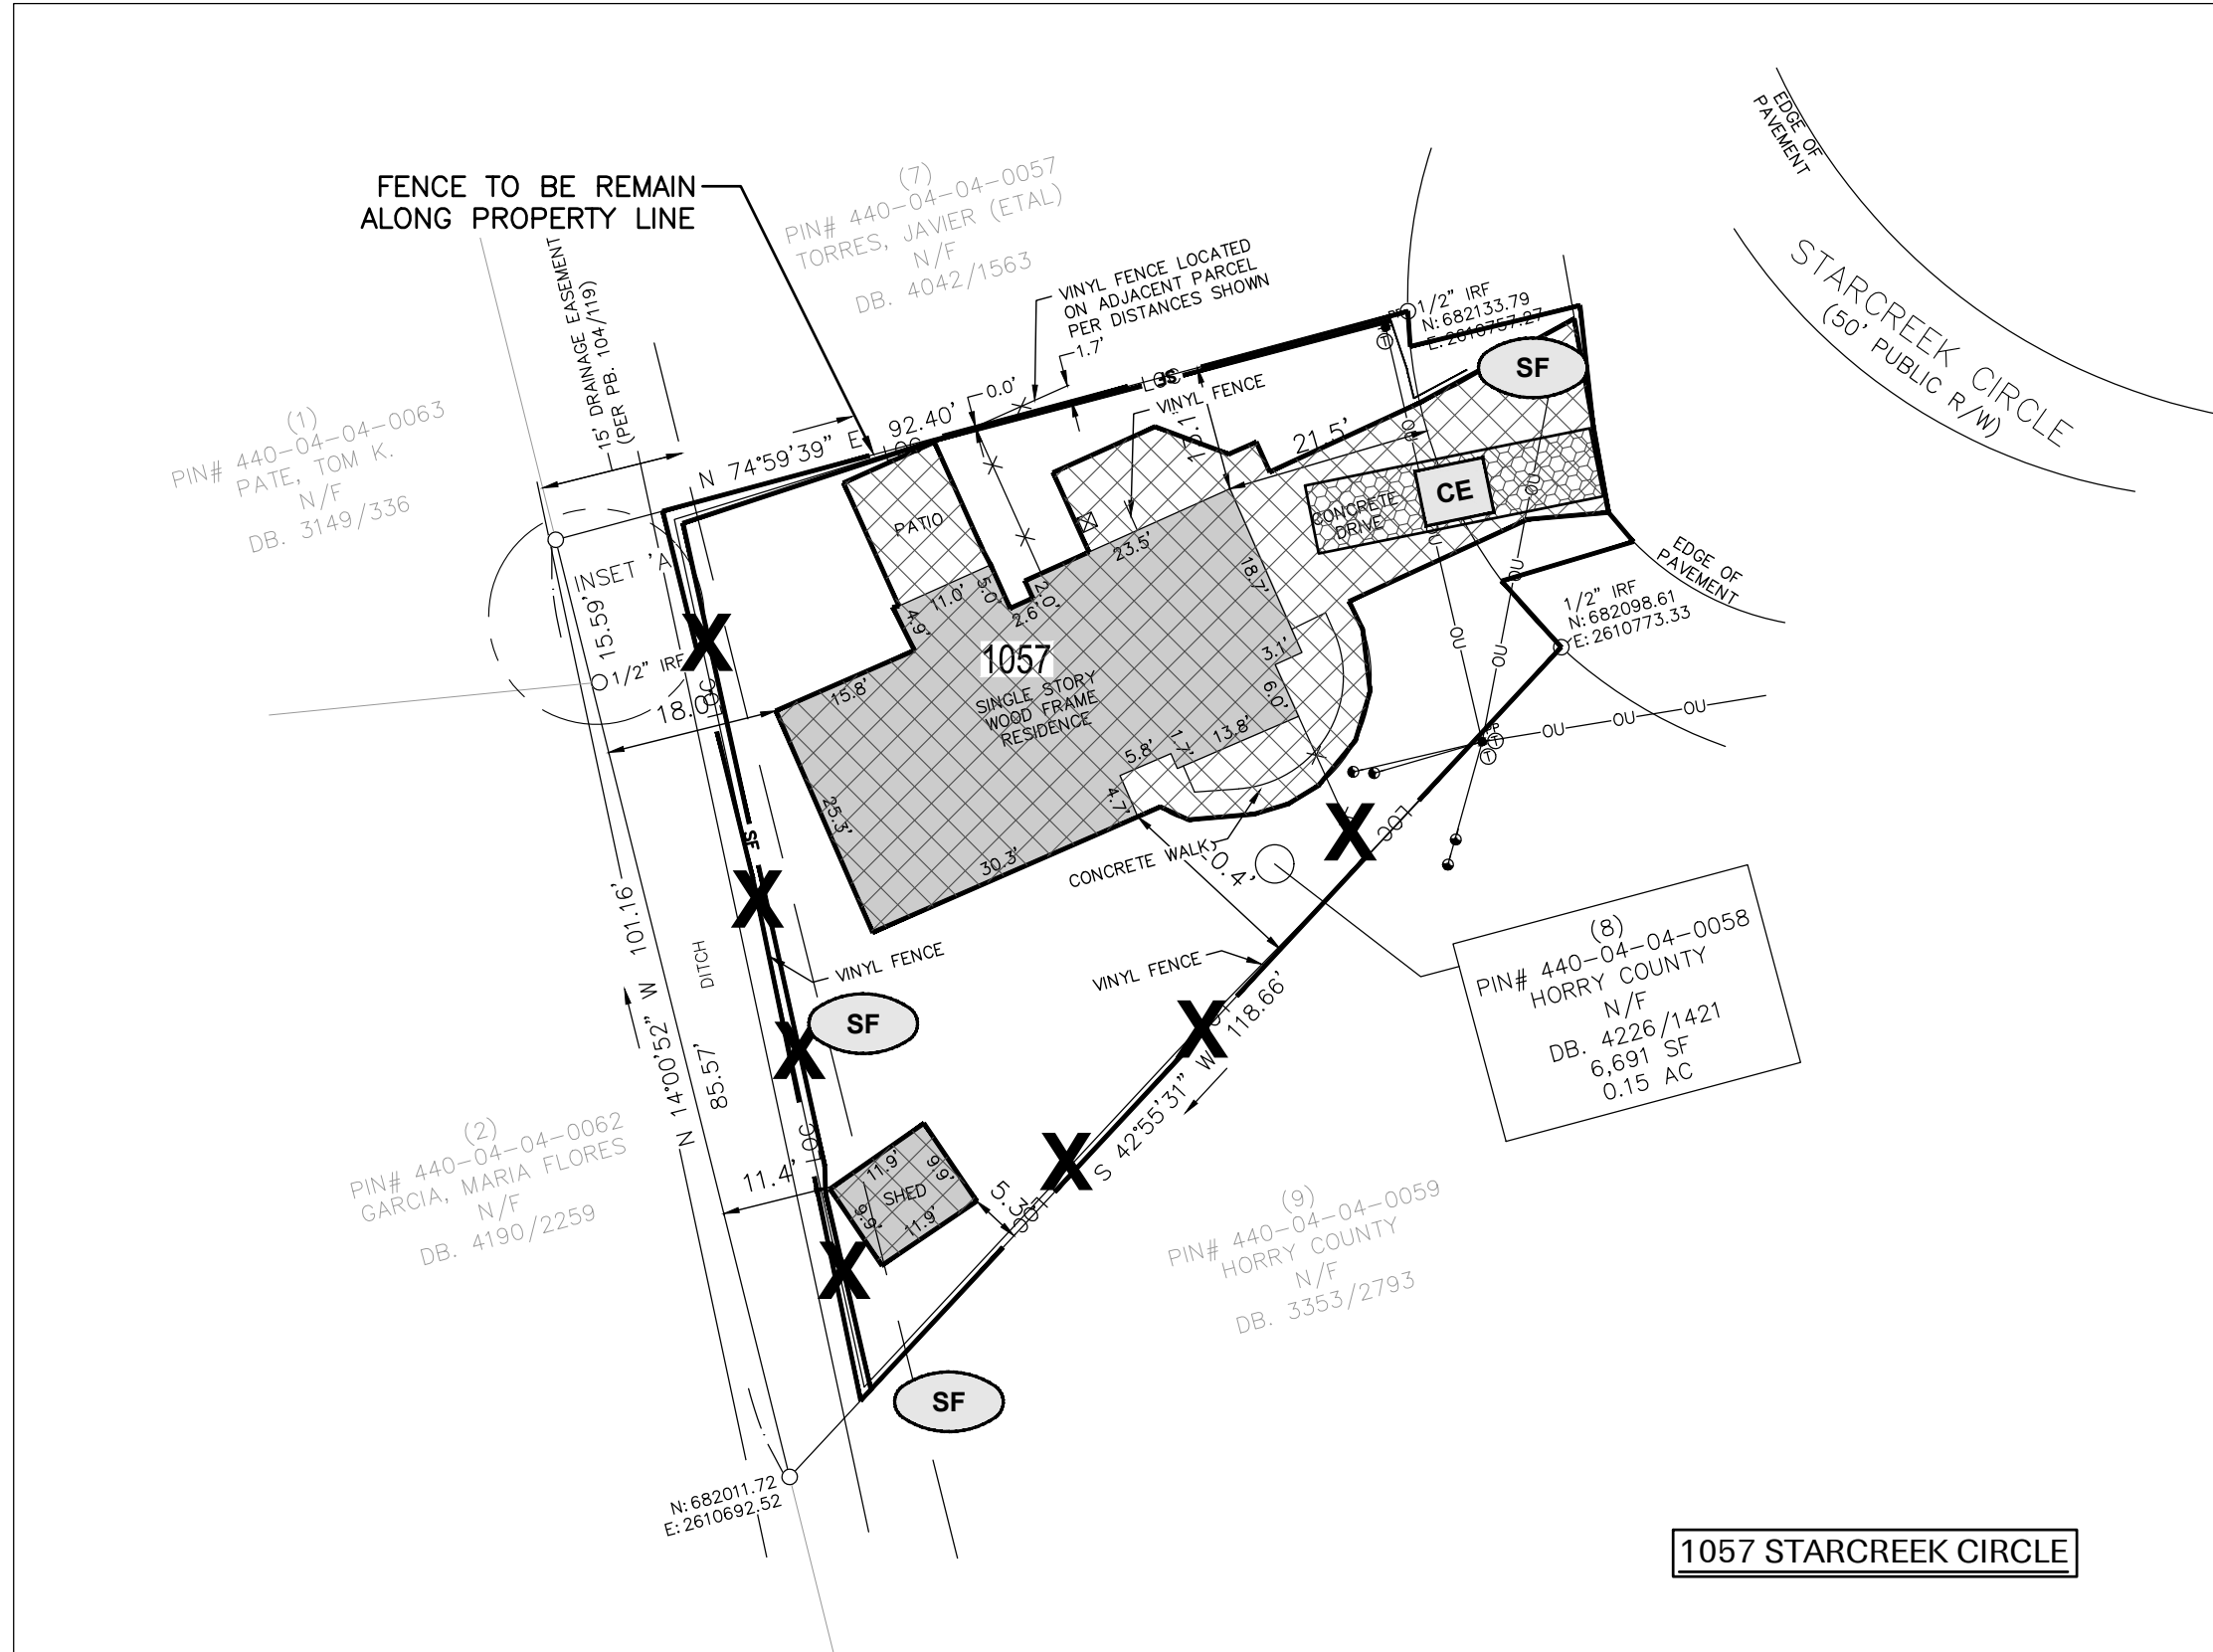

LEGEND

— LOC — LIMITS OF DISTURBANCE

— SF — SILT FENCE (SF)

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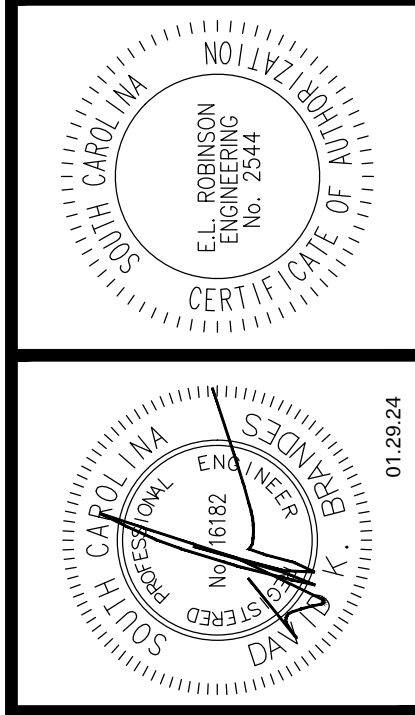
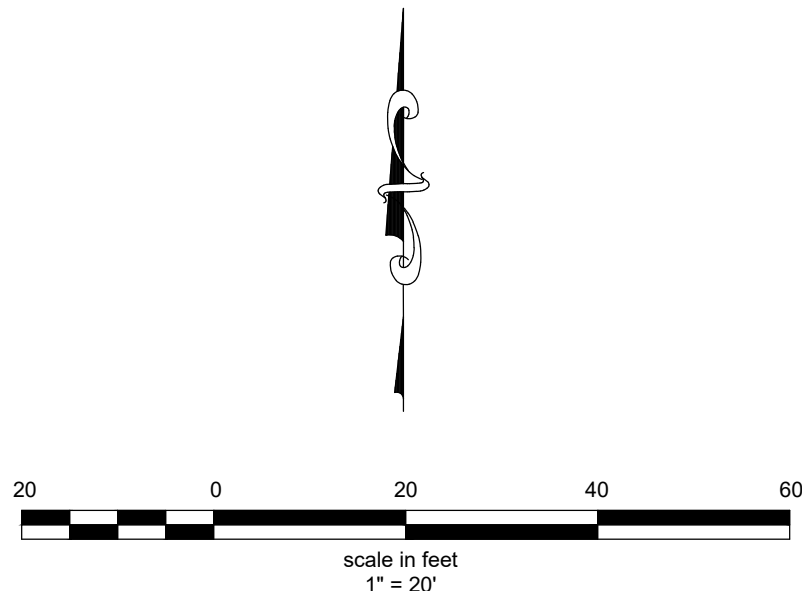
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SEDIMENT TUBES

X ITEMS TO BE DEMOLISHED





GENERAL DEMOLITION AREA




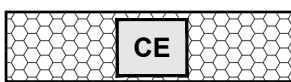




**HORRY COUNTY BUYOUT
DEMOLITION PLAN - PHASE 2S**

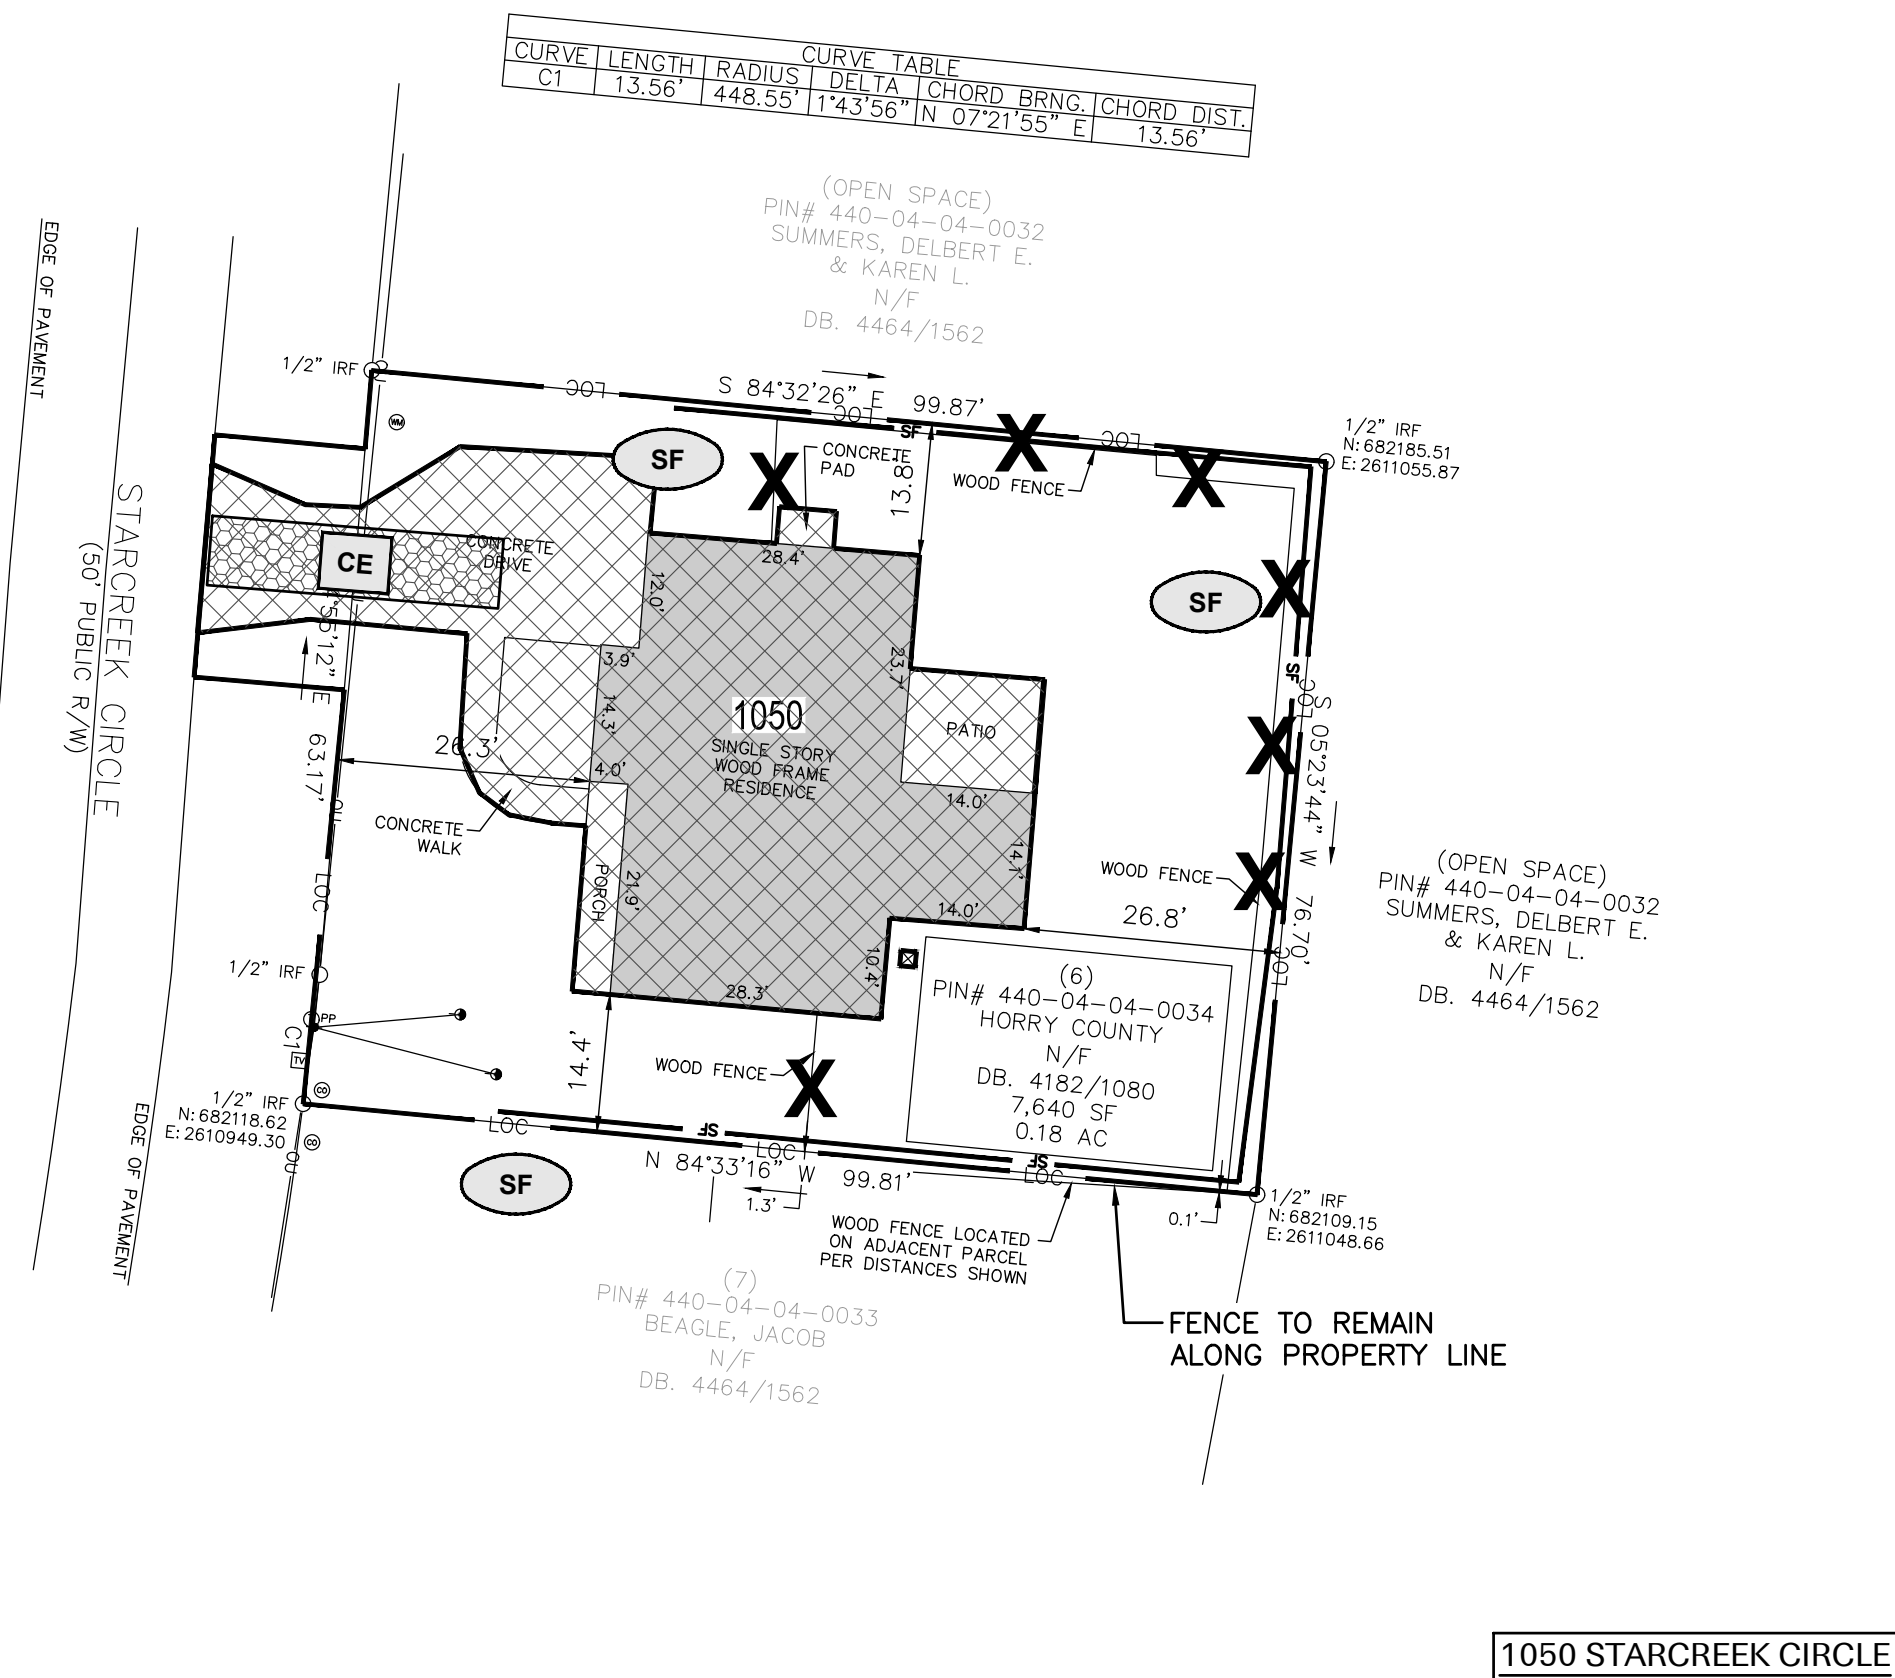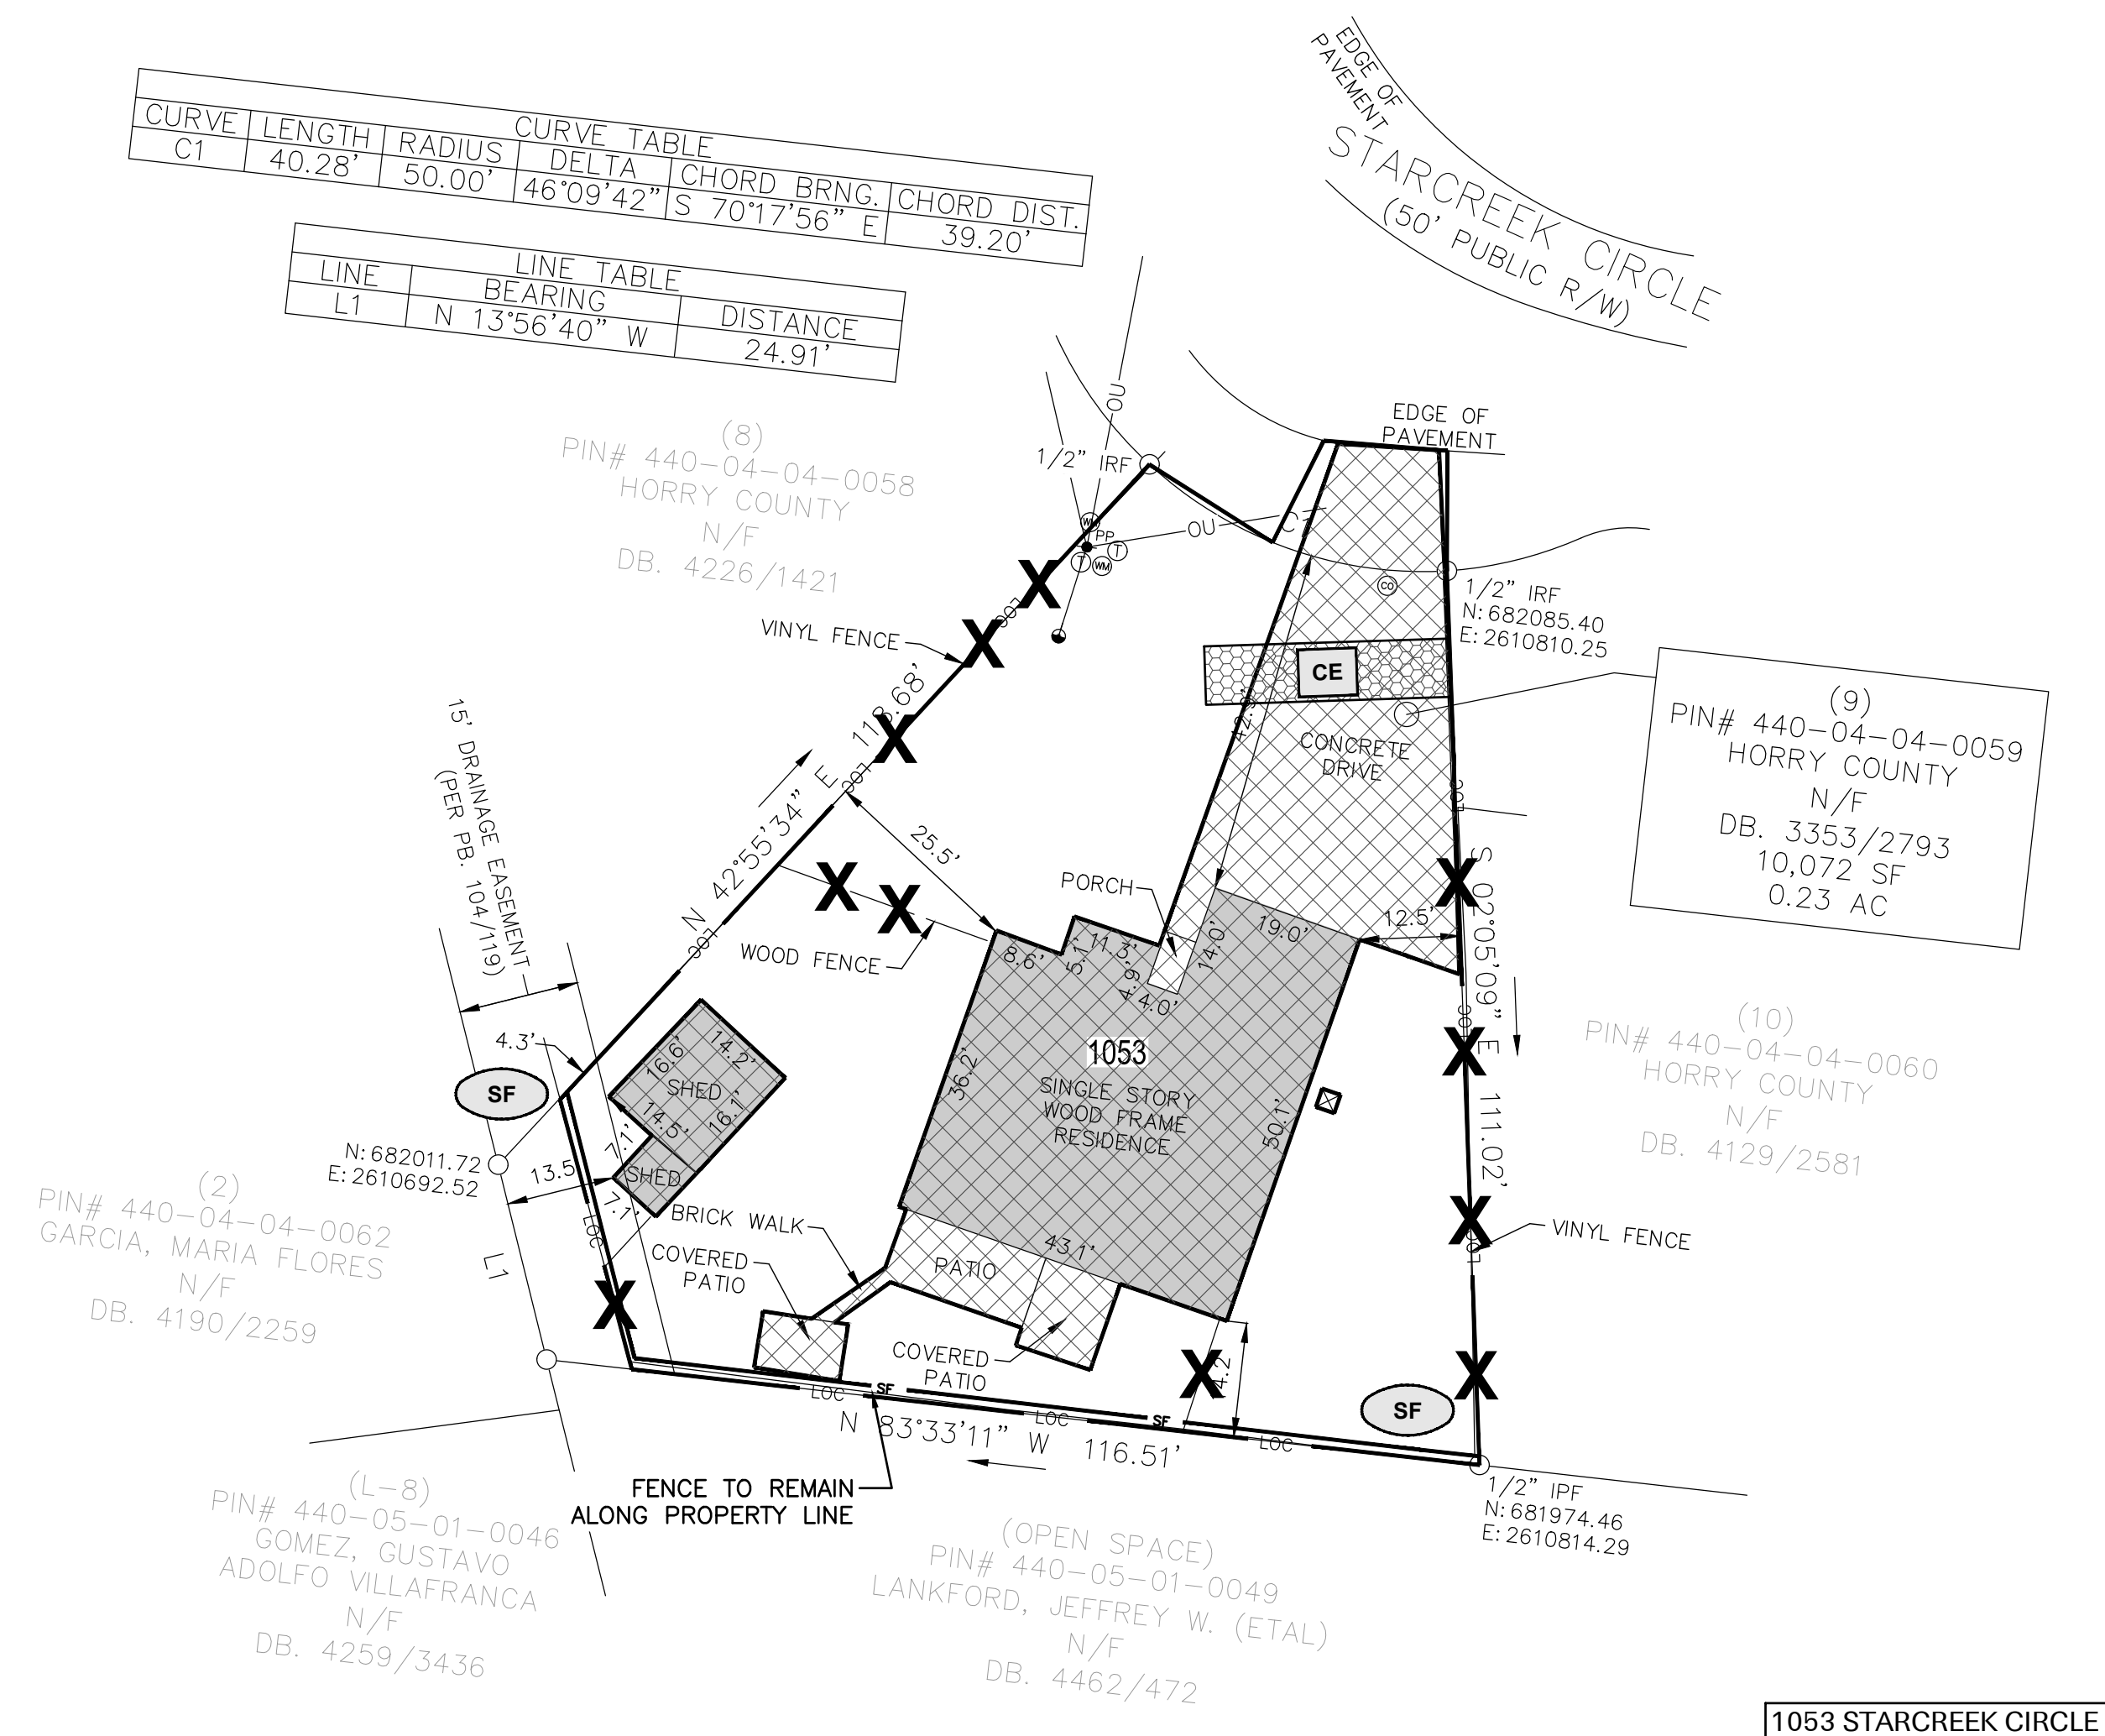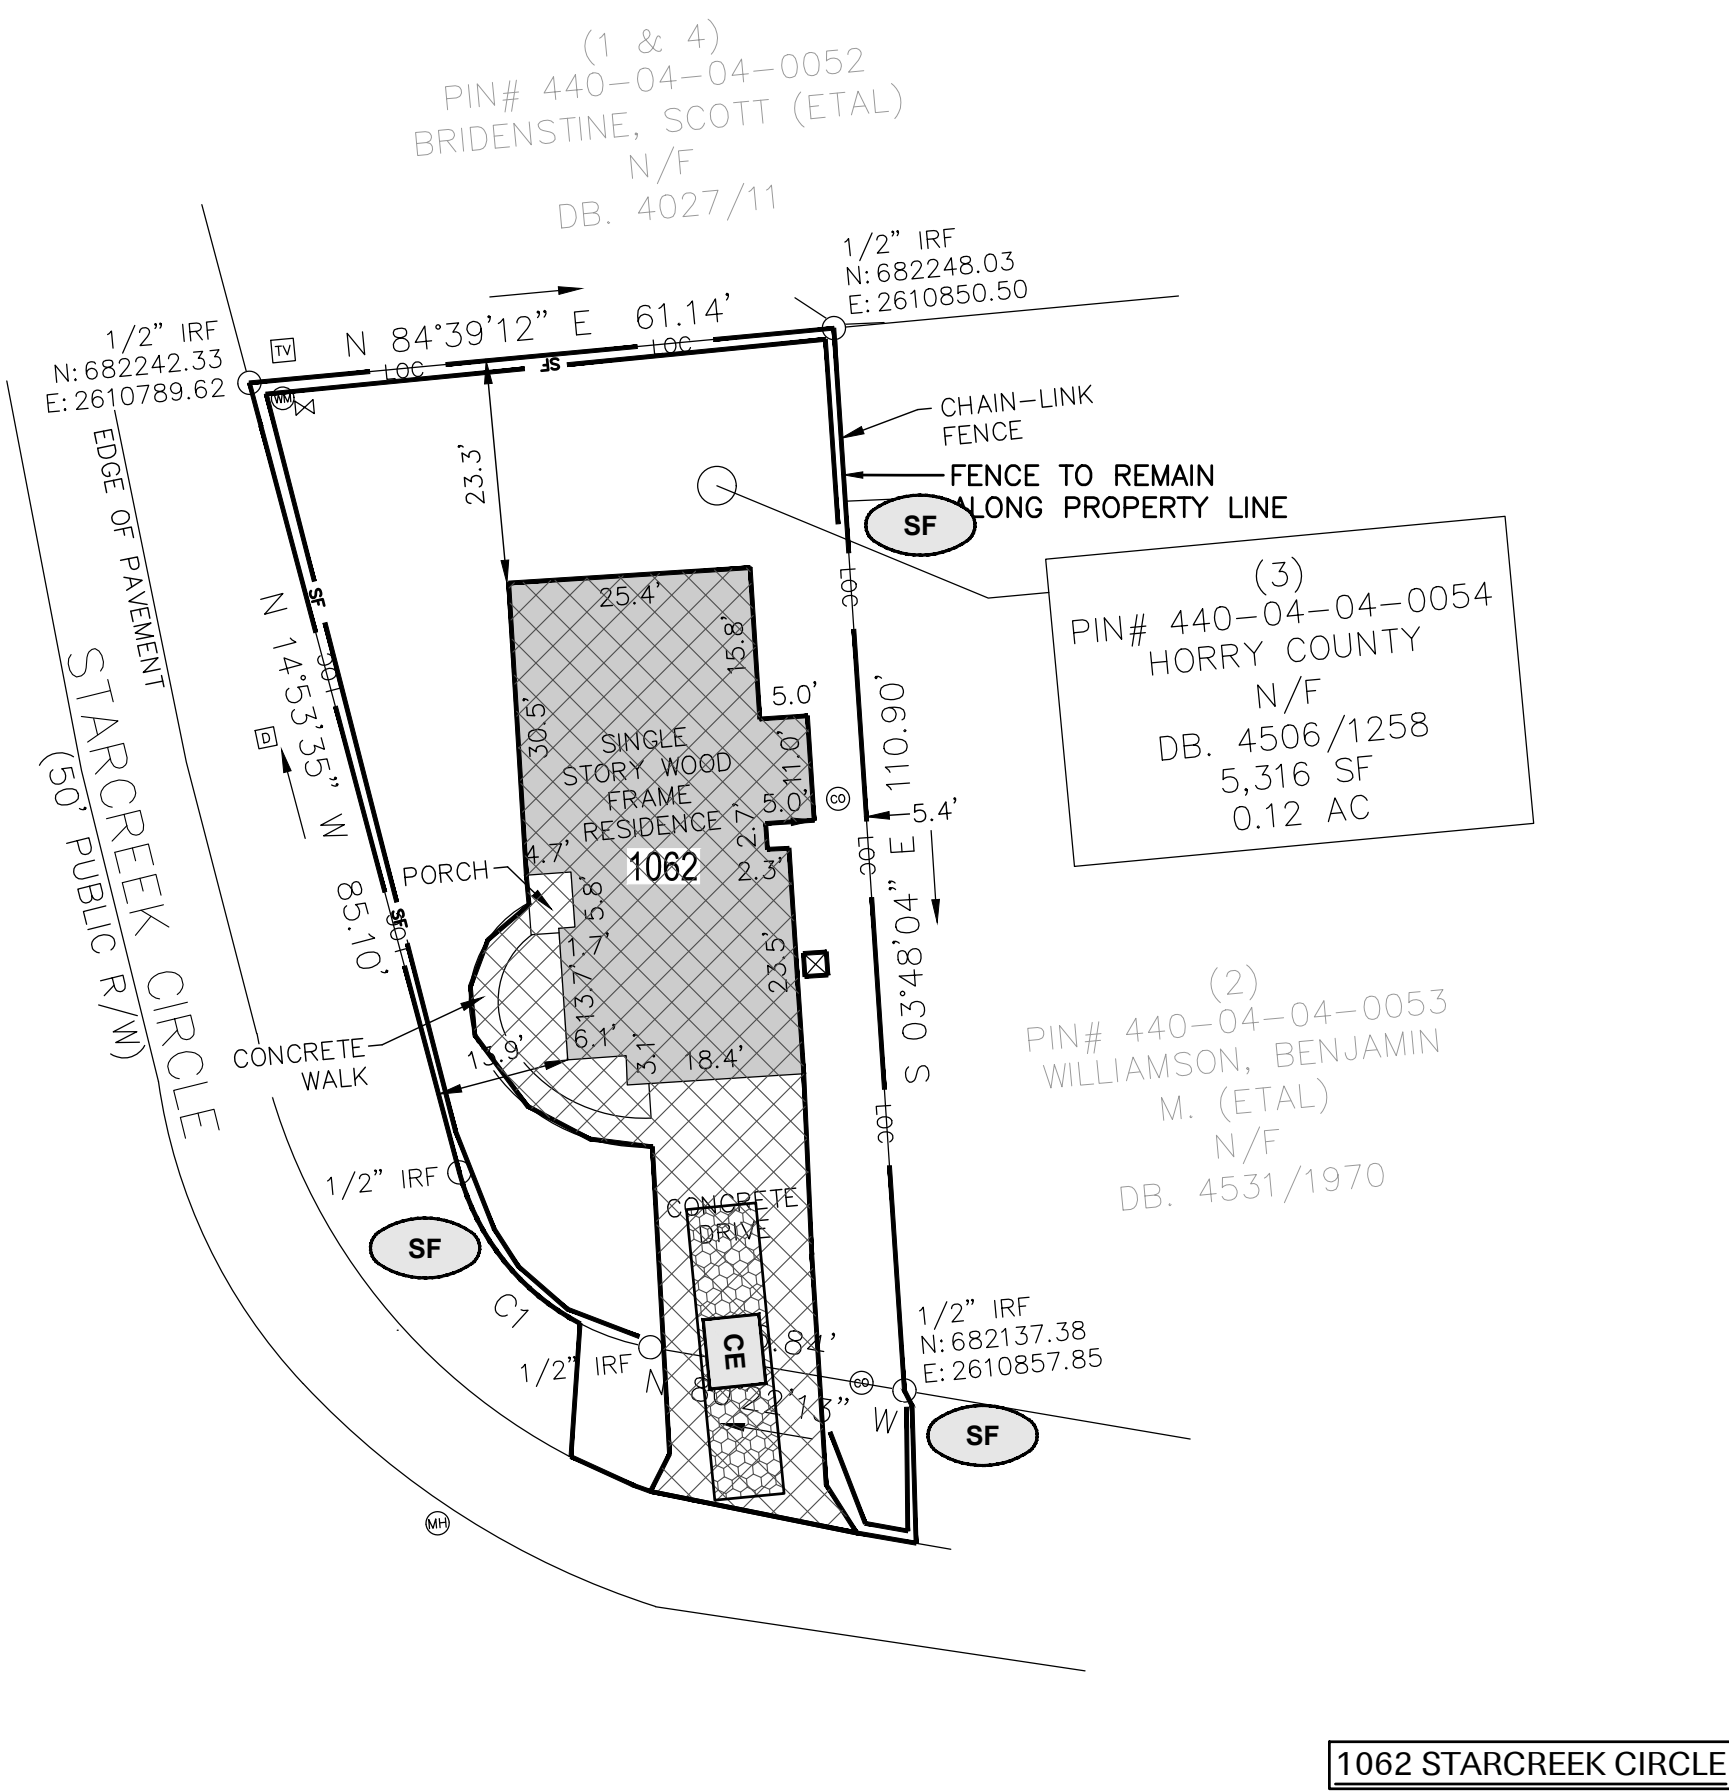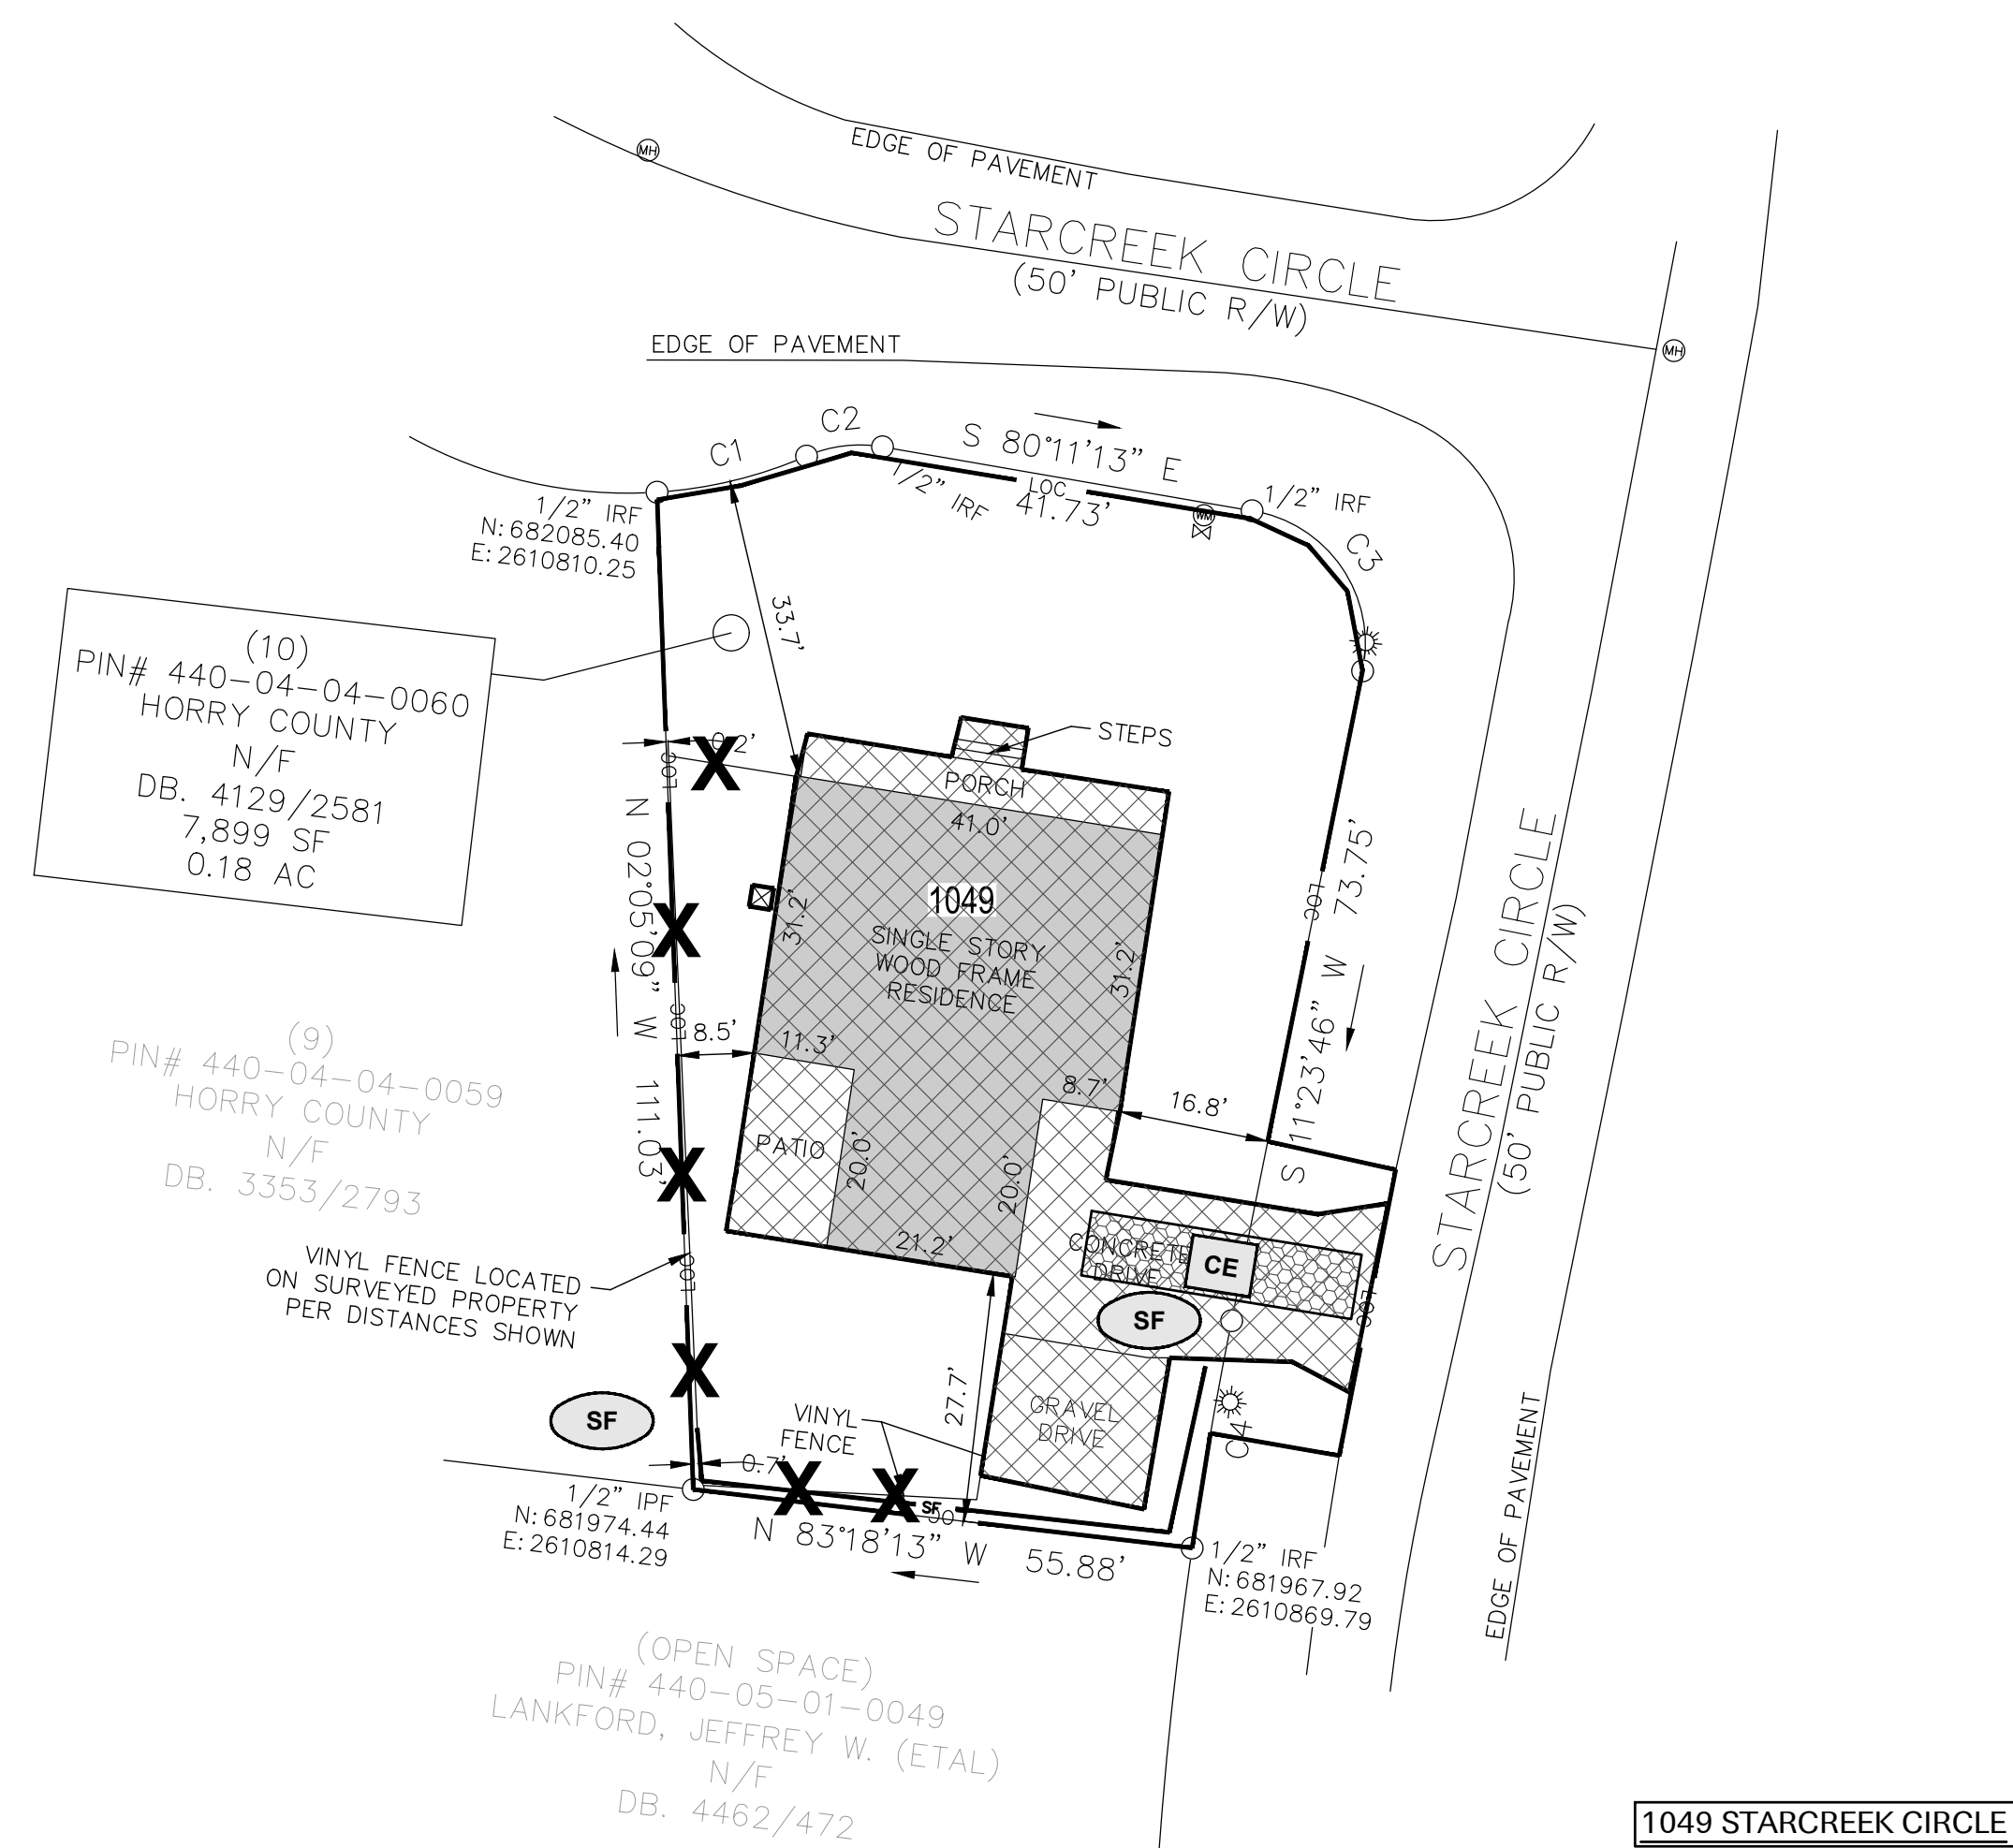
SOUTH CAROLINA OFFICE OF RESILIENCE
HORRY COUNTY, SOUTH CAROLINA





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	No.	Date	No.	Name	Project No.	Drawn By
DEMOLITION PLAN - PHASE 2					330-N027-M	Drawn By
						Date
						Checked By
						Date
						Approved By
						Date







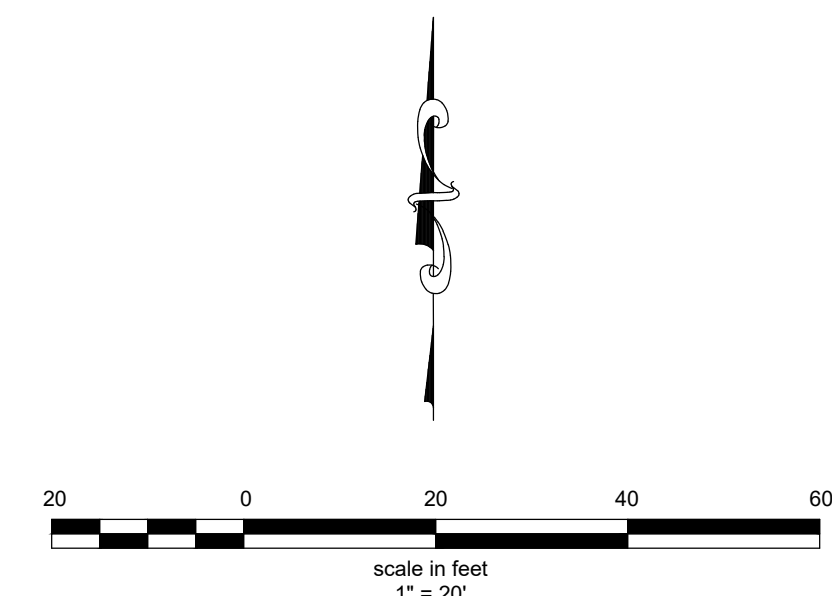

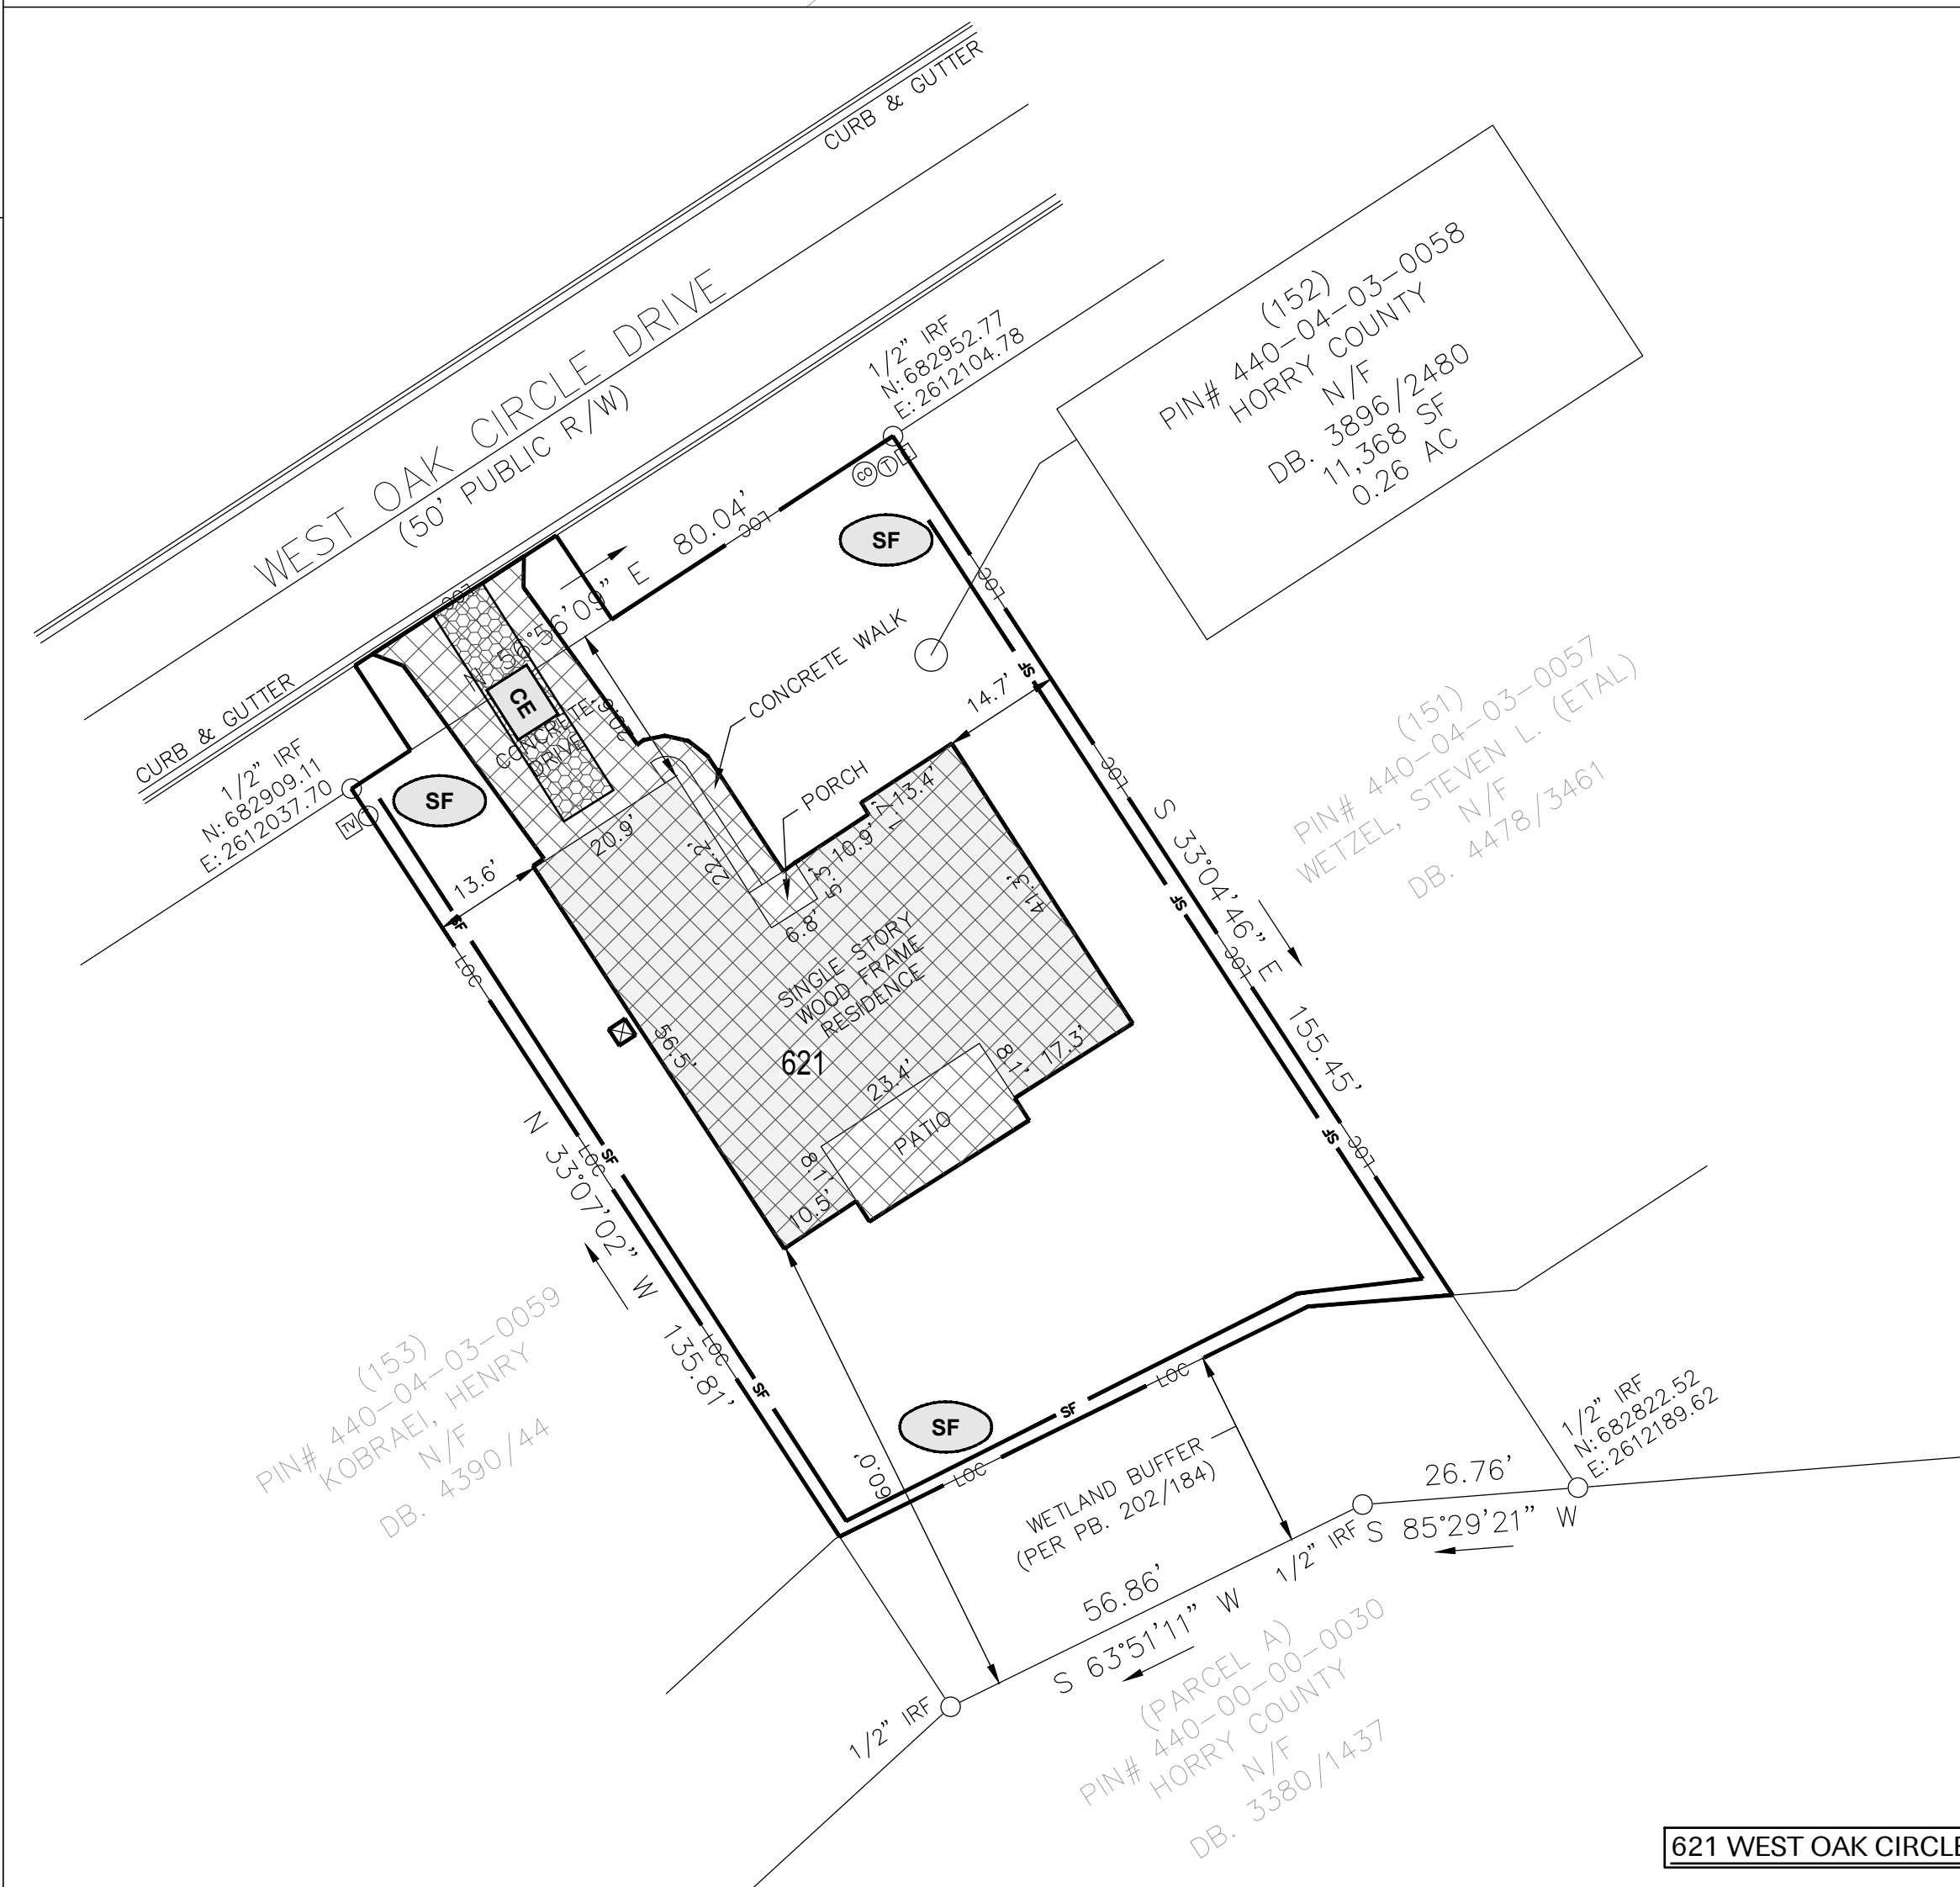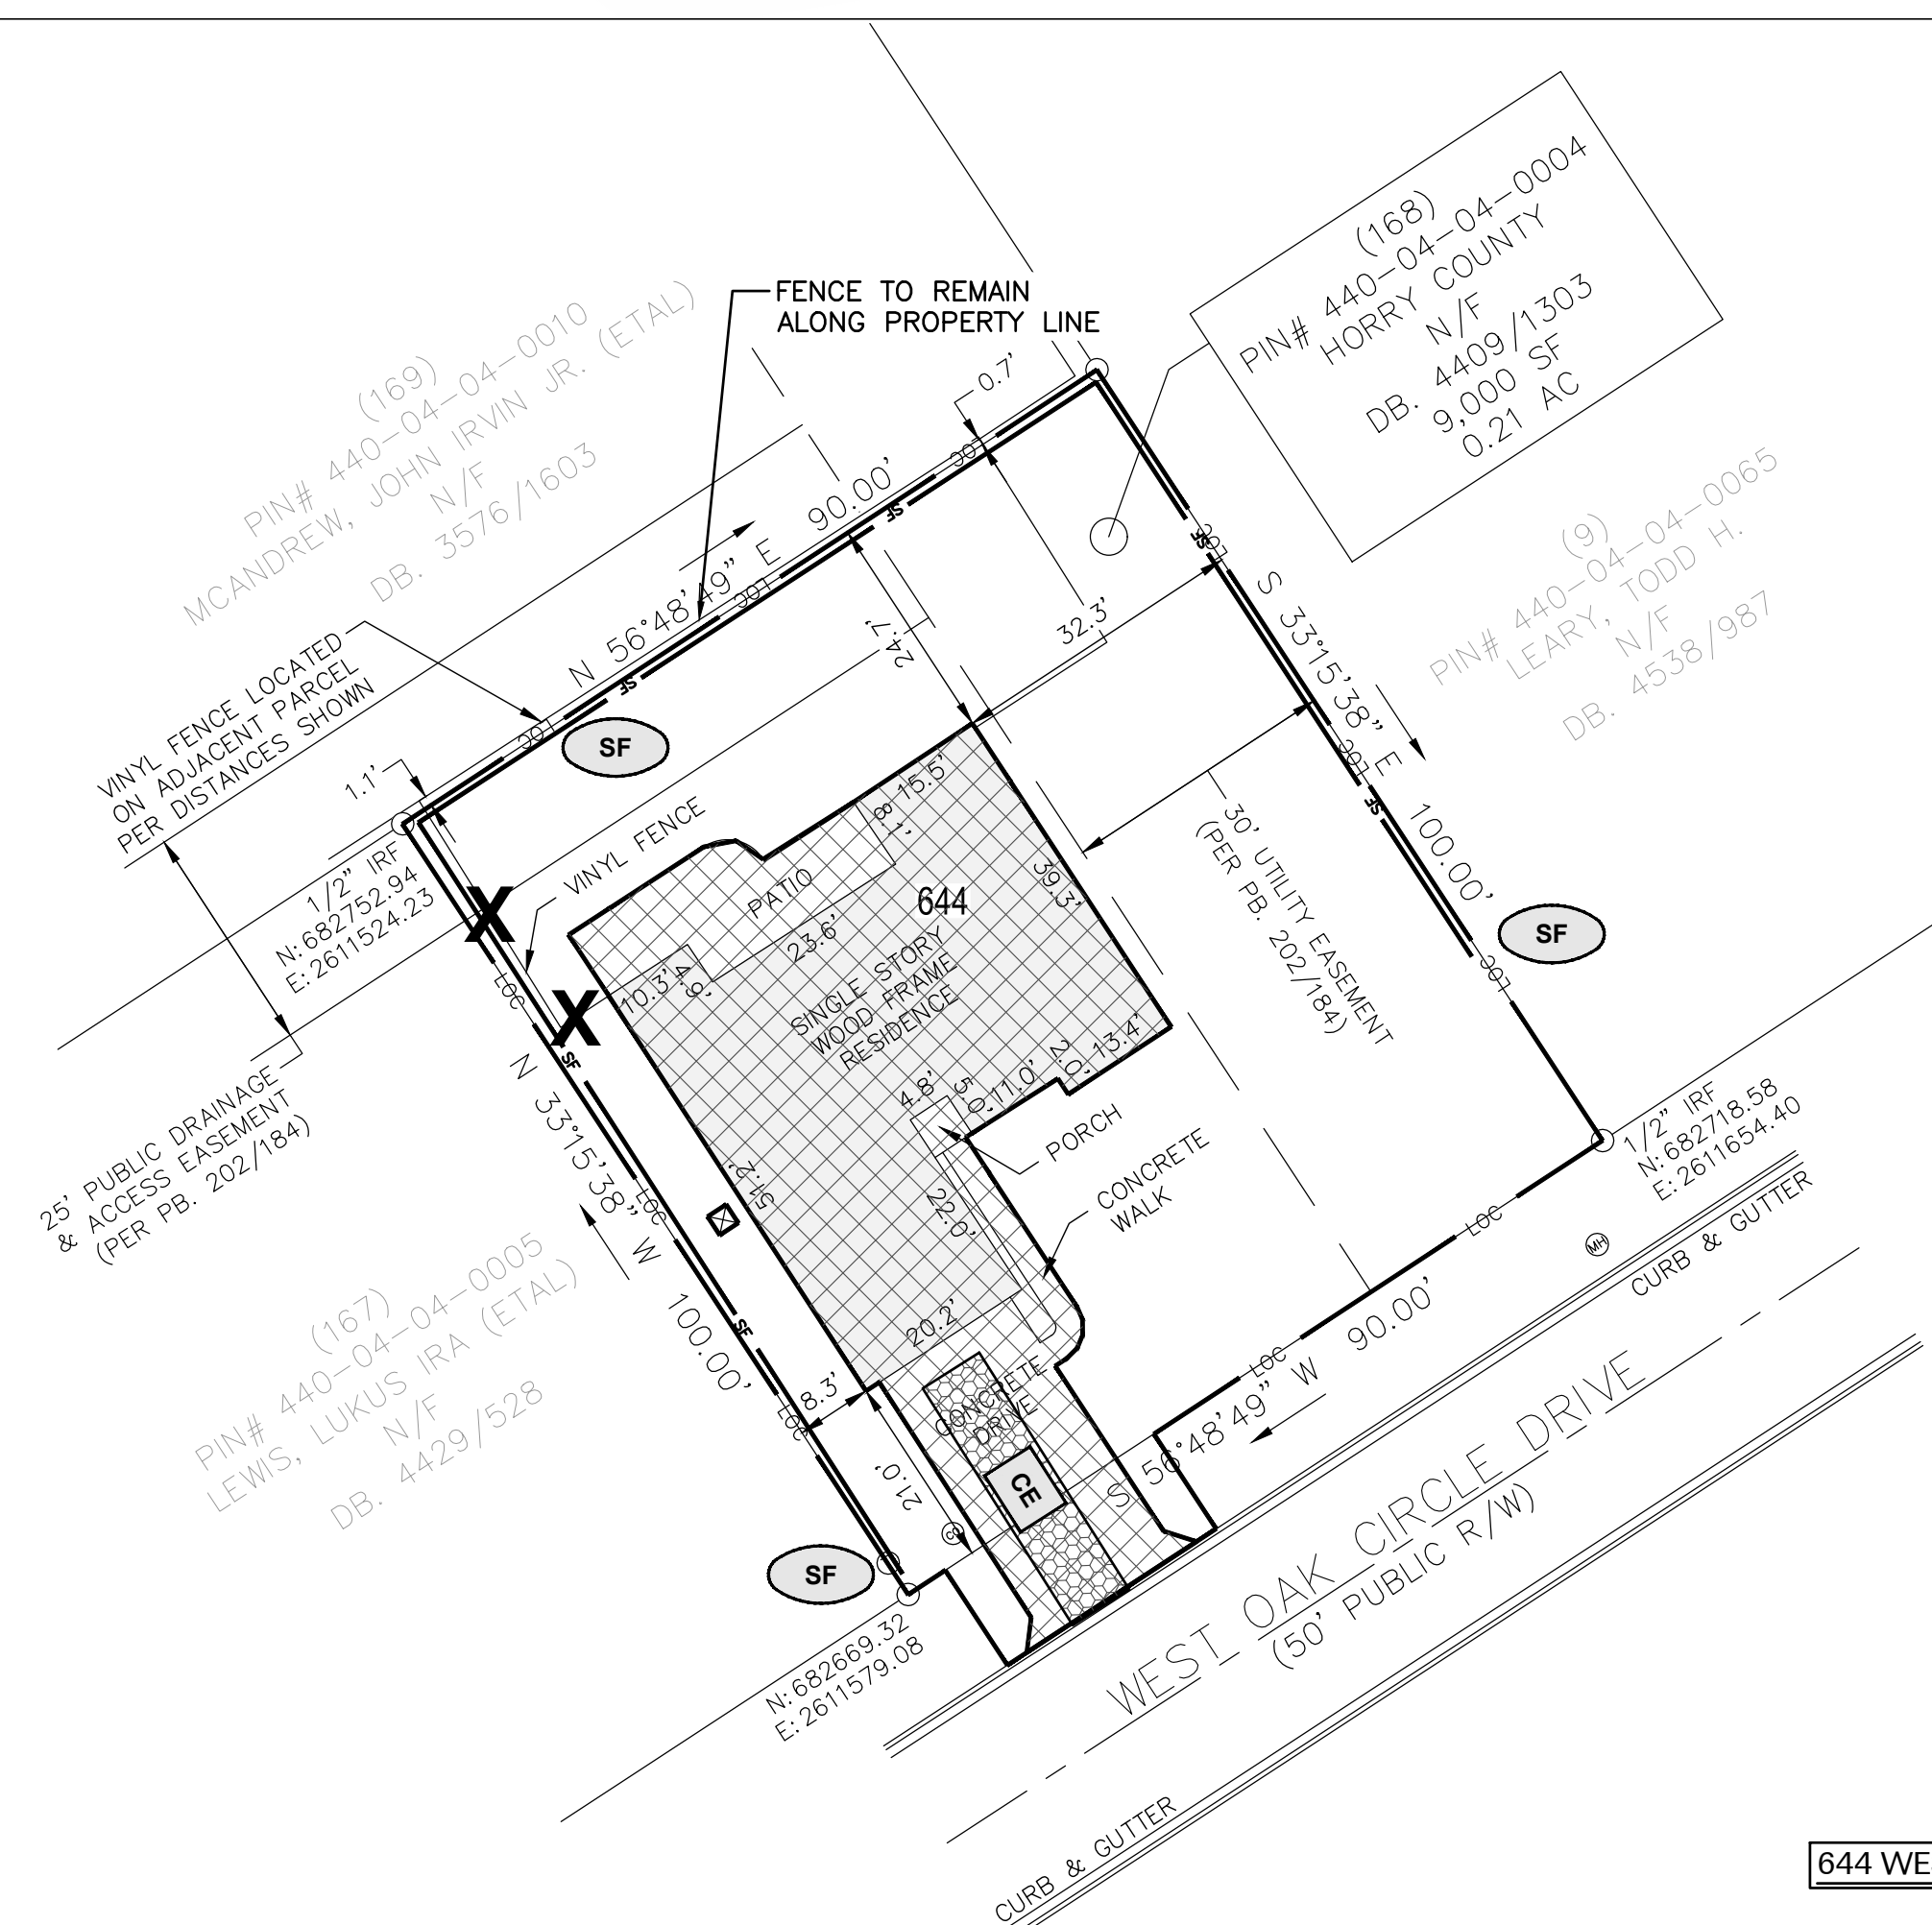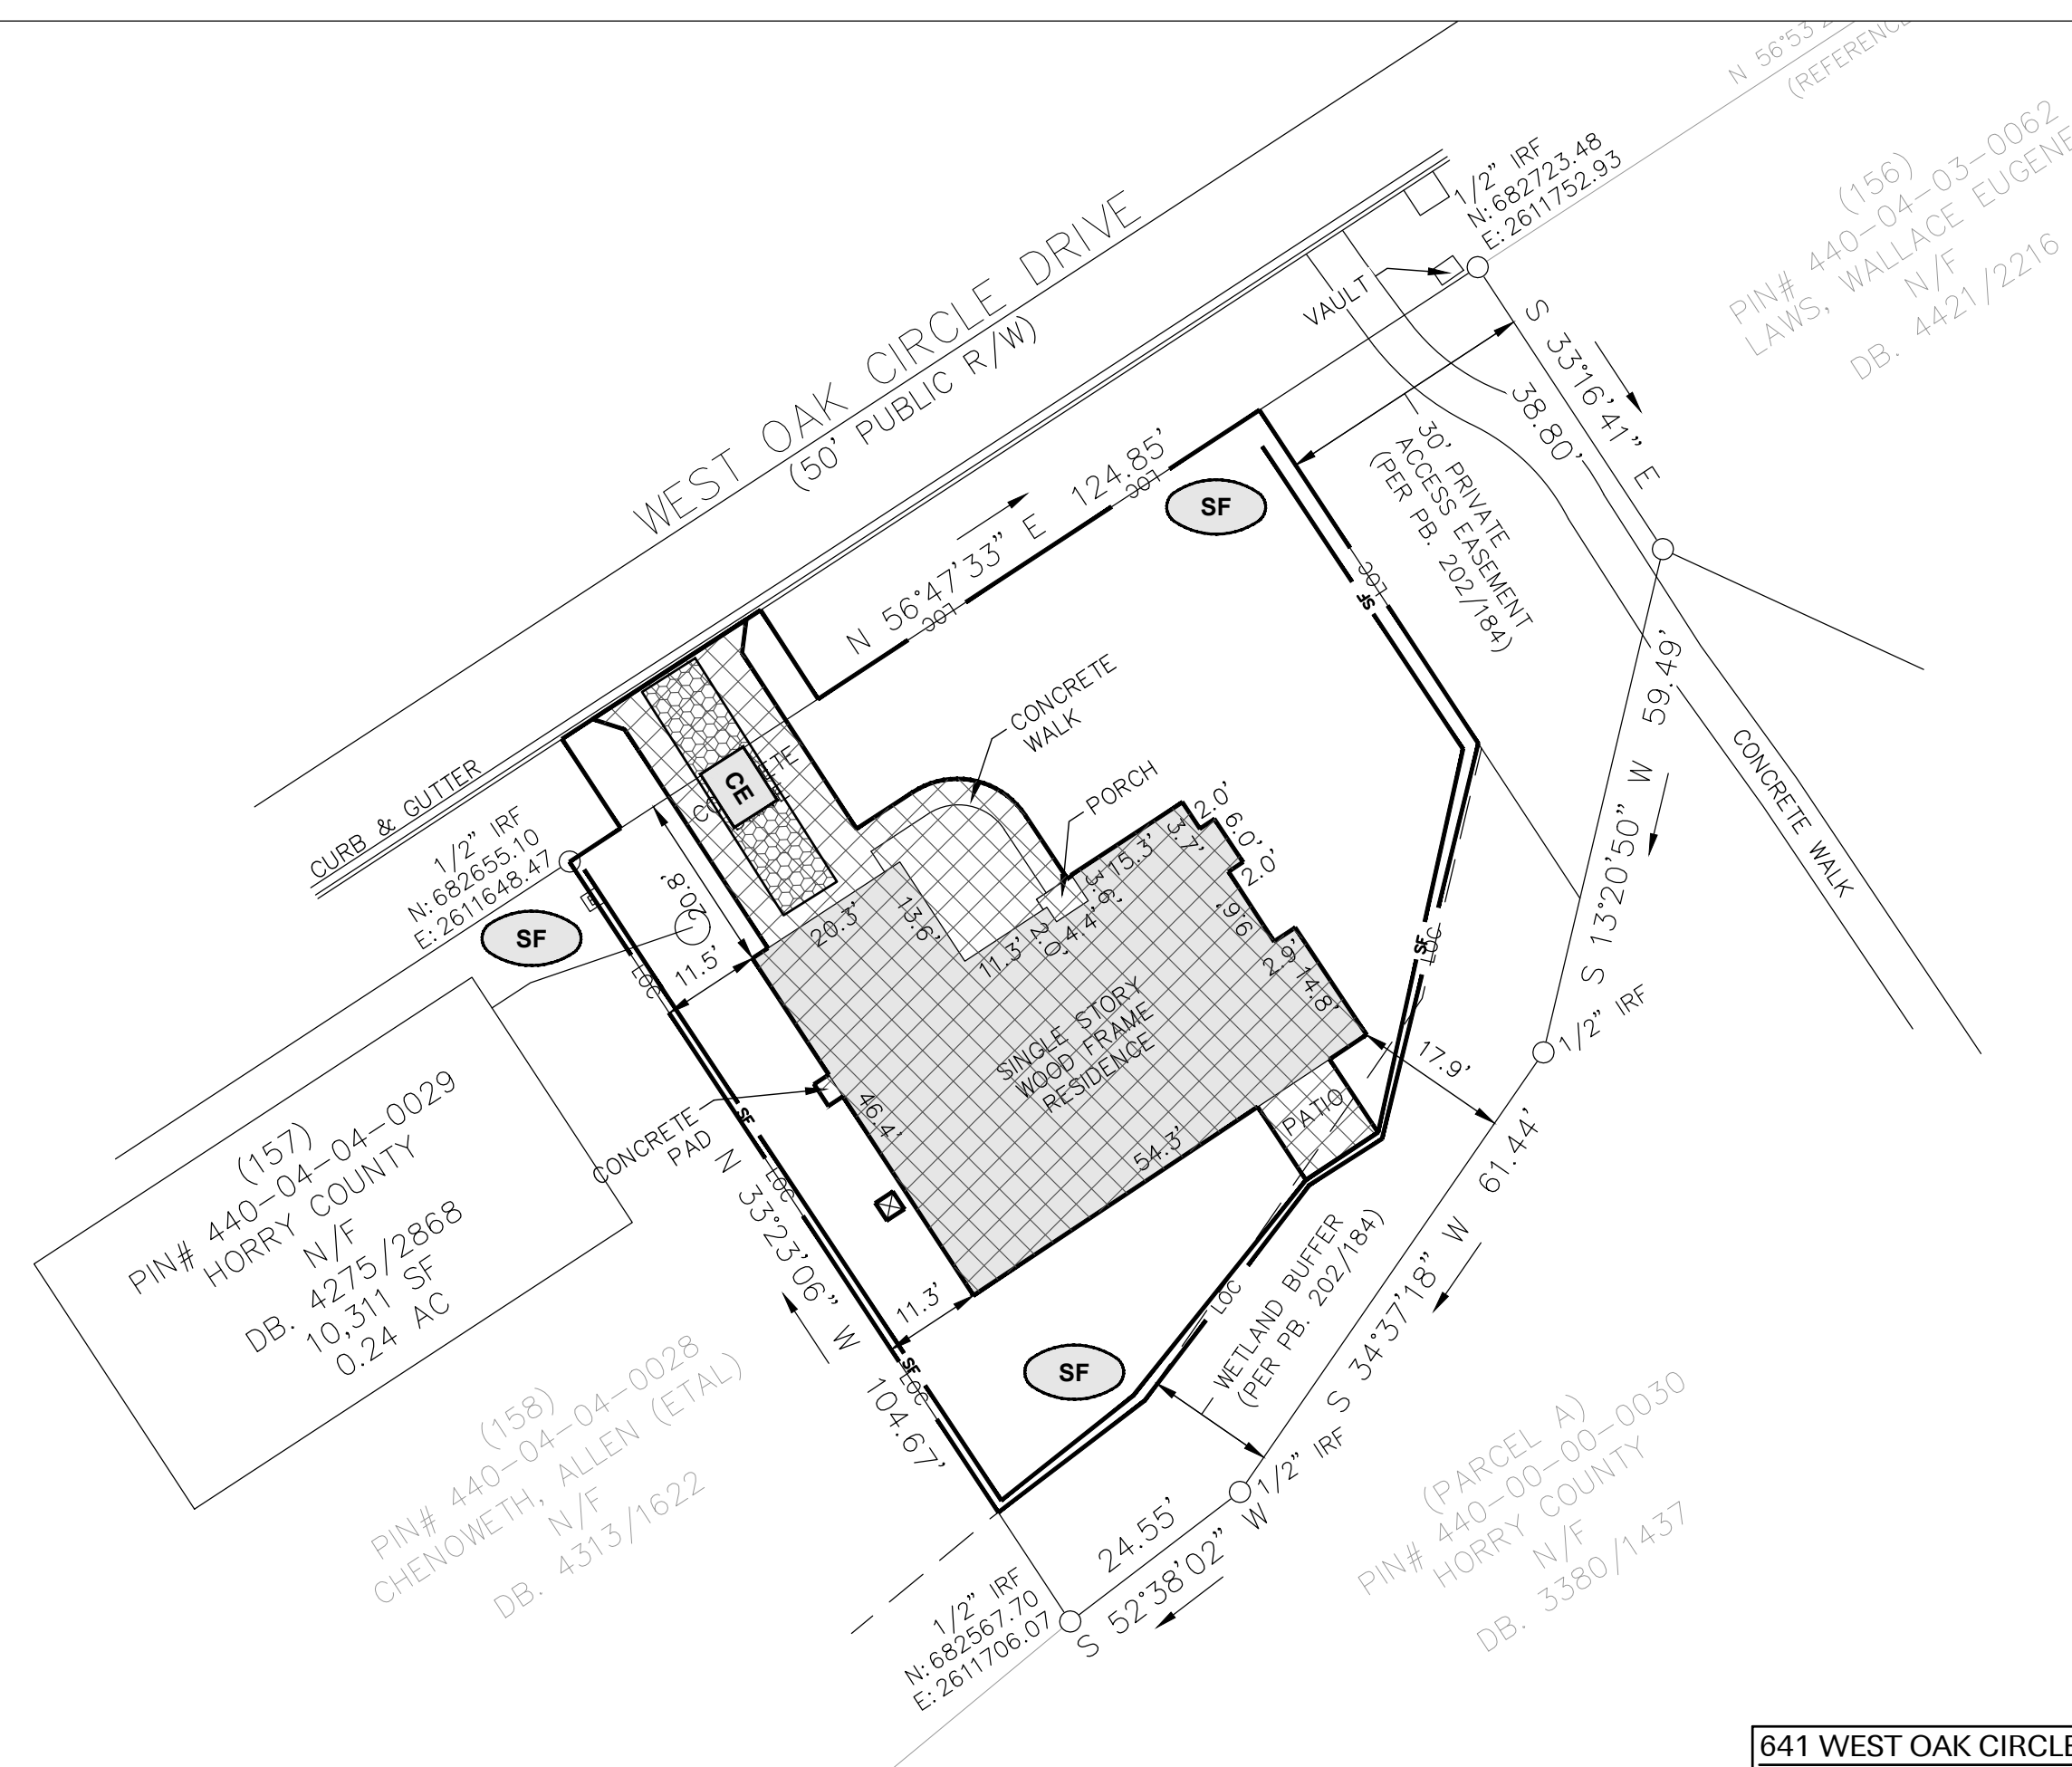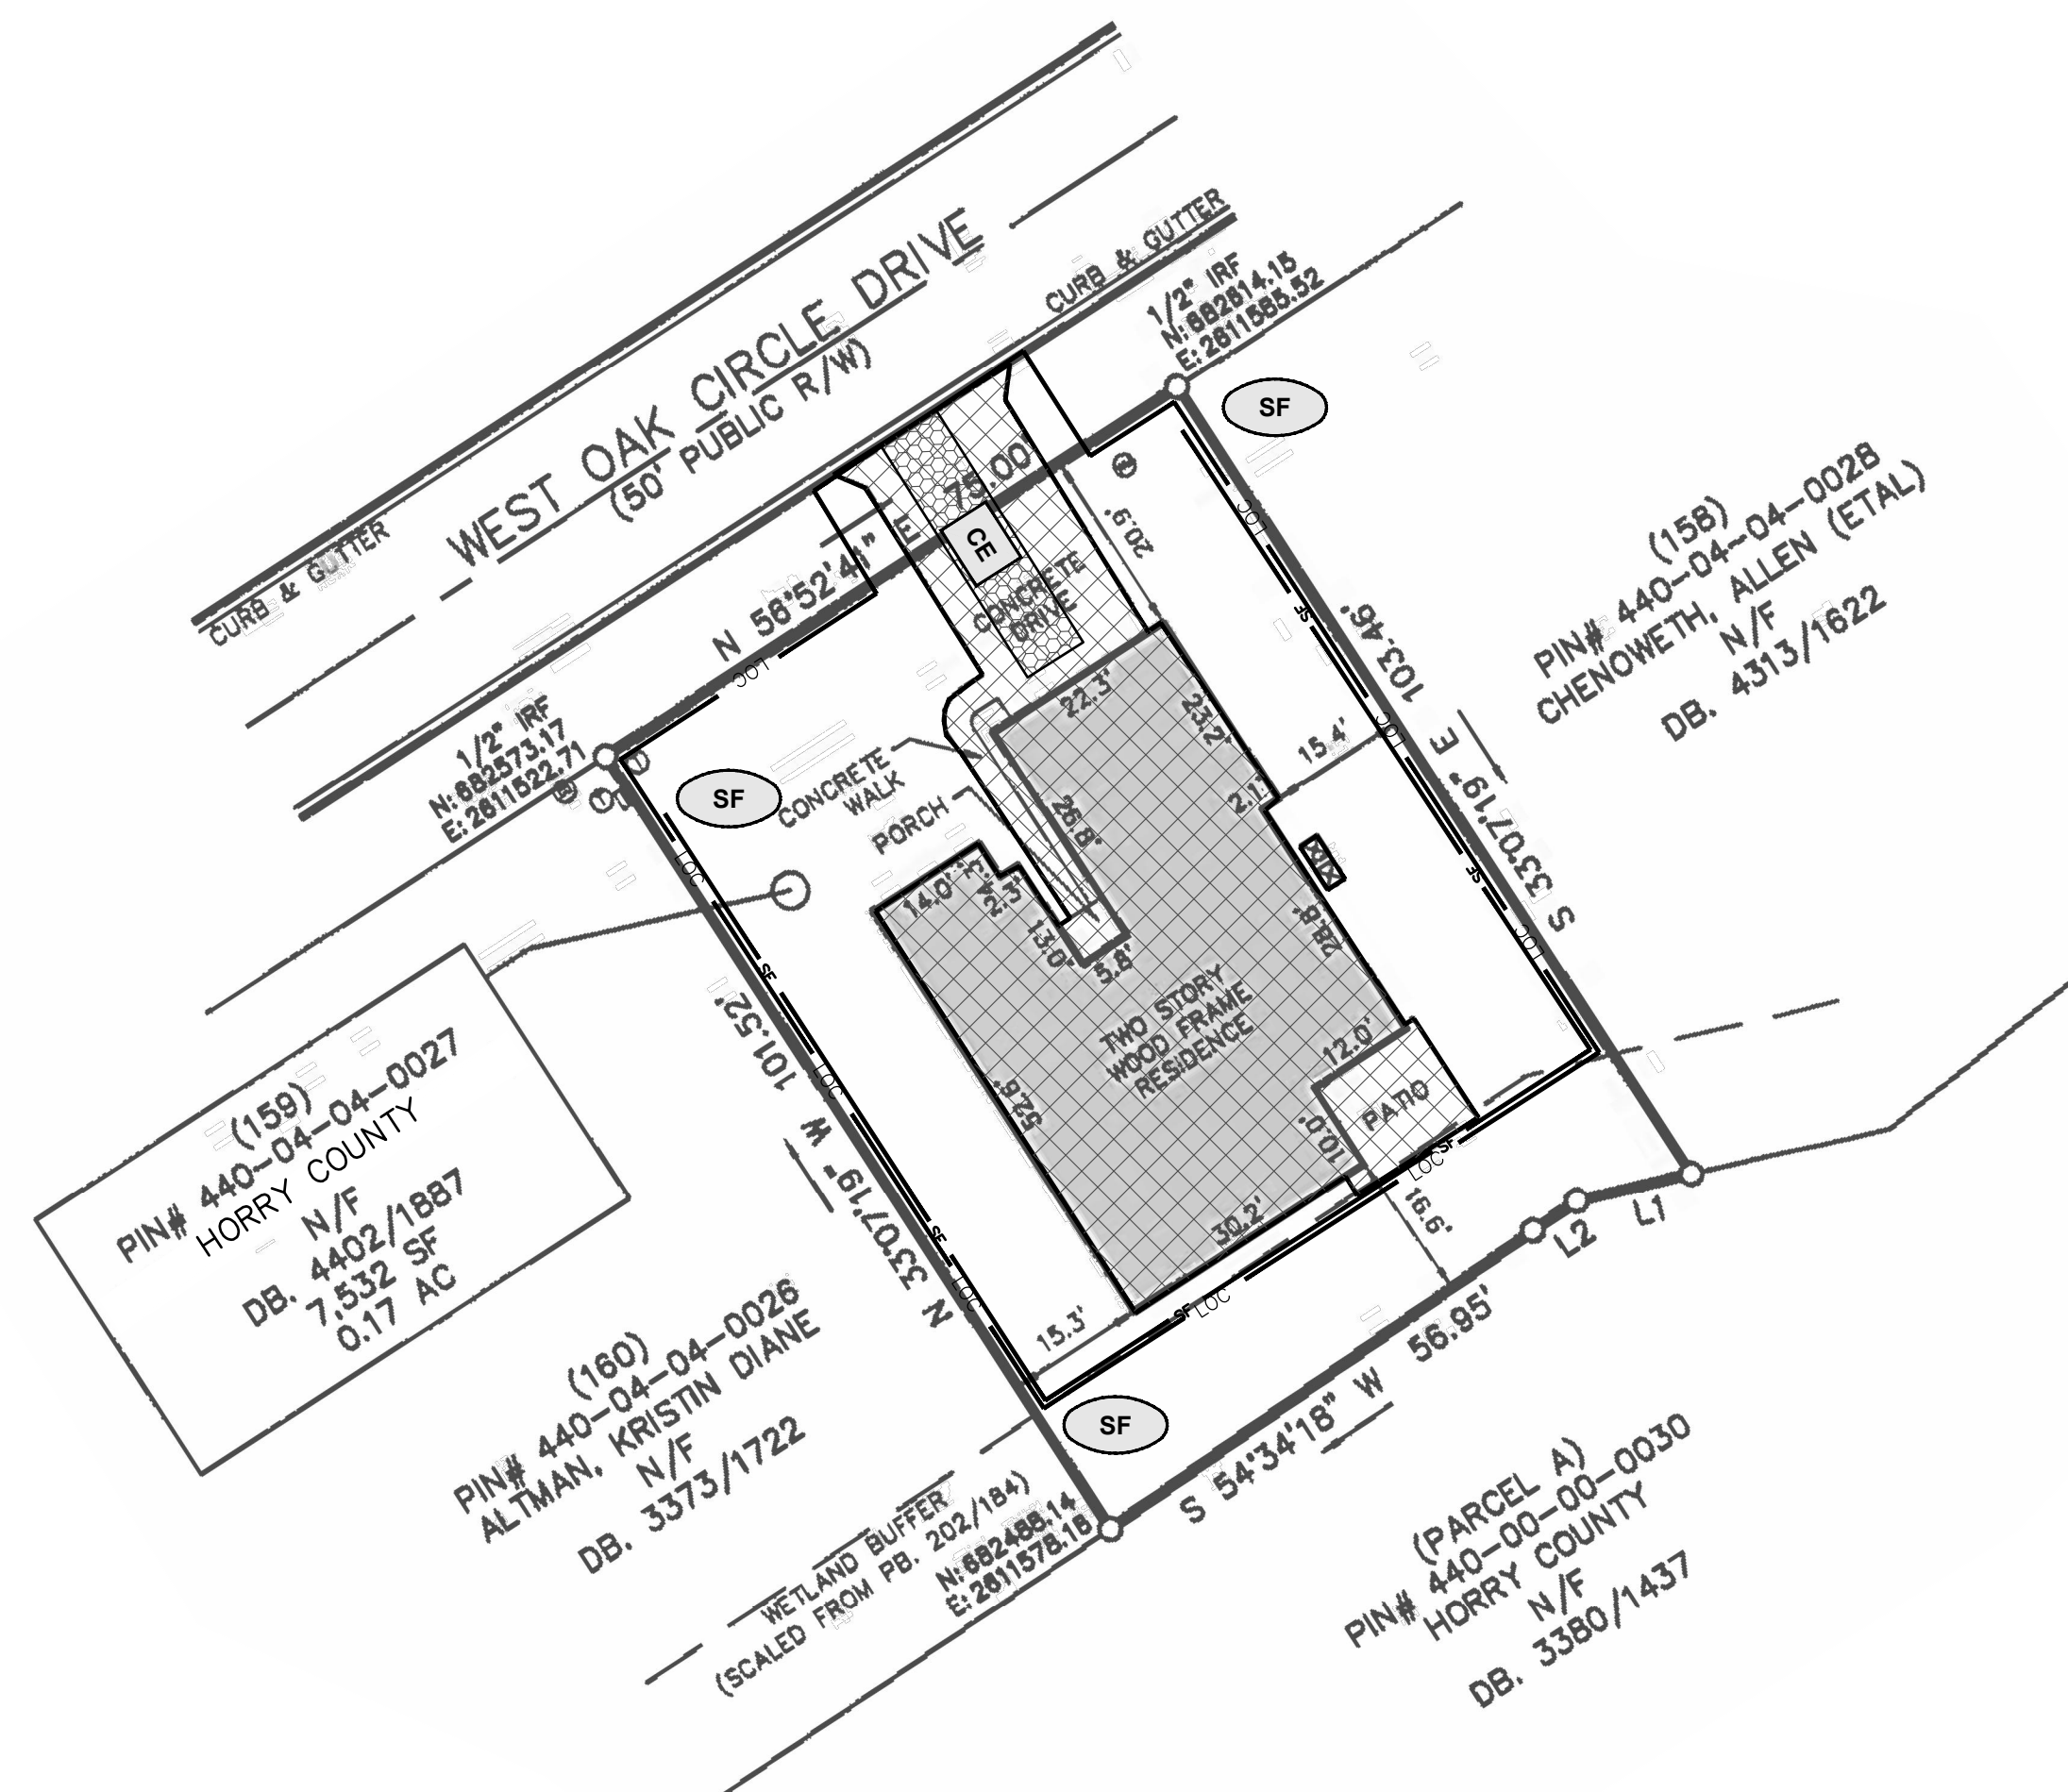


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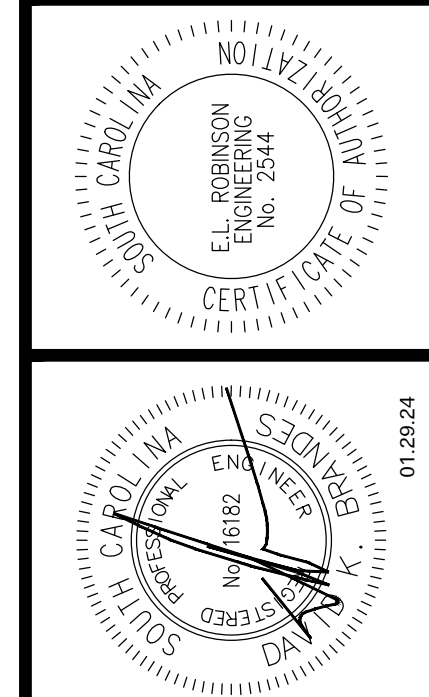
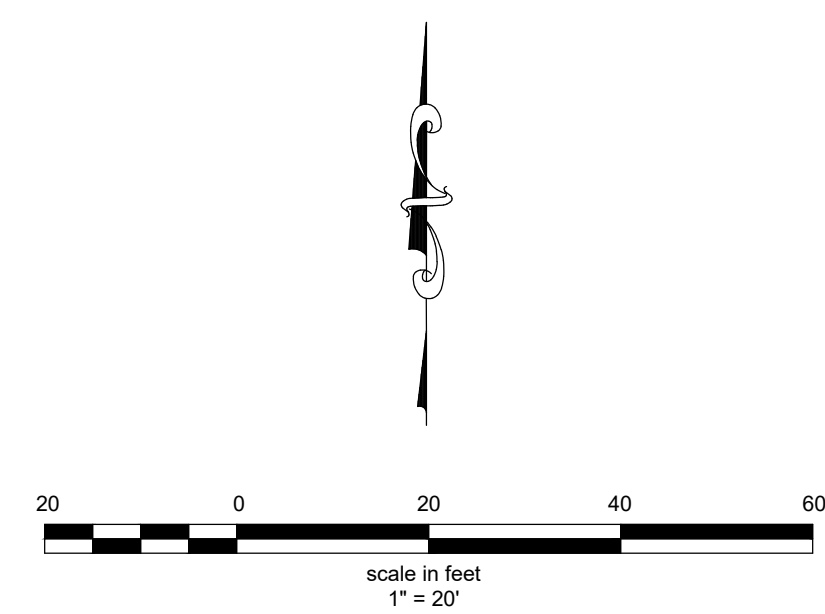
—LOC—	LIMITS OF DISTURBANCE
—SF—	SILT FENCE
	
	TEMPORARY CONSTRUCTION ENTRANCE/EXIT
	INLET PROTECTION DET. A
	INLET PROTECTION DET. E
	SEDIMENT TUBES
X	ITEMS TO BE DEMOLISHED
	GENERAL DEMOLITION AREA





LEGEND

	LIMITS OF DISTURBANCE
	SILT FENCE
	
	TEMPORARY CONSTRUCTION ENTRANCE/EXIT
	INLET PROTECTION DET. A
	INLET PROTECTION DET. E
	SEDIMENT TUBES
	ITEMS TO BE DEMOLISHED
	GENERAL DEMOLITION AREA




Project Title / Client Information

**HORRY COUNTY BUYOUT
DEMOLITION PLAN - PHASE 2S**

SOUTH CAROLINA OFFICE OF RESILIENCE
HORRY COUNTY, SOUTH CAROLINA

Drawing Title		Drawing Information		Revisions		P	
<h1 style="text-align: center;">DEMOLITION PLAN - PHASE 2</h1>		Project No. D30-N027-M1		No.	Name	Date	
		Drawn By CWS					
		Date 09.08.23					
		Checked By DNB					
		Date 09.08.23					
		Approved By DNB					

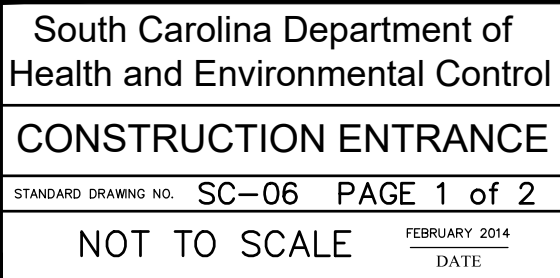

- ## CONSTR. ENTRANCE – INSPECTION & MAINTENANCE
1. The key to functional construction entrances is weekly inspections, routine maintenance, and regular sediment removal.
 2. Regular inspections of construction entrances should be conducted once every calendar week and, as recommended, within 24 hours after each rainfall event that produces 1/2-inch or more of precipitation.
 3. During regular inspections, check for mud and sediment buildup and pad integrity. Inspection frequencies may need to be more frequent during long periods of wet weather.
 4. Reshape the stone pad as necessary for drainage and runoff control.
 5. Wash or replace stones as needed and as directed by site inspector. The stone in the entrance should be washed or replaced if the sediment buildup is so great that the amount of mud being carried off-site by vehicles. Frequent washing will extend the useful life of stone pad.
 6. Immediately remove mud and sediment tracked or washed onto adjacent impervious surfaces by brushing or sweeping. Flushing should be used when the water can be discharged to a sediment trap or basin.
 7. During maintenance activities, any broken pavement should be repaired immediately.
 8. Construction entrances should be removed after the site has reached final stabilization. Permanent vegetation should replace areas from which construction entrances have been removed, unless one will be converted to an impervious surface to serve post-construction.

2. Regular inspections of construction entrances shall be conducted once every calendar week and, as recommended, within 24 hours after any rainfall event that produces 1/2-inch or more of precipitation.
3. During regular inspections, check for mud and sediment buildup and pad integrity. Inspection frequencies may need to be more frequent during long periods of wet weather.
4. Reshape the stone pad as necessary for drainage and runoff control.
5. Wash or replace stones as needed and as directed by site inspectors. The stone in the entrance should be washed or replaced whenever the entrance fails to reduce the amount of mud being carried off-site by vehicles. Frequent washing will extend the useful life of the entrance.
6. Immediately remove mud and sediment tracked or washed onto adjacent impervious surfaces by brushing or sweeping. Flushing should only be used when the water can be discharged to a sediment trap or basin.
7. During maintenance activities, any broken pavement should be repaired immediately.
8. Replacement vegetation should be removed after the site has reached stabilization. Permanent vegetation should replace areas from which construction entrances have been removed, unless area will be converted to an impervious surface to serve another purpose.

STANDARD DRAWING NO. SC-06 PAGE 2 of 2	
GENERAL NOTES	FEBRUARY 2014 DATE


- ing products with significant potential for impact (such as construction chemicals that could be exposed to storm water runoff) and to identify and eliminate the pollutant source in storm water discharges.

- ment and vehicle washing, wheel wash water, and
in a sediment basin or alternative control that
discharge;

- must be conducted at a minimum of at least once every
stabilization is reached on all areas of the

- each construction site with an approved On-Site
on activities. For non-linear projects that disturb 10
ite unless the Department has approved otherwise.

SCDHEC - SEDIMENT AND EROSION CONTROL NOTES

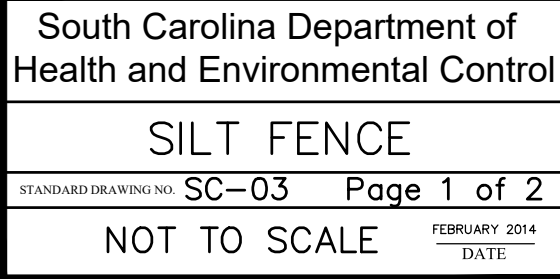

- ## SILT FENCE— FABRIC REQUIREMENTS
1. **Silt fence must be composed of woven geotextile filter fabric that consists of the following requirements:**
 - Composed of fibers consisting of low chain synthetic polymers of at least 85% by weight of polyolefins, polyesters, or polyamides that are formed into a network such that the filaments or yarns retain dimensional stability relative to each other;
 - Free of any treatment or coating which might adversely alter its physical properties after installation;
 - Free of any defects or flaws that significantly affect its physical and/or filtering properties; and,
 - Have a minimum width of 36-inches.

- | | |
|--|-----------------------|
| South Carolina Department of
Health and Environmental Control | |
| SILT FENCE | |
| STANDARD DRAWING NO. SC-03 | PAGE 2 of 2 |
| GENERAL NOTES | FEBRUARY 2014
DATE |









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| SILT FENCE | |
| STANDARD DRAWING NO. SC-03 | PAGE 2 of 2 |
| GENERAL NOTES | FEBRUARY 2014
DATE |

DEMOLITION NOTES

SEEDING SCHEDULE FOR PERMANENT VEGETATION				
PLOT NO.	COMMON NAME OF SEED	RURAL RATE	URBAN RATE ¹	PLANTING PERIOD
3 ⁴	COMMON BERMUDA (HULLED ²)	20	20	MARCH TO AUGUST
	CARPET GRASS	9	9	
4 ⁴	COMMON BERMUDA (UNHULLED ²)	20	20	AUGUST TO FEBRUARY
	RYE GRAIN	20	20	

1. INCLUDES RURAL AREAS ADJACENT TO WELL-DEVELOPED LAWN.
2. NOT REQUIRED ON SHOULDERS, MEDIANS, ETC., AND SLOPES UNDER 5 FEET IN HEIGHT.
3. GIANT BERMUDA SEED, INCLUDING NK-37, SHALL NOT BE USED
4. RESEEDING CRIMSON CLOVER SHALL BE INOCULATED IN ACCORDANCE WITH SUBSECTION 810.05. DO NOT PLANT CLOVER IN MEDIANS OR IN RURAL AREAS ADJACENT TO WELL-DEVELOPED LAWN.

SEEDING SCHEDULE

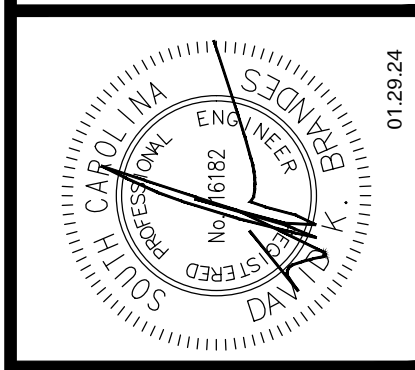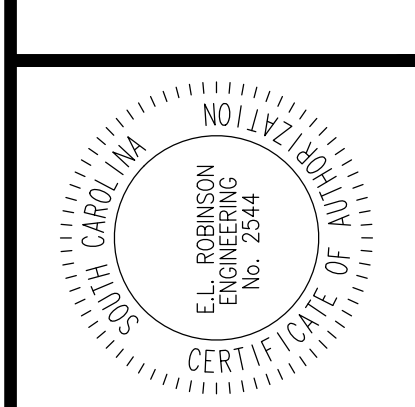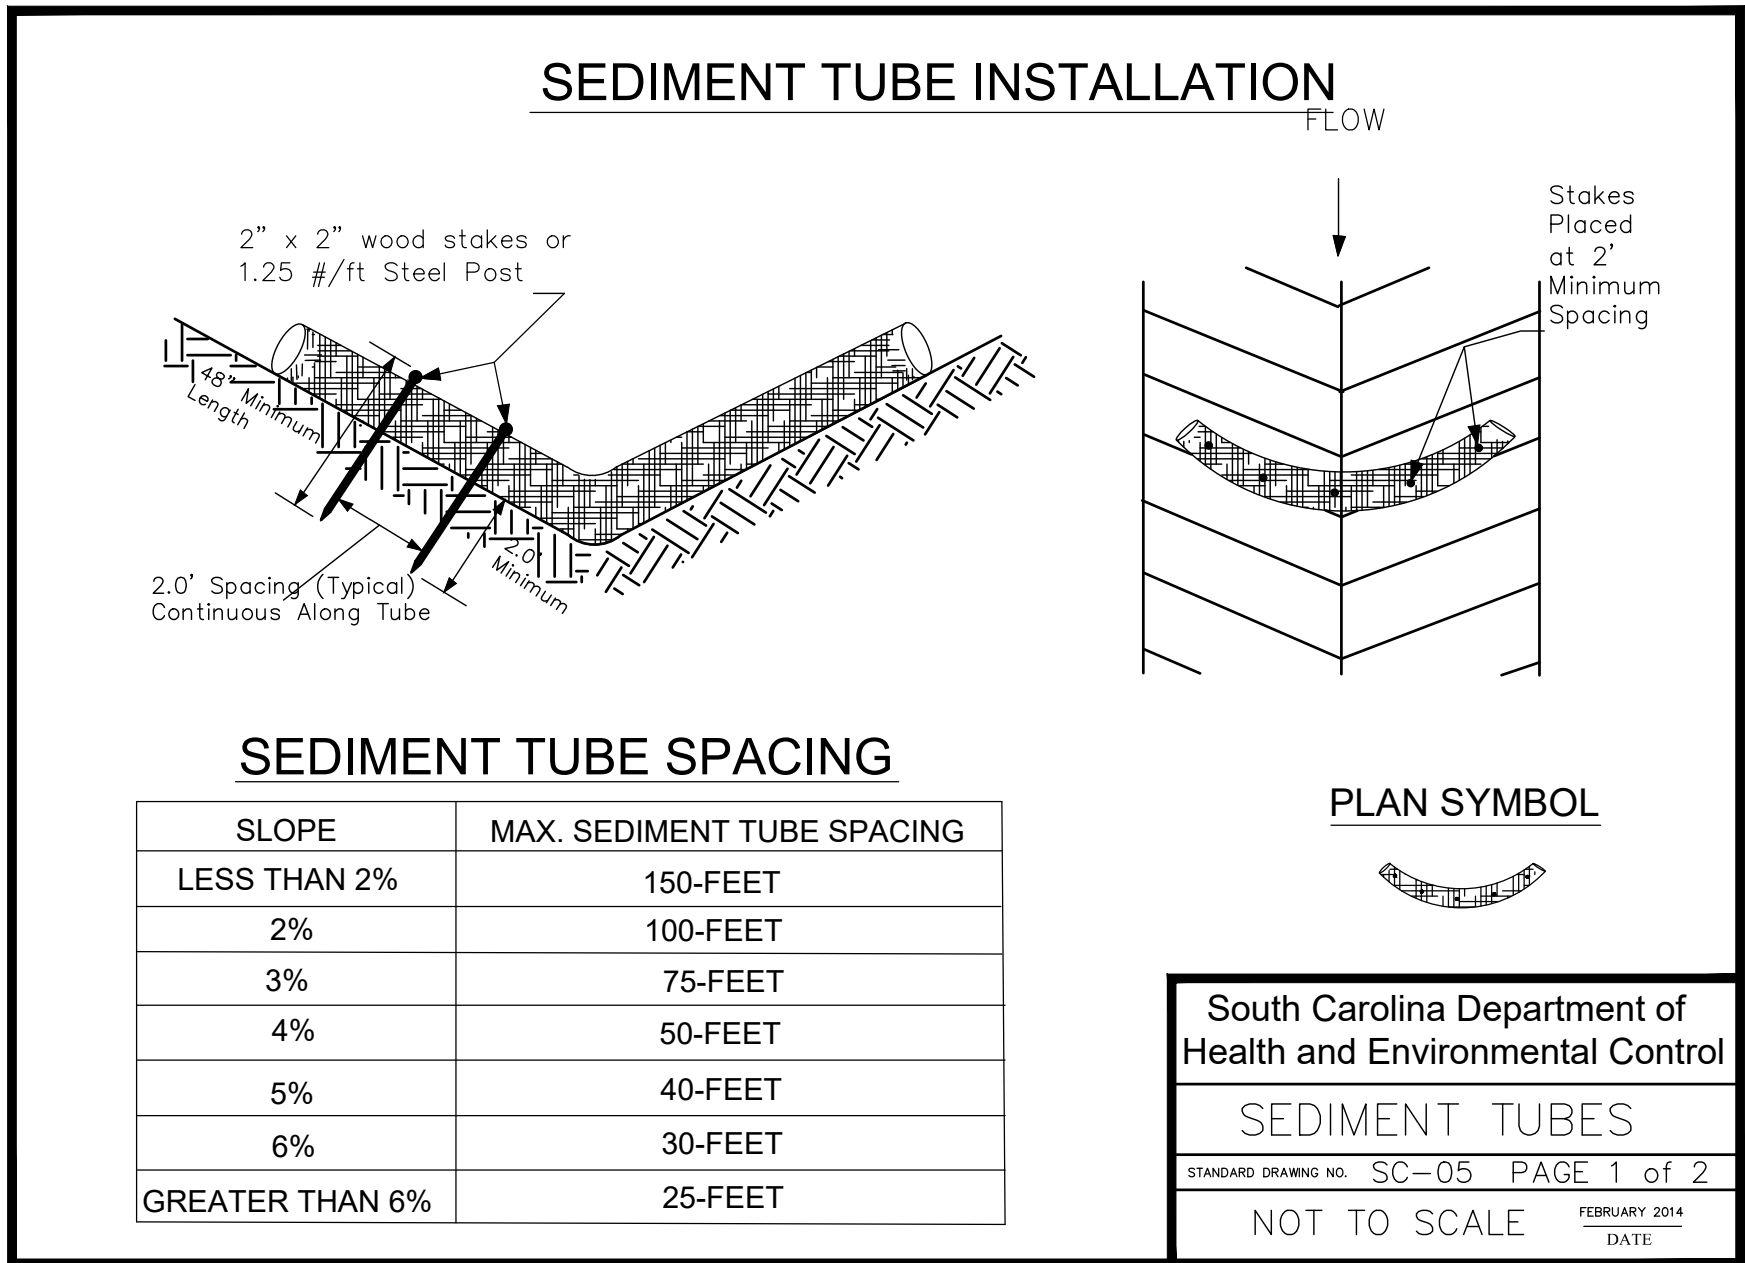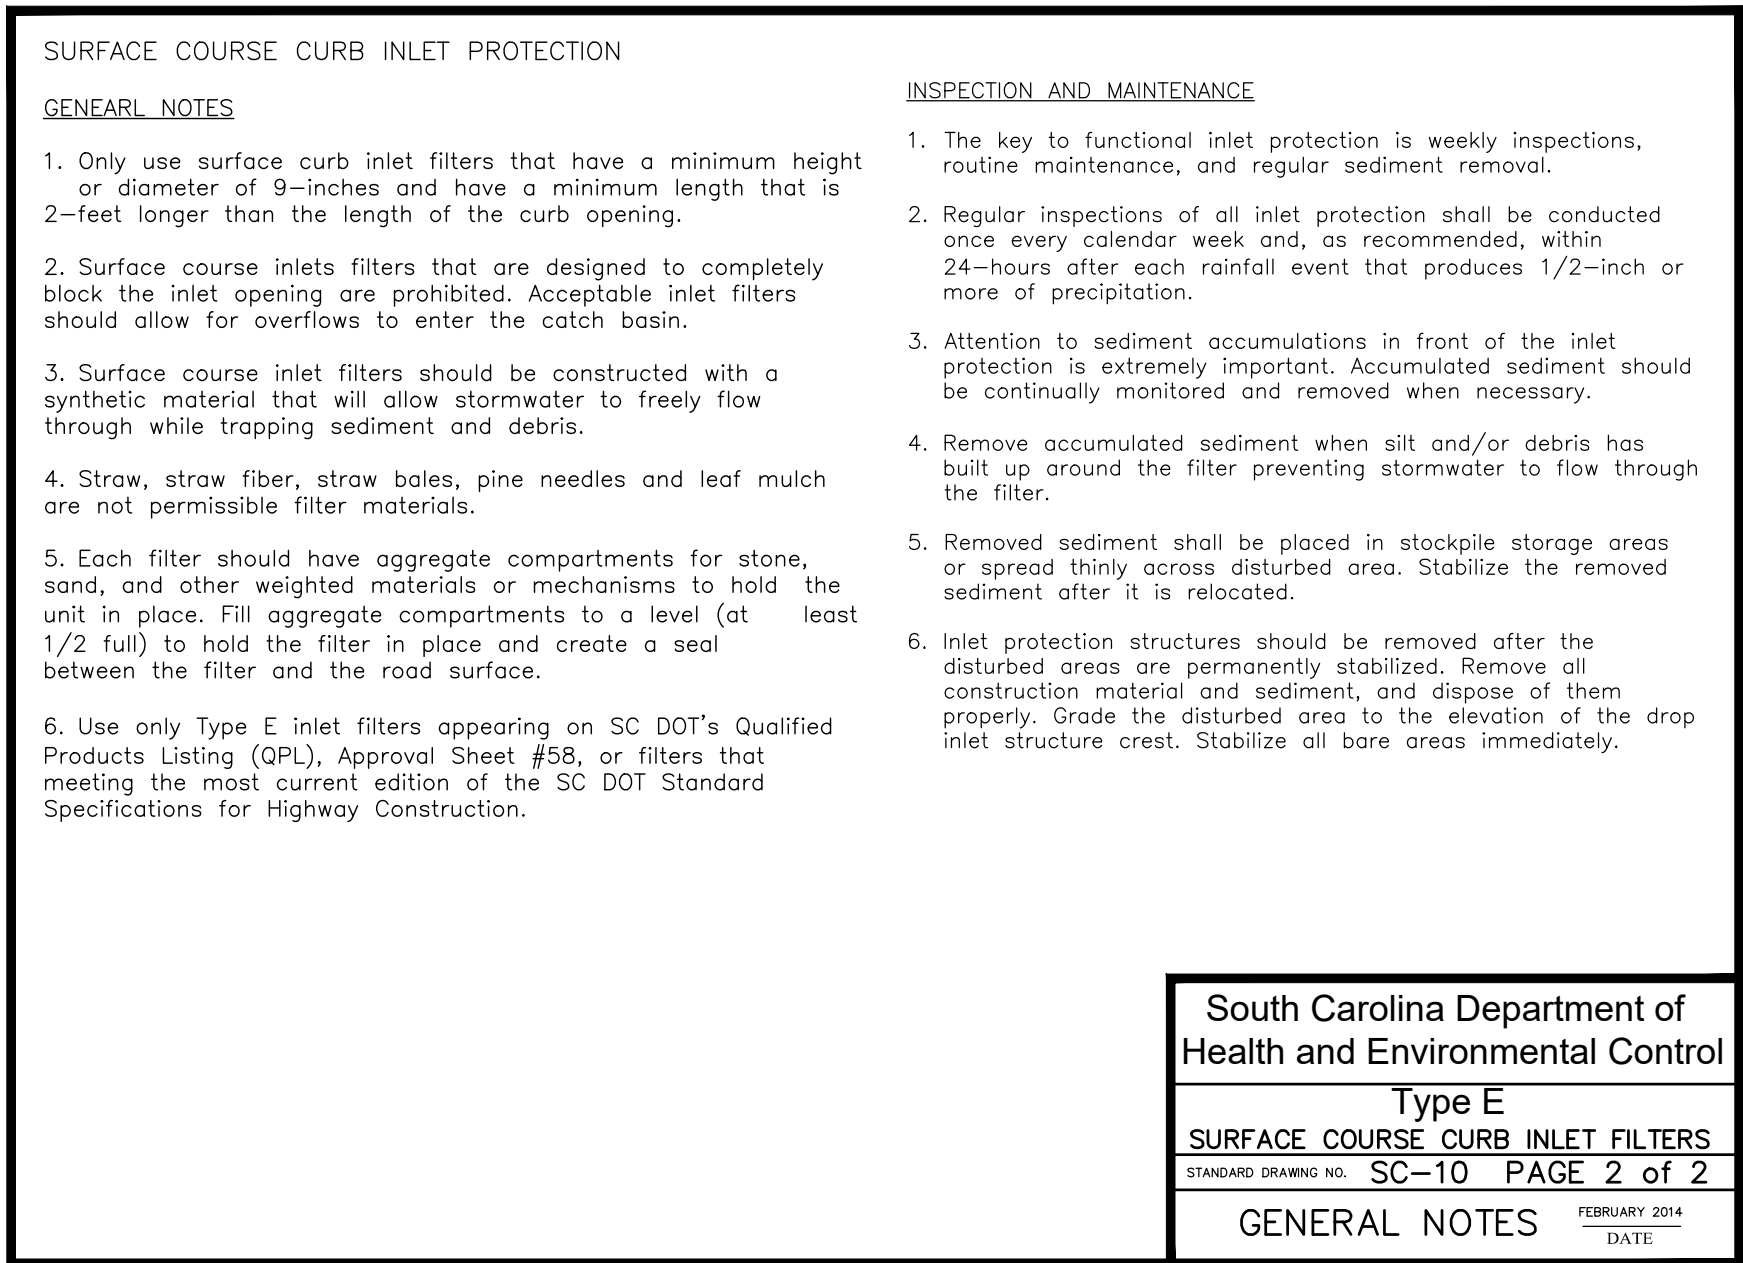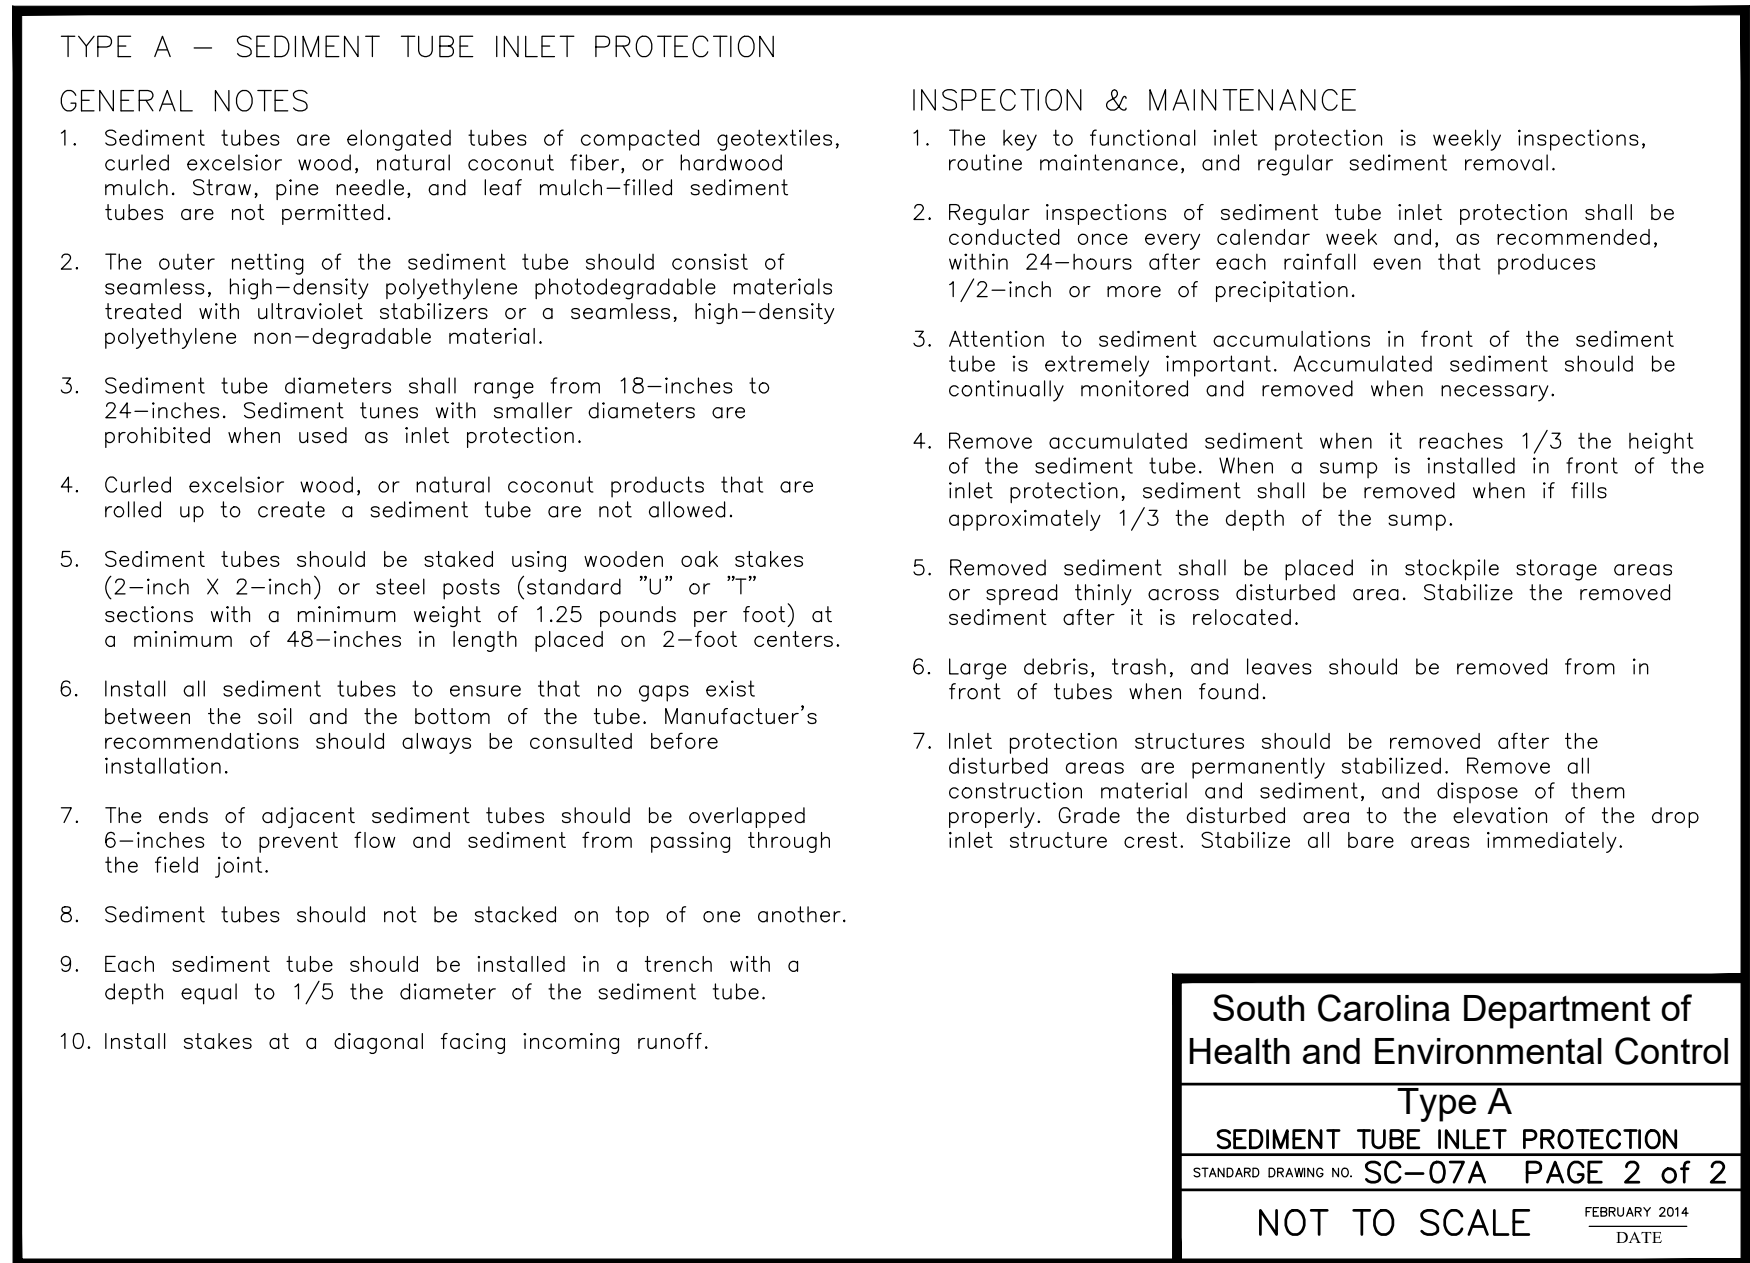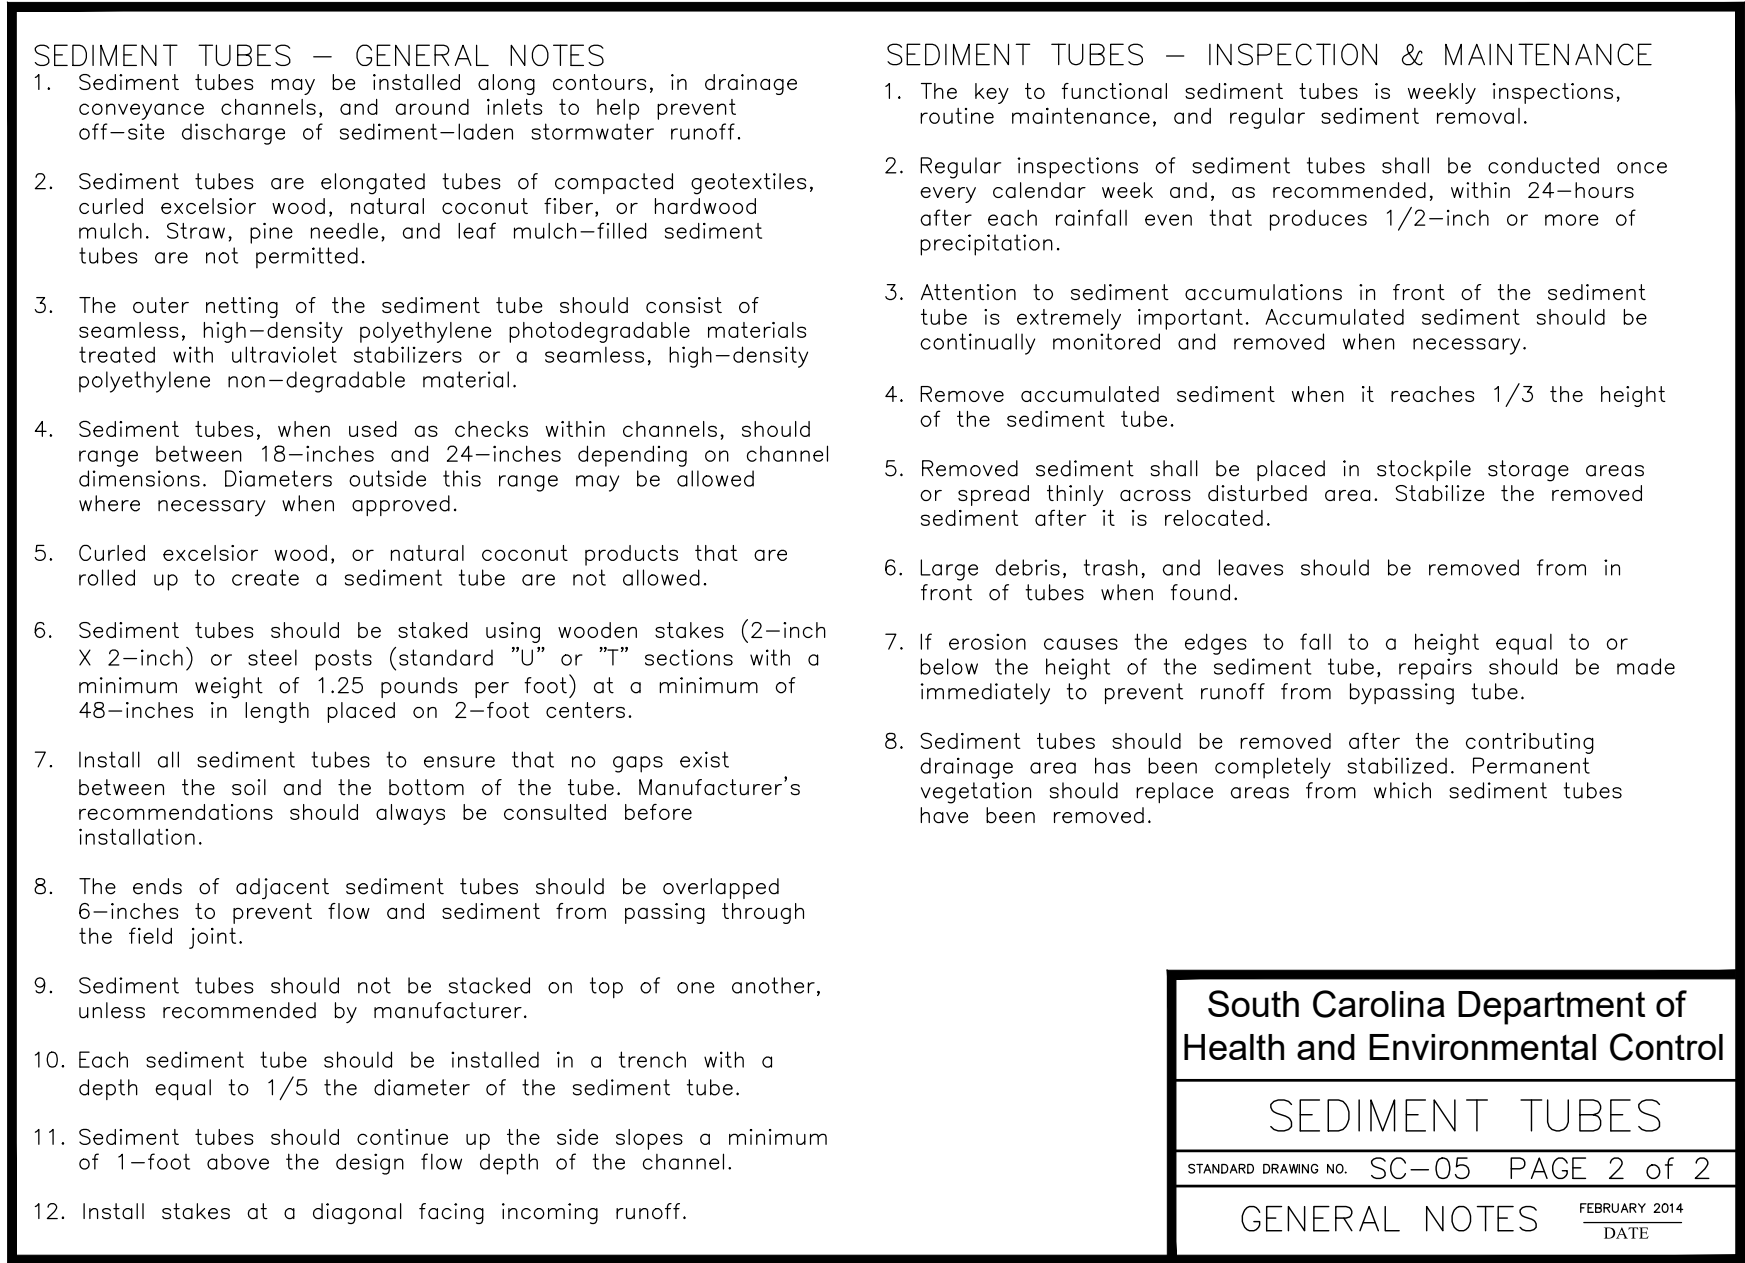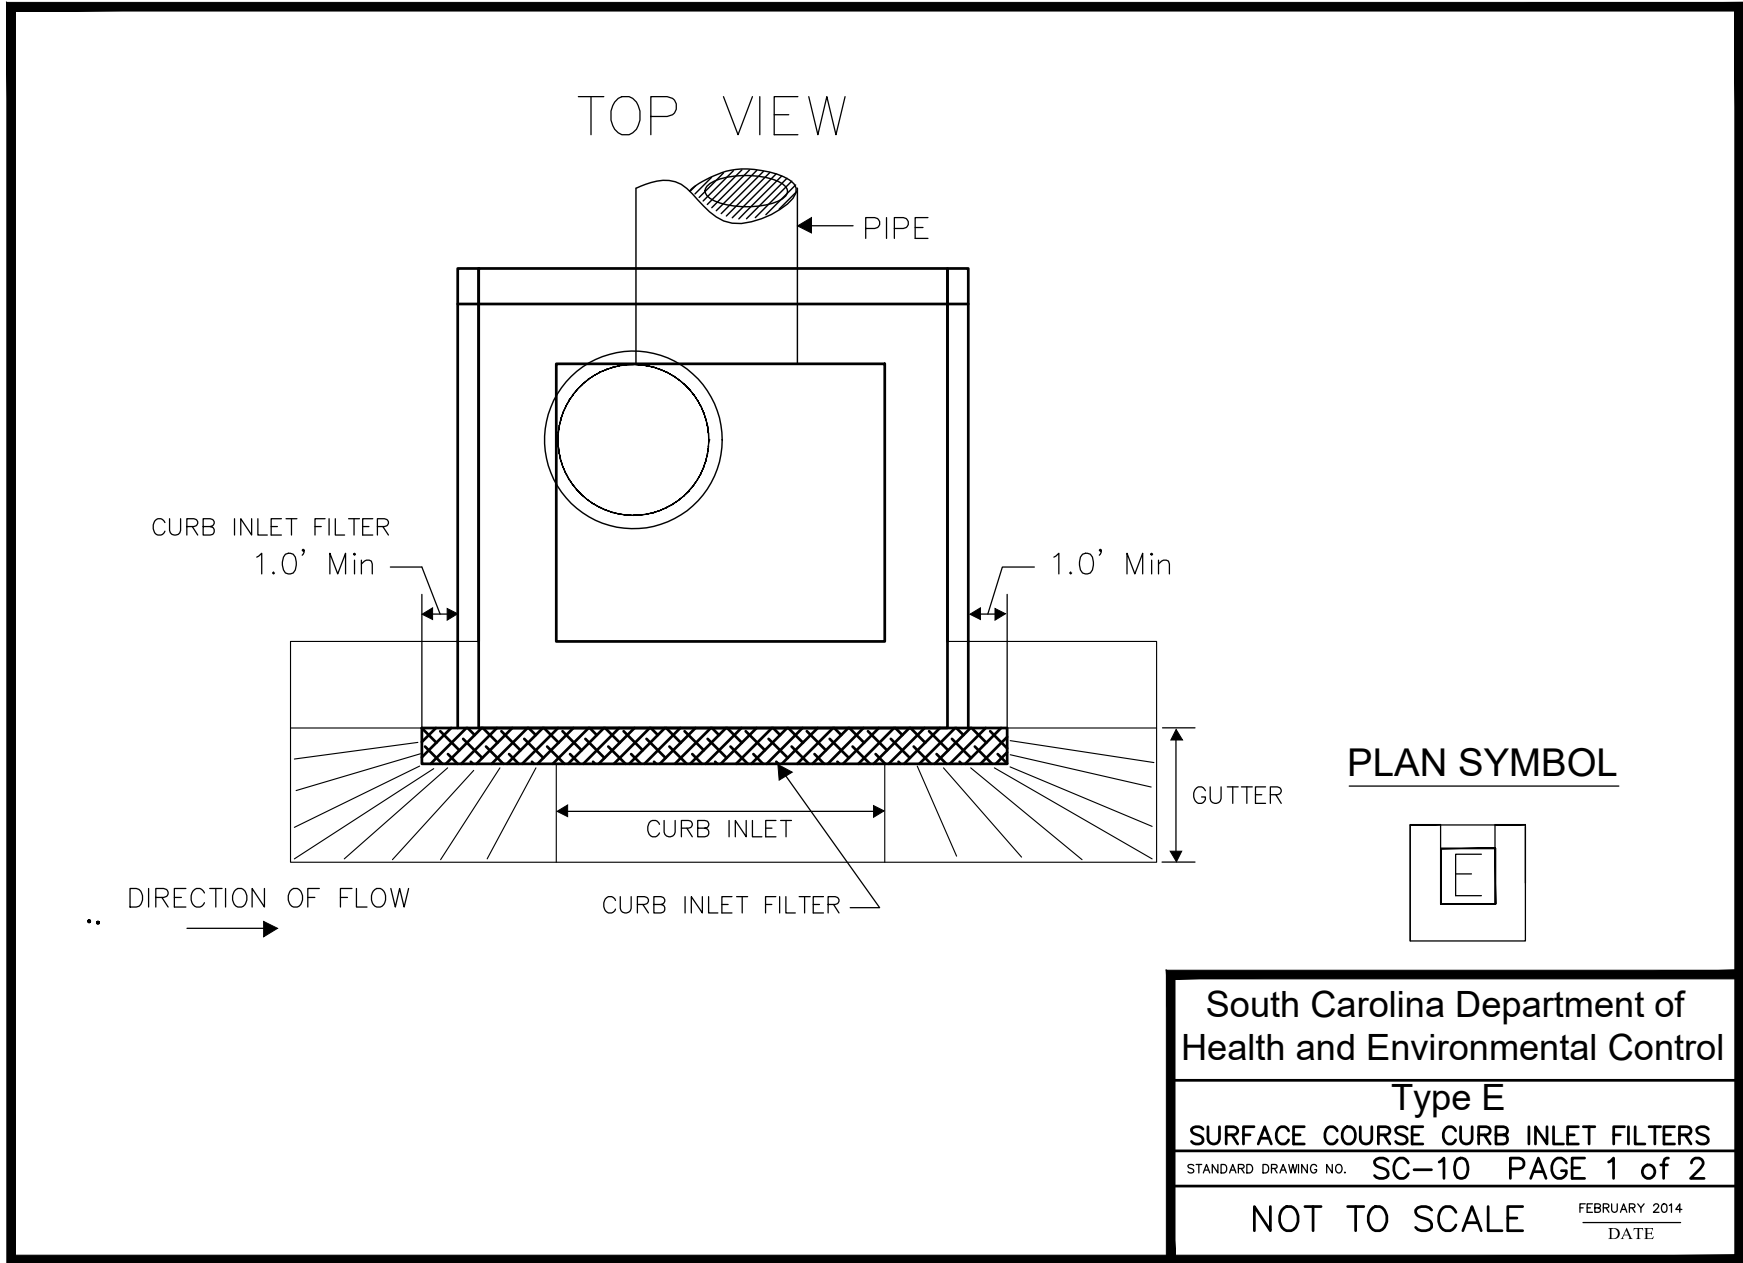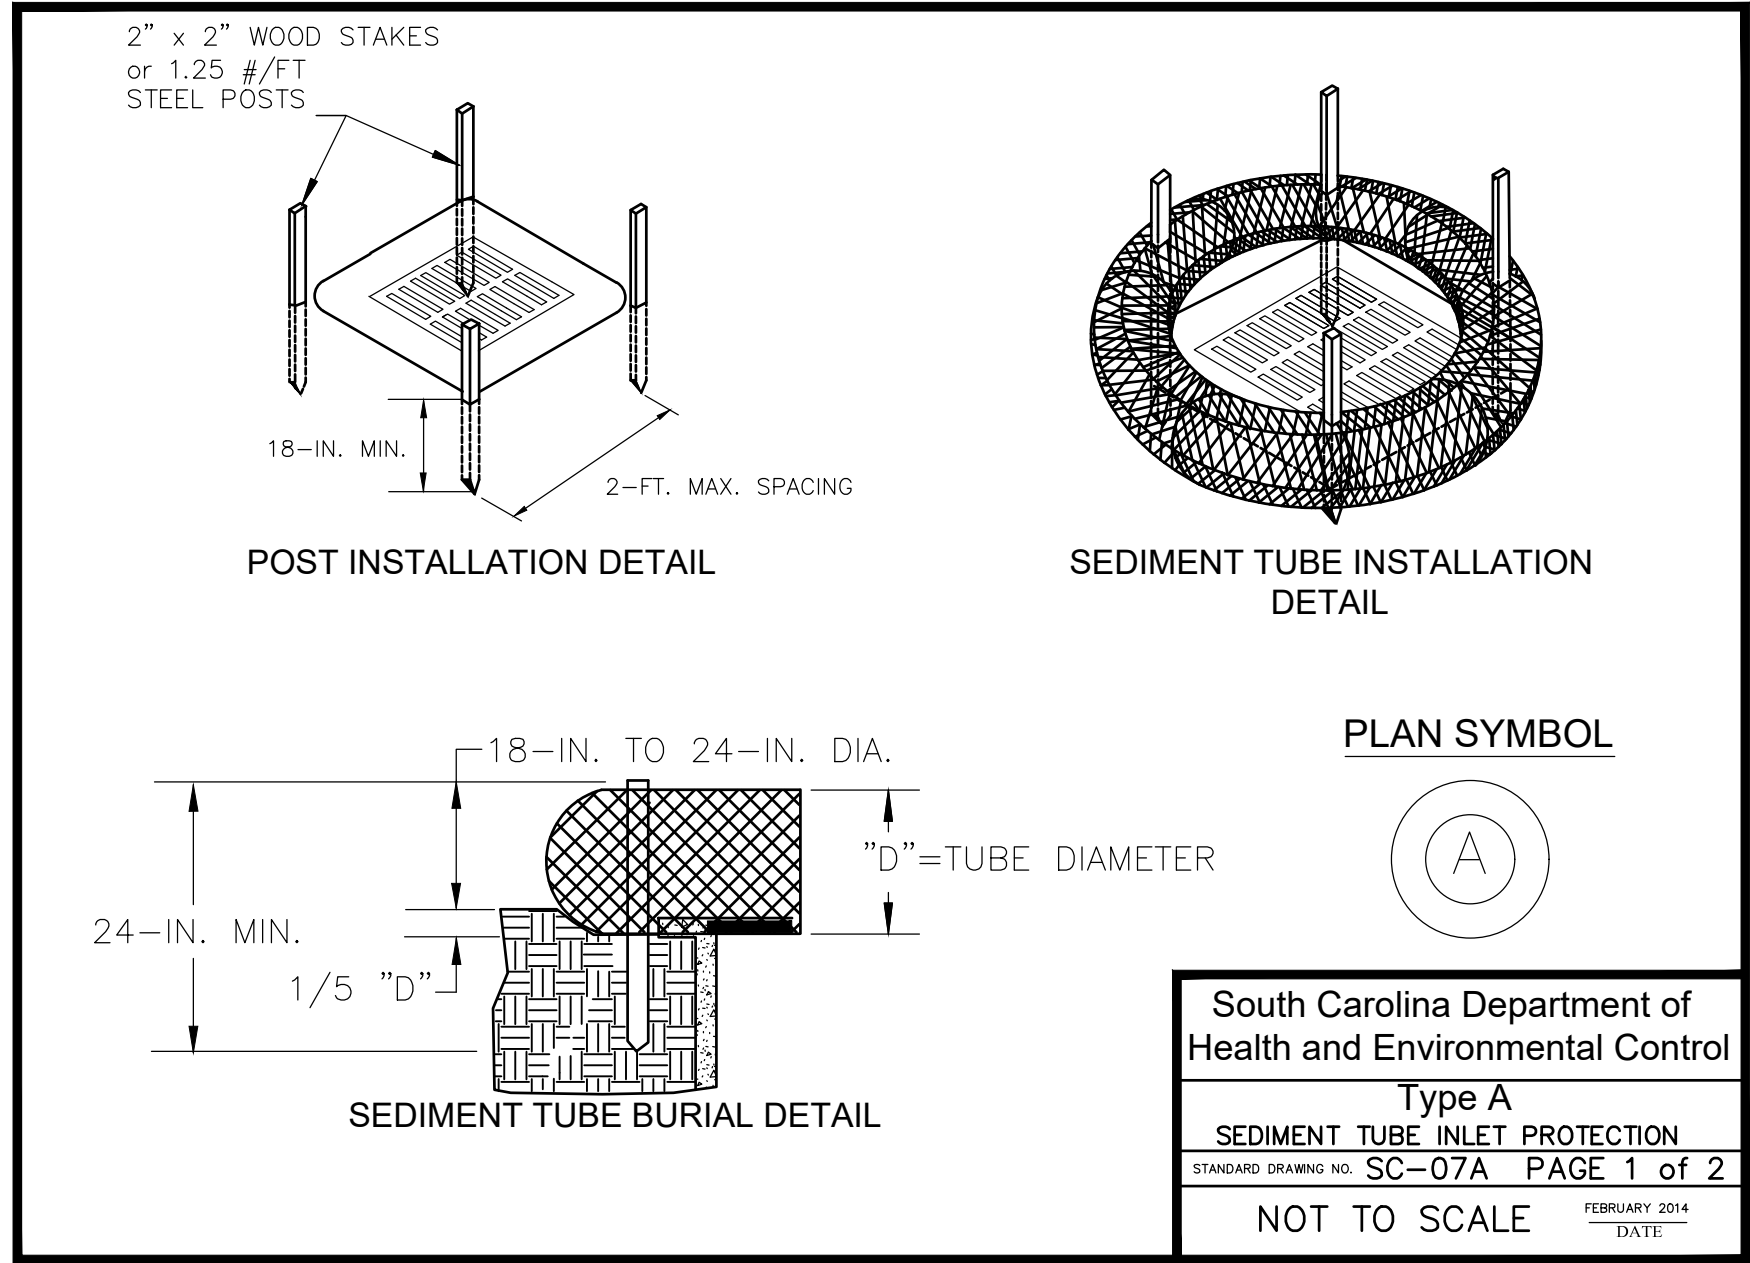

Revisions	No.	Name	Date

Project No. 030-ND27-M	Drawn By CWS	Date 09.08.23	Checked By DDB	Date 09.08.23	Approved By DDB
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